



KEYNOTES:

- PROPOSED LOCATION OF UTILITY TRANSFORMER. COORDINATE EXACT LOCATION OF TRANSFORMER WITH UTILITY COMPANY PRIOR TO BID, AND INCLUDE IN BID ANY AND ALL COSTS ASSOCIATED WITH INSTALLATION AND CONNECTION OF SERVICE.
- 2 EMERGENCY GENERATOR. SEE SHEET E1.1.
- PROVIDE TAMPER SWITCH AT POST INDICATOR VALVE. ROUTE FIRE ALARM CABLING IN 1" CONDUIT TO FIRE ALARM CONTROL PANEL. PROVIDE MONITOR MODULE INSIDE OF THE BUILDING IN A CLEARLY MARKED BOX ABOVE THE CEILING. COORDINATE LOCATION OF POST INDICATOR VALVE WITH CIVIL PLANS PRIOR TO ROUGH—IN.
- CIRCUIT FOR GRADE MOUNTED FLOOD LIGHTING OF FLAG POLE. EXTEND TO BUILDING MOUNTED LIGHTING FIXTURES. SEE SHEET E1.1.
- 5 PROVIDE A GFI OUTLET WITH WEATHER PROOF COVER IN THE POLE BASE DEVICE BOX.
- 6 ROUTE (2) 2"EC WITH PULL WIRES FOR DATA AND CATV FROM THE TELEPHONE BACKBOARD IN THE MECHANICAL/ELECTRICAL ROOM TO THE PROPERTY LINE FOR USE BY THE UTILITY COMPANIES. COORDINATE STUB UP LOCATION AND TERMINATION REQUIREMENTS WITH THE UTILITY COMPANIES PRIOR TO ROUGH-IN.
- ROUTE (2) 4"EC WITH PULL WIRES FOR TELEPHONE SERVICE FROM THE TELEPHONE BACKBOARD IN THE MECHANICAL/ELECTRICAL ROOM TO THE PROPERTY LINE FOR USE BY THE TELEPHONE COMPANY. COORDINATE STUB UP LOCATION AND TERMINATION REQUIREMENTS WITH THE PHONE COMPANY PRIOR TO ROUGH—IN.
- 8 ROUTE HOMERUN THROUGH EXTERIOR LIGHTING CONTACTOR INDICATED IN KEYNOTE 36, SHEET E1.1.
- 30A/1P/20AF SERVICE RATED DISCONNECT SWITCH.
- ROUTE #6 COPPER GROUND WIRE FROM THE GROUND LUG IN THE STORAGE BUILDING DISCONNECT SWITCH TO A 1/2" X 10' LONG COPPER CLAD GROUND ROD DRIVEN SO THAT THE TOP IS 24" BELOW GRADE. GROUND WIRE SHALL BE INSTALLED IN 3/4" GALVANIZED RIGID STEEL CONDUIT.

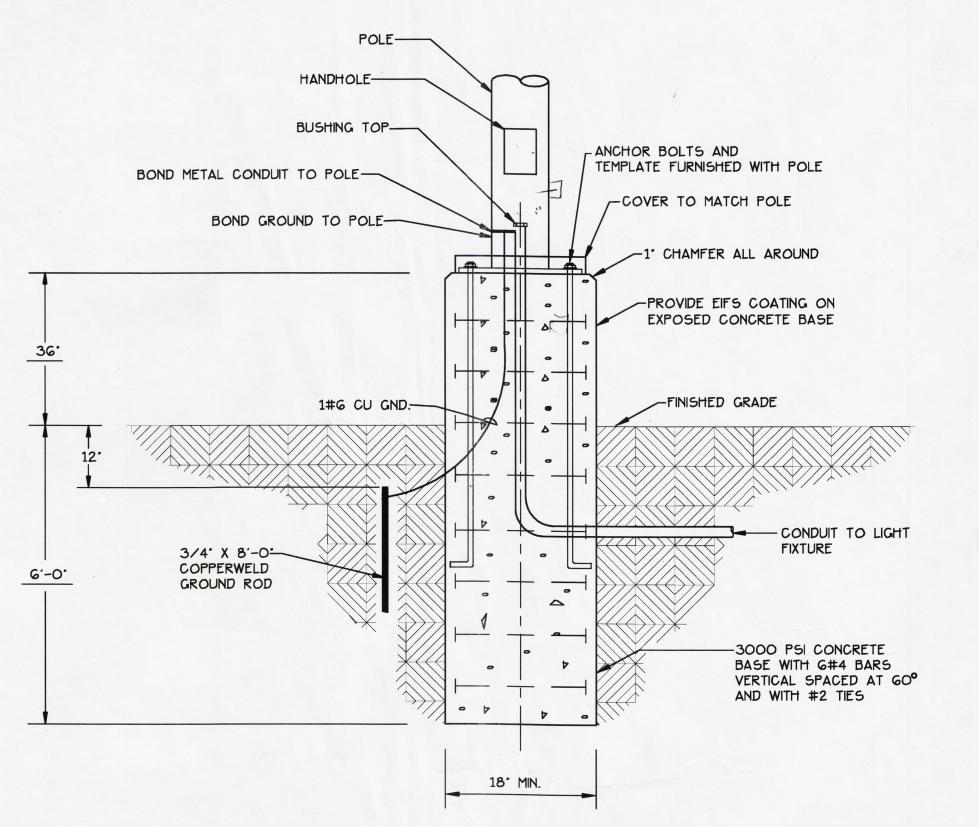

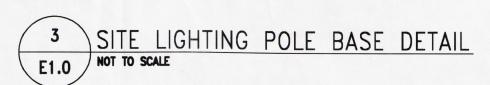






DEYOUNG EORGIA

HITECTS
TE CONGINE

ARCHITEC STREET, NE GEORGIA

625 GREEN GAINESVILL 30601

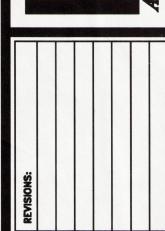

DESIGNED DRAWN CHEC

JOB NO.611 1078 03

SCALE: AS NOTED


No. 3

STATION NO.

F1 0

DRAWING NUMBER

OF WW

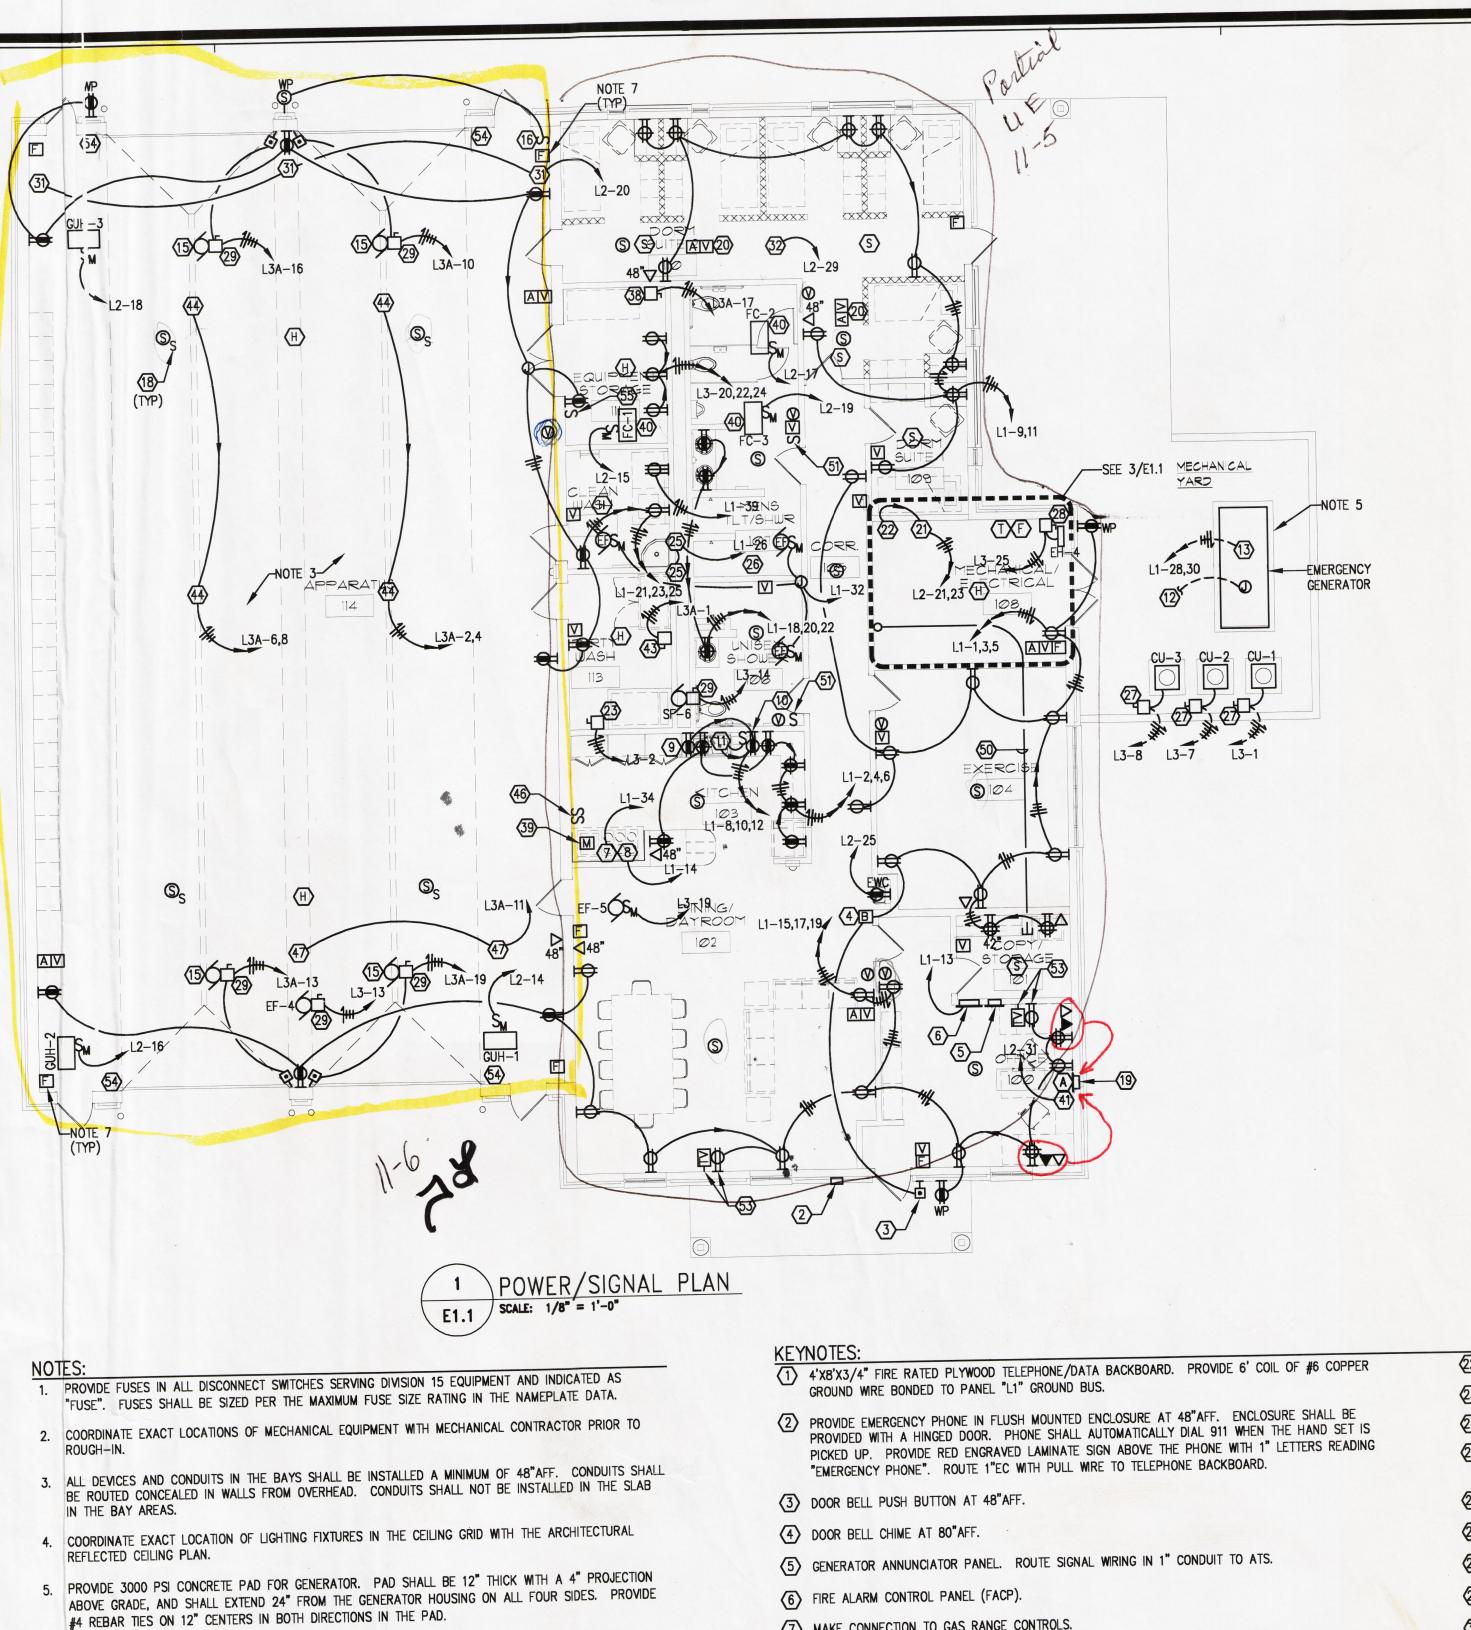

6. ALL MECHANICAL EQUIPMENT WILL BE PROVIDED WITH STARTERS WHICH ARE PROVIDED BY DIVISION 15.

ELECTRICAL CONTRACTOR SHALL WIRE THE EQUIPMENT THROUGH THE STARTERS PER THE STARTER

MECHANICAL

ELECTRICAL

MECHANICAL/ELECTRICAL ROOM

E1.1 | SCALE: 1/4" = 1'-0"

7. PROVIDE WEATHER PROOF COVERS ON THE FIRE ALARM PULL STATIONS IN THE APPARATUS BAYS.

MANUFACTURER'S DIRECTION.

7) MAKE CONNECTION TO GAS RANGE CONTROLS.

(8) MAKE CONNECTION TO RANGE HOOD.

OUTLET BELOW COUNTER FOR ICE MACHINE.

OUTLET BELOW COUNTER FOR DISH WASHER.

(11) MAKE CONNECTION TO DISPOSAL.

12 ROUTE GENERATOR CONTROL WIRING IN 1" CONDUIT TO ATS.

13 MAKE CONNECTION TO GENERATOR BLOCK HEATER AND CONTROL PANEL.

MAKE CONNECTION TO GENERATOR BATTERY CHARGER MOUNTED IN BOTTOM OF ATS ENCLOSURE.

MAKE CONNECTION TO ROLL UP DOOR MOTOR. ROUTE CONTROL WIRING IN CONDUIT TO THE PUSH BUTTON CONTROLLER AS INDICATED.

PROVIDE SWITCH TO DISABLE EXTERIOR SPEAKER AFTER HOURS.

PROVIDE HUBBELL CPC-12320-SC CORD REEL WITH A NEMA 5-20R CONNECTOR. CORD REEL SHALL BE MOUNTED SECURELY TO STRUCTURE. PROVIDE KELLEMS GRIPS ON END OF CORD. PROVIDE STOP ON CORD REEL TO PREVENT CORD FROM BEING RETRACTED ABOVE 7'-0".

18 SUBSCRIPT "S" INDICATES SPEAKER AND SUPPORT BRIDGE MOUNTED IN SURFACE MOUNTED BACKBOX AT STRUCTURE.

PROVIDE 12"X12"X4" INTERCOM/PAGING SYSTEM PULL BOX BEHIND THE AMPLIFIER. MOUNT BOX AT 36"AFF. STUB (2) 2" CONDUITS UP TO CEILING SPACE.

MOUNT FIRE ALARM HORN/STROBE ON THE CEILING.

PROVIDE SINGLE POLE MANUAL STARTER AND MAKE CONNECTION TO GAS WATER HEATER.

PROVIDE SINGLE POLE MANUAL STARTER AND MAKE CONNECTION TO CIRC. PUMP.

PROVIDE 30A/3P/FUSE DISCONNECT SWITCH AND MAKE CONNECTION TO EXTRACTOR.

PROVIDE TIME CLOCK FOF CONTROL OF ELECTRONIC TRAP PRIMERS.

MAKE CONNECTION TO ELECTRONIC TRAP PRIMER. COORDINATE EXACT LOCATION WITH PLUMBING CONTRACTOR PRIOR TO ROUGH-IN.

26 ROUTE HOMERUN THROUGH TRAP PRIMER TIME CLOCK (SEE KEYNOTE 24).

30A/3P/FUSE/RT DISCONNECT SWITCH.

28) PROVIDE 30A/2P/FUSE DISCONNECT SWITCH AND MAKE CONNECTION TO ELECTRIC HEATER.

29 30A/3P/FUSE DISCONNECT SWITCH.

30 30A/3P/FUSE/RT DISCONNECT SWITCH AT ROOF TOP EXHAUST FAN.

PROVIDE SINGLE POLE MANUAL STARTER AND MAKE CONNECTION TO MOTORIZED LOUVER. LOUVER TO BE CONTROLLED BY DIVISION 15.

PROVIDE DUPLEX GFCI OUTLET IN ATTIC FOR DEHUMIDIFIER.

DAMPERS AT ALL THREE FAN COIL UNITS.

PROVIDE 4-POLE E.O.M.H. LIGHTING CONTACTOR FOR CONTROL OF LIGHTING FIXTURES IN THE APERATUS BAYS. CONTACTOR SHALL BE CONTROLLED BY TWO MOMENTARY SWITCHES INDICATED IN KEYNOTE 34.

PROVIDE MOMENTARY TOGGLE SWITCH FOR CONTROL OF THE BAY LIGHTING CONTACTOR INDICATED IN KEYNOTE 33. ROUTE CONTROL WIRING FROM THE MOMENTARY SWITCH TO THE CONTACTOR. ROUTE HOMERUN THROUGH THE APERATUS BAY LIGHTING CONTACTOR INDICATED IN KEYNOTE 33. PROVIDE UNSWITCHED HOT LEGS, NOT CONTROLLED BY THE CONTACTOR, TO FEED EXIT SIGNS AS

PROVIDE 8-POLE E.O.M.H. CONTACTOR FOR CONTROL OF EXTERIOR LIGHTING CIRCUITS. PROVIDE

PHOTOCELL ON ROOF FOR CONTROL OF CONTACTOR.

ROUTE HOMERUN THROUGH THE EXTERIOR LIGHTING CONTACTOR INDICATED IN KEYNOTE 36.

30A/2P/FUSE DISCONNECT SWITCH FOR ICE MAKER. COORDINATE EXACT ELECTRICAL REQUIREMENTS WITH THE OWNER PRIOR TO ROUGH-IN.

PROVIDE MONITOR MODULE AND INTERLOCK HOOD FIRE SUPPRESSION SYSTEM WITH THE FIRE ALARM SYSTEM. PROVIDE CIRCUIT FROM L2-27 AND MAKE CONNECTION TO OUTSIDE AIR DAMPER. CIRCUIT SHALL SERVE MAKE CONNECTION TO PA AMPLIFIER PANEL. COORDINATE ROUGH-IN AND CONNECTION TYPE WITH SYSTEM MANUFACTURER.

PROVIDE MOTION DETECTOR MOUNTED AT STRUCTURE FOR CONTROL OF THE MIDDLE ROW OF LIGHTING FIXTURES IN THE APERATUS BAYS (SEE KEYNOTE 49). DETECTORS SHALL BE WIRED IN PARALLEL PER THE MANUFACTURER'S WIRING DIAGRAMS WITH CONTROL WIRING RUN IN CONDUIT TO THE CONTACTOR CONTROLLING THE LIGHTING CIRCUIT (SEE KEYNOTE 49). MOTION DETECTORS SHALL BE INFRA-RED TYPE WITH ADJUSTIBLE SHUT-OFF FROM 15 SECONDS TO 30 MINUTES. SET SHUT-OFFS TO 20 MINUTES. TIE MOTION DETECTOR POWER PACKS TO LOCAL RECEPTACLE CIRCUITS. DETECTORS SHALL BE WATT STOPPER CI-205-1 OR EQUAL AND SHALL BE DESIGNED FOR USE AT THE STRUCTURE HEIGHT.

60A/3P/FUSE DISCONNECT SWITCH FOR DRYING CABINET.

LIGHTING PLAN

SCALE: 1/8" = 1'-0"

PROVIDE 30A/1P/FUSE DISCONNECT SWITCH AT STRUCTURE AND MAKE CONNECTION TO AIR SCRUBBER. COORDINATE AIR SCRUBBER LOCATION WITH ARCHITECT PRIOR TO ROUGH-IN.

45 600A/3P/500AF MAIN DISCONNECT SWITCH. SEE RISER DIAGRAM.

PROVIDE (2) TOGGLE SWITCHES MOUNTED IN A 2-GANG BOX AT 48"AFF FOR CONTROL OF HOOD LIGHTS AND FAN. FAN SWITCH SHALL BE PROVIDED WITH A PILOT LIGHT. ROUTE CONTROL WIRING IN CONDUIT FROM THE SWITCHES TO THE FAN AND LIGHT CONNECTIONS.

PROVIDE HUBBELL CPC-12320-SC CORD REEL WITH A NEMA 5-20R CONNECTOR. CORD REEL SHALL BE MOUNTED SECURELY TO STRUCTURE. PROVIDE KELLEMS GRIPS ON END OF CORD. PROVIDE STOP ON CORD REEL TO PREVENT CORD FROM BEING RETRACTED ABOVE 7'-0".

(48) EXTEND TO LIGHT AT THE FLAG POLE. SEE SHEET E1.0.

THE CENTER ROW OF LIGHTING FIXTURES IN THE APPARATUS BAYS SHALL BE CONTROLLED BY MOTION DETECTORS INDICATED IN KEYNOTE 42. PROVIDE A CONTACTOR AT STRUCTURE ABOVE THE HOMERUN FIXTURE FOR ON/OFF CONTROL OF THE CIRCUIT BY THE DETECTORS.

PROVIDE A 2" EMPTY CONDUIT WITH PULL WIRE FROM ABOVE THE CEILING OF COPY/STORAGE ROOM 101 TO THE TELEPHONE BACKBOARD. TURN CONDUIT DOWN AND TERMINATE AT THE TOP OF THE BACKBOARD. PROVIDE INSULATING BUSHINGS ON BOTH ENDS OF CONDUIT.


PROVIDE A TOGGLE SWITCH FOR CONTROL OF THE SHOWER/TOILET EXHAUST FAN. MOUNT THE SWITCH IN A 2-GANG BOX WITH THE LIGHT SWITCH AND PROVIDE A COMMON COVER PLATE. ROUTE CONTROL WIRING IN CONDUIT FROM THE FAN SWITCH TO THE EXHAUST FAN.

MOUNT SWITCH IN 2-GANG BOX WITH EXHAUST FAN SWITCH. SEE KEYNOTE 51.

53 MOUNT CATV OUTLET AND DUPLEX RECEPTACLE AT 80"AFF.

PROVIDE RETRACTABLE CORD REEL AT STRUCTURE FOR ROLL UP DOOR SENSOR CONTROL CABLING. PROVIDE 1/2" EMPTY CONDUIT WITH PULL WIRE FROM THE CORD REEL TO THE DOOR MOTOR FOR INSTALLATION OF CABLING BY THE DOOR INSTALLER. COORDINATE THE EXACT LOCATION AND INSTALLATION OF THE CORD REELS WITH THE ARCHITECT AND DOOR INSTALLER.

PROVIDE TOGGLE SWITCH FOR CONTROL OF EXHAUST FAN EF-1. ROUTE CONTROL WIRING IN CONDUIT FROM THE SWITCH TO THE FAN.

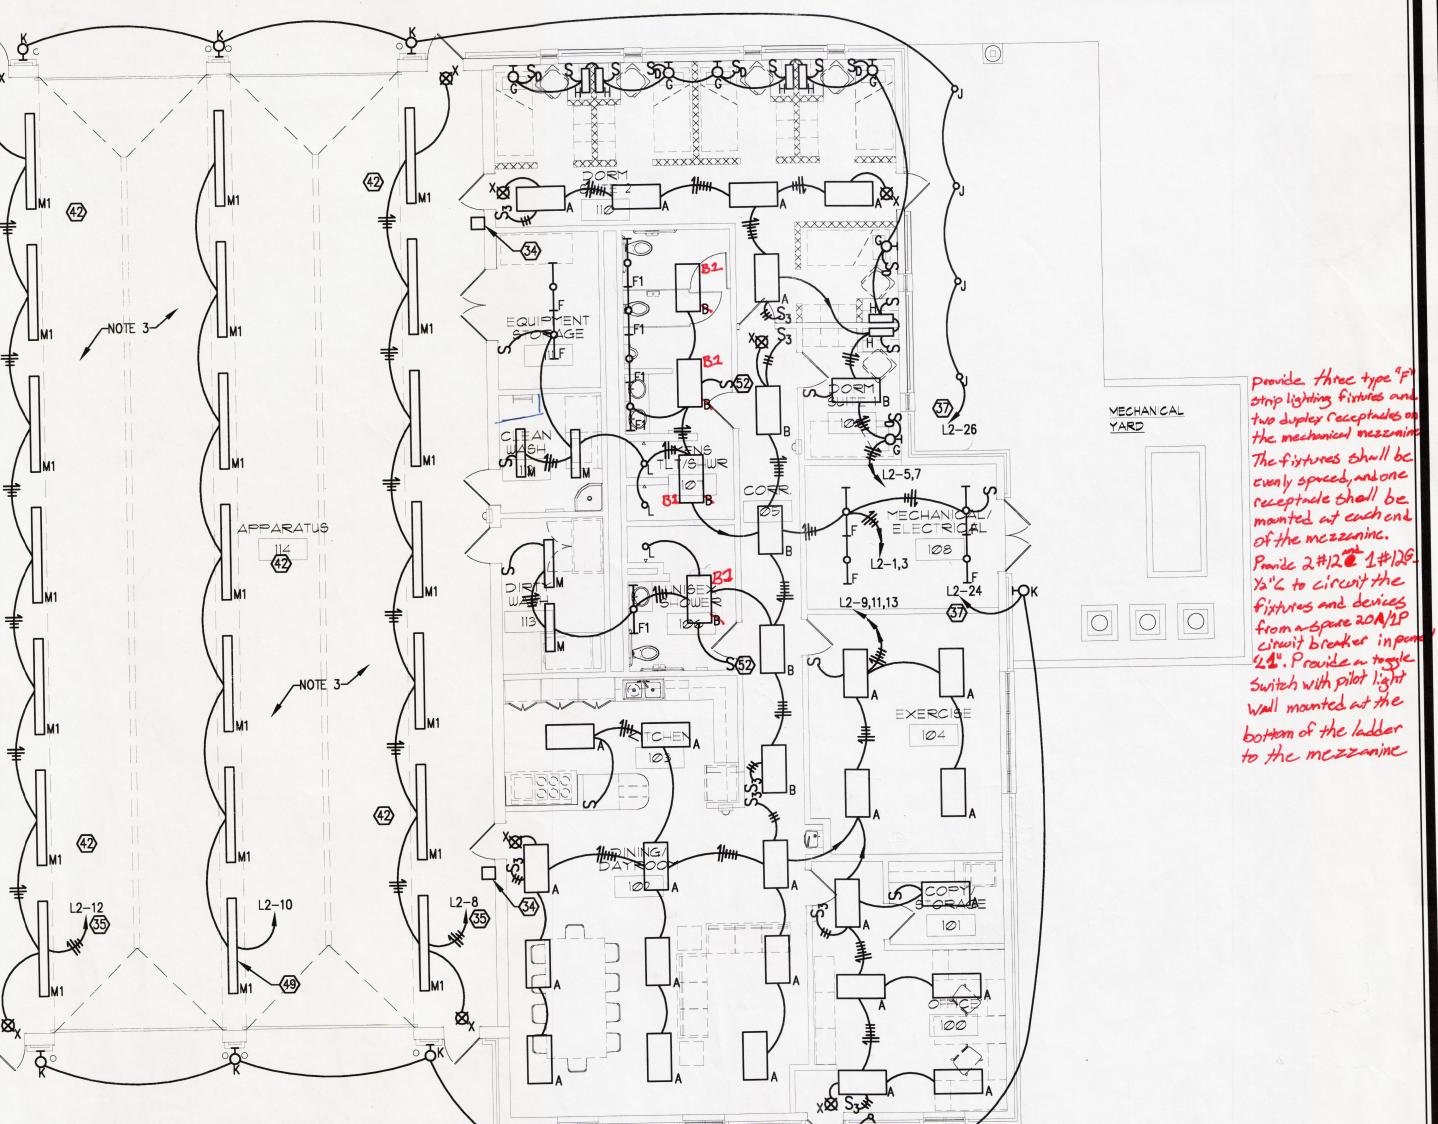







DATE: MAY 14, 2012

10B NO.611 1078 03 ALE: AS NOTED

> 0 V


> Œ

DRAWING NUMBER

	SYMBOL SCHEDULE
	LIGHTING FIXTURE - FLUORESCENT
	LIGHTING FIXTURE - BARE LAMP STRIP OR INDUSTRIAL STRIP
0	LIGHTING FIXTURE - INCAND., HID, OR FLUOR RECESSED OR SURFACE
Ю	LIGHTING FIXTURE - INCAND., HID, OR FLUOR WALL OR BRACKET MOUNTED
⊗	EXIT LIGHT WITH DIRECTIONAL CHEVRONS
	RECEPT MOUNTED ABOVE COUNTERTOP BACKSPLASH (NORMAL, GFI, OR IG AS INDICATED).
<u>₩</u>	15A, 125V, 2 POLE, 3 WIRE, GROUNDING, NEMA 5-15R DUPLEX RECEPT.
	15A, 125V, 2 POLE, 3 WIRE, GROUNDING, NEMA 5-15R DOUBLE DUPLEX RECEPT.
 	
	30 A, 125/250V, 3 POLE, 3 WIRE, NEMA 10-30R SINGLE REC. (DRYER OUTLET) DL PLEX RECEPTACLE WITH GROUND FAULT CURRENT INTERRUPTER
 	
	SFECIAL OUTLET - AS INDICATED
S	TC GGLE SWITCH, SINGLE POLE
S ₃	TCGGLE SWITCH, THREE—WAY
S ₄	TC GGLE SWTCH, FOUR WAY
S _M	TC GGLE SWITCH, MOTOR RATED WITH THERMAL OVERLOAD ELEMENT
S _D	SLIDE TYPE DIMMER SWITCH - 1000W (MINIMUM) OR SIZE AS INDICATED
S _F	ROTARY FAN SPEED CONTROLLER
•	DATA OUTLET WITH 1" C AND PULLWIRE TO ABOVE CEILING
\triangleright	TELEPHONE OUTLET WITH 3/4" EC HOMERUN TO TELEPHONE BACKBOARD
	120/208 VOLT PANELBOARD AS SCHEDULED
	TE LEPHONE BACKBOARD
0	JL NCTION BOX
□	DI CONNECT OR SAFETY SWITCH, SIZE AS INDICATED ON THE DRAWINGS
В	DC OR BELL CHIME
Æ/	MOTOR, # = HORSEPOWER, F = FRACTIONAL
0 •	C NDUIT RUN UP OR DOWN
#	CONDUIT, HOMERUN (CROSS MARKS = # OF CONDUCTORS WHERE MORE THAN THREE)
	CONDUIT CONCEALED OVERHEAD IN FINISHED SPACES, EXPOSED IN UNFINISHED SPACES (U.N.O.)
	CC NDUIT EMBEDDED IN THE SLAB OR BELOW GRADE.
EWC	OL TLET FOR ELECTRIC WATER COOLER MOUNTED CONCEALED BEHIND UNIT
G	GR OUND
EC	EN PTY CONDUIT
WP	W ATHERPROOF
RT	R/INTIGHT (NEMA 3R)
NL	NIGHT LIGHT (CONNECTED TO UNSWITCHED CIRCUIT)
F	FIFE ALARM MANUAL STATION
A	FIRE ALARM AUDIO ALARM
V	FIRE ALARM VISUAL STROBE
F	FIRE ALARM FLOW SWITCH
T	FIRE ALARM TAMPER SWITCH
	FIRE ALARM SMOKE DETECTOR
(s)	
(S) ₀	FIRE ALARM DUCT MOUNTED SMOKE DETECTOR
H	FIRE ALARM HEAT DETECTOR
S	FLUSH CEILING MOUNTED INTERCOM PAGING SPEAKER COMPLETE WITH BACKBOX AND SUPPORT BRIDGE. SPEAKER AND ACCESSORIES SHALL BE BY BOGEN.
0	SPEAKER VOLUME CONTROL BY BOGEN MOUNTED 48"AFF.
(A)	PAGING SYSTEM MIXER/AMPLIFIER. BOGEN TPU/100B. PROVIDE DESK TYPE PAGING MICROPHONE.
-[[V]	TELEVISION OUTLET BOX WITH 3/4" CONDUIT STUBBED ABOVE CEILING
1	ONE PHASE CONDUCTOR
1	O'IE NEUTRAL CONDUCTOR
	O IE EQUIPMENT GROUNDING CONDUCTOR
	I A IL LIGHT MILET. CITOCIDATE CONTROL CONTROL

LIGHTING FIXTURE SCHEDULE

- A TWO FOOT BY FOUR FOOT FLUORESCENT TROFFER, SPECIFICATION GRADE, ELECTRONIC BALLAST, A12.125 LENS, 120 VOLTS, 4" NOMINAL DEPTH, FOUR F32TB/3500K LAMPS. LITHONIA 2SP8 SERIES OR EQUAL BY
- B TWO FOOT BY FOUR FOOT FLUORESCENT TROFFER, SPECIFICATION GRADE, ELECTRONIC BALLAST, A12.125 LENS, 120 VOLTS, 4" NOMINAL DEPTH, TWO F32T8/3500K LAMPS. LITHONIA 2SP8 SERIES OR EQUAL BY
- B1- TWO FOOT BY FOUR FOOT FLUORESCENT TROFFER, SPECIFICATION GRADE, ELECTRONIC BALLAST, A12.125 LENS, 120 VOLTS, 4" NOMINAL DEPTH, FLANGE MOUNTED IN GWB CEILING. TWO F32T8/3500K LAMPS. LITHONIA 2SP8 SERIES OR EQUAL BY COOPER OR HUBBELL.
- C ONE FOOT BY FOUR FOOT FLUORESCENT TROFFER, SPECIFICATION GRADE, ELECTRONIC BALLAST, A12.125 LENS, 120 VOLTS, 4" NOMINAL DEPTH, FLANGE MOUNTED IN GWB CEILING. TWO F32T8/3500K LAMPS. LITHONIA SP8 SERIES OR EQUAL BY COOPER OR HUBBELL.
- D PL FLUORESCENT DOWNLIGHT, 8" OPEN APERTURE, CLEAR ALZAK REFLECTOR, 120 VOLTS, ELECTRONIC BALLAST, VERTICALLY MOUNTED 42W TRI-TUBE LAMP. LITHONIA AFV SERIES OR EQUAL BY COOPER OR
- F FOUR FOOT FLUORESCENT STRIP, 120 VOLTS, ELECTRONIC BALLAST, TWO F32T /3500K LAMPS, WIRE GUARD. CHAIN MOUNTED IN AREAS WITH EXPOSED STRUCTURE. LITHONIA C240 SERIES OR EQUAL BY
- F1- FOUR FOOT FLUORESCENT STRIP, 120 VOLTS, ELECTRONIC BALLAST, TWO F32T8/3500K LAMPS. LITHONIA C240 SERIES OR EQUAL BY COOPER OR HUBBELL. MOUNT FIXTURE IN ARCHITECTURAL COVE.
- G INCANDESCENT WALL SCONCE ALUMINUM OVAL HOUSING, 11" WIDTH, 6.75" HEIGHT, FINISH AS SELECTED BY ARCHITECT, FROSTED GLASS DIFFUSER, HORIZONTAL EYELID WITH GRILL, 120 VOLTS, 100W A-19 LAMP. TERON BEOC SERIES. COORDINATE MOUNTING HEIGHT WITH ARCHITECT PRIOR TO ROUGH-IN.
- H UNDER CABINET TASK LIGHT, TWO FOOT LENGTH, SHATTER RESISTANT LENS, WHITE HOUSING, ELECTRONIC BALLAST, 120 VOLTS, ONE F17T8/3500K LAMP. LITHONIA 2UC SERIES OR EQUAL BY COOPER OR
- J EXTERIOR H.I.D. DOWNLIGHT, 9" APERTURE, REGRESSED WHITE DOOR, FLAT FRESNEL LENS, 120 VOLTS, WET LOCATION, SINGLE FUSE, 100W METAL HALIDE LAMP. LITHONIA LGH SERIES OR EQUAL BY COOPER
- K EXTERIOR WALL MOUNTED FIXTURE, OVAL DIE CAST ALUMINUM HOUSING, VERTICAL MOUNTING, MOLDED GLASS DIFFUSER, DIE CAST ALUMINUM GUARD, HOUSING AND GUARD FINISH AS SELECTED BY ARCHITECT, GASKETED FOR WET LOCATION LISTING, 120 VOLTS, (2) 13W PL LAMPS. BEGA #2893P. COORDINATE MOUNTING HEIGHT WITH ARCHITECT PRIOR TO ROUGH-IN.
- L PL FLUORESCENT SHOWER FIXTURE DOWNLIGHT, 9" APERTURE, DROP OPAL LENS, LISTED FOR WET LOCATIONS, 120 VOLTS, 42W VERTICAL TRI-TUBE LAMP. LITHONIA LGFV SERIES OR EQUAL BY COOPER
- M FOUR FOOT ENCLOSED FLUORESCENT STRIP, IMPACT RESISTANT POLYESTER HOUSING, ACRYLIC DIFFUSER, GASKETED, LISTED FOR DAMP LOCATIONS, ELECTRONIC BALLAST, 120 VOLTS, TWO F32T8/3500K LAMPS. LITHONIA DM SERIES OR EQUAL BY COOPER OR HUBBELL.
- M1- EIGHT FOOT ENCLOSED FLUORESCENT STRIP, IMPACT RESISTANT POLYESTER HOUSING, ACRYLIC DIFFUSER, GASKETED, LISTED FOR DAMP LOCATIONS, ELECTRONIC BALLAST, 120 VOLTS, TWO 95W F96T8HO/3500K LAMPS. LITHONIA DM SERIES OR EQUAL BY COOPER OR HUBBELL.
- N GRADE MOUNTED FLOOD LIGHT, BRONZE HOUSING, 180/360 ROTATION KNUCKLE MOUNT, 120 VOLTS, 35W METAL HALIDE LAMP. HYDRELL 7000 SERIES. PROVIDE SETBACK AS RECOMMENDED BY THE FIXTURE MANUFACTURER.
- P FOUR FOOT ENCLOSED FLUORESCENT STRIP, HIGH IMPACT REINFORCED POLYESTER FIBERGLASS HOUSING, SHATTER RESISTANT ACRYLIC DIFFUSER, GASKETTED, LISTED FOR DAMP LOCATION, CORROSION RESISTANT CAM LATCHES, ZERO DEGREE ELECTRONIC BALLAST, 120 VOLTS, TWO F32T8/3500K LAMPS. LITHONIA DM SERIES OR EQUAL BY COOPER OR HUBBELL.
- Q PREMIUM CUT-OFF SHOE BOX TYPE SITE LIGHTING FIXTURE, EXTRUDED ALUMINUM HOUSING, CORROSION RESISTANT HARDWARE, SEGMENTED REFLECTOR, ARM MOUNTED, TYPE 3 DISTRIBUTION, DOUBLE FUSE, 208 VOLTS, 400W METAL HALIDE LAMP, 4"X4"X16' STRAIGHT SQUARE STEEL POLE. VISIONAIRE AMERICAN SERIES OR EQUAL BY COOPER OR HUBBELL. POLE SHALL BE PROVIDED WITH A WEATHER PROOF OUTLET BOX AT 12" ABOVE THE MOUNTING BASE PLATE.
- Q1- PREMIUM CUT-OFF SHOE BOX TYPE SITE LIGHTING FIXTURE, EXTRUDED ALUMINUM HOUSING, CORROSION RESISTANT HARDWARE, SEGMENTED REFLECTOR, ARM MOUNTED, TYPE 4 DISTRIBUTION, DOUBLE FUSE, 208 VOLTS, 400W METAL HALIDE LAMP, 4"X4"X16' STRAIGHT SQUARE STEEL POLE. VISIONAIRE AMERICAN SERIES OR EQUAL BY COOPER OR HUBBELL. POLE SHALL BE PROVIDED WITH A WEATHER PROOF OUTLET BOX AT 12" ABOVE THE MOUNTING BASE PLATE.
- X EXIT SIGN, SINGLE FACE, CAST ALUMINUM BODY, RED LED LAMPS AND LETTERS, DIFFUSE FACE, UNIVERSAL MOUNTING, 120 VOLTS, KNOCK-OUT CHEVERONS TO INDICATE DIRECTION OF EGRESS. LITHONIA SIGNATURE SERIES OR EQUAL BY COOPER OR HUBBELL.

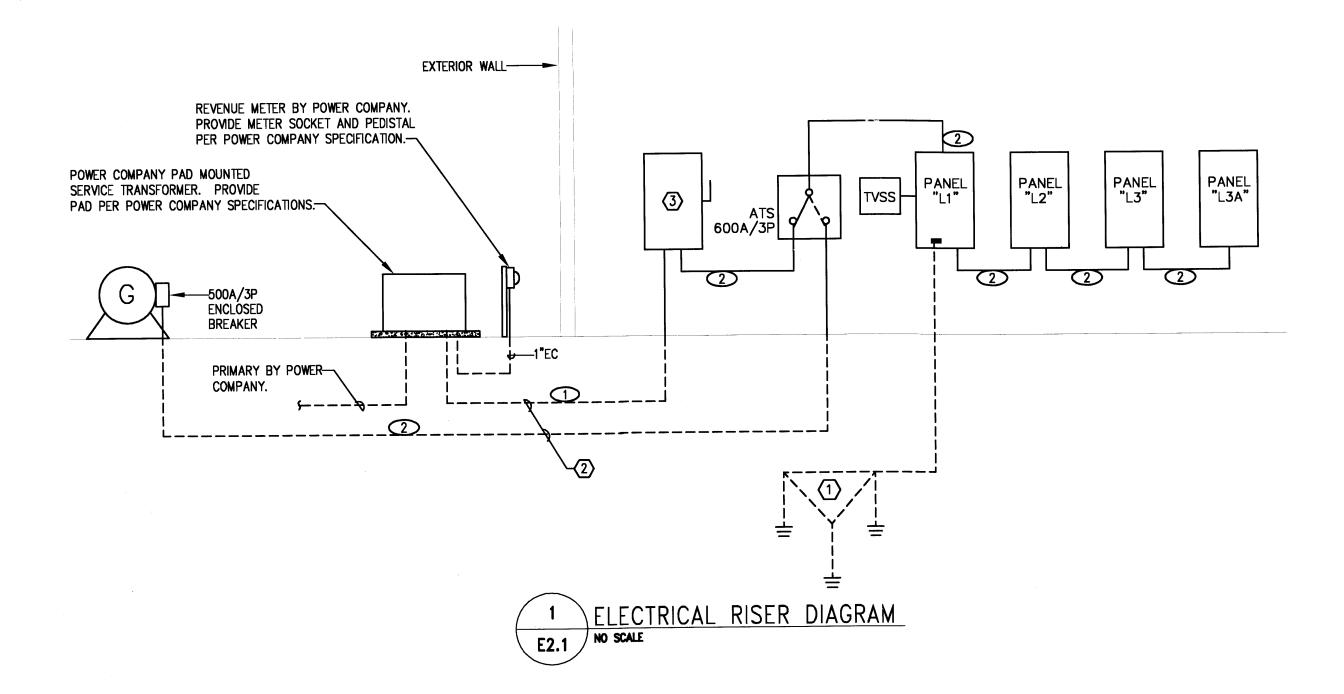

CONTRACTOR SHALL OBTAIN A LIST OF ROOM NUMBERS FROM THE OWNER, AND INCLUDE BOTH ROOM NUMBERS AND LOADS SERVED IN THE PANEL DIRECTORIES FOR EACH CIRCUIT (IE - RECEPTACLES, ROOM

- (1) RUN (1) #3/0 GROUND TO THREE 3/4" x 10' COPPERCLAD GROUND RODS SPACED TEN FEET APART ON THE EXTERIOR OF THE BUILDING, (1) #3/0 GROUND TO MAIN METAL DOMESTIC WATER LINE, AND (1) #3/0 TO BUILDING STEEL. GROUNDING CONDUCTOR SHALL BE BURIED 24" (MIN.) BELOW GRADE. GROUND RODS SHALL BE DRIVEN SO THAT THEIR TOPS ARE 24" (MIN.) BELOW GRADE.
- NORMAL AND EMERGENCY SERVICE LATERALS SHALL BE ENCASED IN 3200PSI RED DYE CONCRETE ENVELOPE. CONCRETE SHALL PROVIDE 4" (MIN) COVER ON ALL FOUR SIDES. PROVIDE #4 REBAR TIES ON 4 FOOT CENTERS VERTICALLY AND HORIZONTALLY (TOP, BOTTOM, AND BOTH SIDES). PROVIDE CONDUIT SPACERS ON 4 FOOT CENTERS AT ALTERNATE 2 FOOT INTERVALS WITH REBAR.
- (3) 600A/3P/500AF MAIN DISCONNECT SWITCH.

FEEDER LEGEND:

1 2 SETS OF 4#250MCM - 2 1/2"C EACH


2 2 SETS OF 4#250MCM & 1#2G - 2 1/2"C EACH



DEYOUNG

BELL AL INC. OF CHITECTS HUSSEY



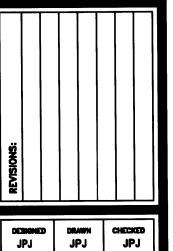

DATE: MAY 14, 2012

OB NO.611 1078 03

SCALE: AS NOTED

<u>2</u>

DRAWING NUMBER

	BRD.			F CKT. SPACE	23.			42		200	DEVICE:	1	
	OLT.		AIC R			42,000				TYPE:	MLO		
NO.		3	CABIN		740 1000	SURFAC		120000000		SIZE:	6004		
NO.	TA	WS	COND	DESCRIPT	TI	LOAD	NO.	TA	WS	COND	DESCRIPT	TL	LOAL
1	20/1	12	1/2"	RECEPT	R	1100	2	20/1	12	1/2"	RECEPT	R	1500
3	20/1	12	1/2"	RECEPT	R	900	4	20/1	12	1/2"	REFRIG	R	1200
5	20/1	12	1/2"	COPIER	R	1200	6	20/1	12	1/2"	RECEPT	R	1500
7	20/1	12	1/2"	TELE BKBD	R	800	8	20/1	12	1/2"	DISH WA SHER	R	1200
9	20/1**	12	1/2"	RECEPT	R	700	10	20/1	12	1/2"	DISPOSAL	R	1200
11	20/1**	12	1/2"	RECEPT	R	900	12	20/1	12	1/2"	ICE MACHINE	R	1200
13	20/1	12	1/2"	FACP	o	800	14	20/1*	12	1/2"	HOOD	\mathbf{M}	1000
15	20/1	12	1/2"	RECEPT	R	1100	16	\ 	SHUNT	FRIP SPA	CE		
17	20/1	12	1/2"	RECEPT	R	900	18	20/1	12	1/2"	WASHER	M	1200
19	20/1	12	1/2"	RECEPT	R	1100	20	20/1	12	1/2"	RECEPT	R	700
21	20/1	12	1/2"	RECEPT	R	1500	22	20/1	12	1/2"	RECEPT	R	700
23	20/1	12	1/2"	RECEPT	R	1500	24	20/1	12	$1/2^n$	GEN CHGR	O	1200
25	20/1	12	1/2"	RECEPT	R	1500	26	20/1	12	1/2"	TRA P PRIMER	O	400
27	20/1	6	1"	STOR, BLDG.	L	1200	28	20/1	12	1/2"	GEN BLK HTR	H	1500
29	20/1		Fam.	SPARE			30	20/1	12	1/2"	GEN CNTRLS	О	1200
31	20/1	8	3.4"	RECEPT	R	400	32	20/1	12	1/2"	EXH FANS	M	1200
33	20/1	10	1/2"	RECEPT	R	200	34	20/1*	12	1/2"	RANGE	0	800
35	20/1		**************************************	SPARE			36		SHUNT	TRIP SPA	CE		
37	20/1			SPARE			38	20/1			SPARE		
39	30/2	10	1/2"	DRYER	Н	5000	40	20/1			SPARE		
41			-		120	AUDICENS OF S	42	20/1			SPARE		
	CRIPT.		DF	LOAD	78						DEMANI	Л	
2.00	. PNLS.	* : * : * :	1	115710	- 5	VOLTAGE	:		208		11571	-	
	EPT.				1	PHASES:			3	2000.00	1150		
LIG	1,17,040		1.25	1200	+	SPARE %		<u> </u>	0.2		150	-	
HEA			1		+				- 7	l	650	4	
COC		- 1- 1- 1- 1- 1- 1- 1- 1- 1- 1- 1- 1- 1-	1		+							9	
out-species.	TOR .	. (-	i	3400	+						340		
OTH		4	1	4400	1	ere Milos de la se					440	1	
SPA	Constitution of the Consti		1	7700		1000 E					770	-	
JEAU	e value		1	CONNLOAD		AMI]				DEMLOAD	1	A.
				161910	+	449	-				15071	<u> </u>	4

PROVID 3 FEED THROUGH LUGS TO SERVE PANEL "L2".


** PROVIDE A FCI TYPE CIRCUIT BREAKER


* PROVIDE SHUNT TRIP BREAKER CONTROLLED BY HOOD SUPPRESSION SYSTEM.

I.INS		 	ASSESSMENT OF THE PARTY OF THE	F CKT. SPA	LE:	3880		42		200000000 C	DEVICE:		
PP VOLT.			AIC R			42,000		. The progress observes as	1.00	TYPE:	MLO		100 miles 100 miles
NO. F		The same of the sa	CABIN		Andrew !	SURFACE	22000	<u> </u>	SIZE:	600A		2 2 3 3 3 3	
NO.	TA	WS		DESCRIPT	1L	Annual State of the State of th	NO.	TA	WS	COND	Prince of the control	TL	LOAD
1	20/1	12	1/2"	LIGHTING	L	1200	2	20/1			SPARE		
3	20/1	12	1/2"	LIGHTING	L		4	20/1			SPARE		
5	20/1*	12	1/2"	LIGHTING	L	900	6	20/1			SPARE		
7	20/1*	12	1/2"	LIGHTING	L	1000	8	20/1	12	1/2"	LIGHTING	L	1200
9	20/1	12	1/2"	LIGHTING	L	800	10	20/1	12	1/2"	LIGHTING	L	1200
11	20/1	12	1/2"	LIGHTING	L,	W. W. W. W. W.	12	20/1	12	1/2"	LIGHTING	L	1200
13	20/1	12	1/2"	LIGHTING	L	1800	14	20/1	12	1/2"	GUH-1	M	600
15	20/1	12	1/2"	FC-1	M	900	16	20/1	12	1/20	GUH-2	M	600
17	20/1	12	1/2"	FC-2	M	900	18	20/1	12	1/2"	GUH-3	M	600
19	20/1	12	1/2"	FC-3	M	900	20	20/1	12	1/2"	LOUVERS	M	900
21	20/1	12	1/2"	WTRHTR	О	1200	22	20/1			SPARE		
23	20/1	12	1/2"	CIRC PUMP	M	600	24	20/1	10	1/2"	EXT LTG	L	600
25	20/1	12	1/2"	EWC	R	1200	26	20/1	10	1/2"	EXTLIG	L	600
27	20/1	12	1/2"	DAMPERS	M	300	28	20/2	6	1"	SITE LIGHTING	L	1000
29	20/1	12	1/2"	DEHUMID	M	1200	30	AND.	PATE.		575572°	740T	
31	20/1	12	1/2"	MOSCAD	O	600	32	20/2	-6	1"	SITE LIGHTING	L	1000
33	20/1			SPARE			34	***	(militare)				
35	20/1			SPARE			36	20/1	8	3/4"	RECEPT	R	400
37				SPACE			38	20/1			SPARE		
39				SPA CE			40	20/1			SPARE		
41				SPACE			42	20/1			SPARE		
DESC	RIPT.		DF	LOAD				1000			DEMAND		
OTH.	PNLS. 1 81680					VOLTAGE			208		81680		
RECI	EPT.	0.5 1600				PHASES:		291 Mari on 2016 Mari o	3		800		
LIGH	ΙΙ		1.25	15000		SPARE %:	We have share		0.2		18750		
HEAT	ľ	***************************************	1	0							0		
COO	L,		1	0							0		
MOT	OR		1	7500			16.0				7500		
отн	ER		1	1800						Page 1000 to the second	1800		
SPAR	Œ	·	1	5180						1 1 1 1 1 1 1 1 1 1 1 1 1 1 1 1 1 1 1	5180		
4 (CONNLOAD		AMP	1				DEMLOAD	<u></u>	AMI
		GAT SEC		112760		313				New Color	115710		32
NOT	ES:	PANEI	SHAL	BE SERVIC	E	. Marie 14 anni - 1944 - 1945 - 1945 - 1945 - 1945 - 1945 - 1945 - 1945 - 1945 - 1945 - 1945 - 1945 - 1945 - 1	TED.						ariante de la comita de la COSTA (1995). Sen al la comita de

PNL.I	1 4 1 1 1 1 1 1 1 1 1 1 1 1 1 1 1 1 1 1	"I 3"	NO. O	F CKT, SPA	CES) ;		42		MAIN	DEVICE:		
PP V	OLT.	2 08	AIC R	ATING:		42,000				TYPE:	MLO		
NO. PH.		3 CABINET:			SURFACE				100	SIZE:	600A		1,275
NO.	TA	WS	COND	DESCRIPT	TL	LOAD	NO.	TA	WS	COND	DESCRIPT	TL	LOAD
1	30/3	10	1/2"	CU-1	C	7000	2	30/3	10	1/2"	EXTRACTOR	M	6200
3	* <u>4.46</u>	<u> </u>		Haw	14.		4	-	7.525 7.52 5	(020)	13 412 1	12. C	
5		10 May 12			إغريت		6	es .		****	i i de	(2000).	
7	30/3	10	1/2"	CU-2	C	5900	8	20/3	12	1/2"	CU-3	C	3700
9		-	****	7.53	() - ()		10		izārā".	20000	8030	W 18	
11	<u>-1-</u> .	: <u> </u>	٠. <u>تقب</u>	- 205	الصفا		12	J <u>420</u> .7	265	V <u>240</u> 2	9 <u>202</u> 9	<u> 87. j</u> .j.;	
13	20/3	12	1/2"	EF-4	M	2800	14	20/3*	12	1/2"	SF-6	M	1300
15	market.	(()))) #45 €.		-		16	V 2012 25	4404	N-P	(1000 7.	
17		-	:: ***	7 450 7	***		18	1.0 000 0	HHM	***	3 858 (er-	
19	20/1*	12	1/2"	EF-5	M	1200	20	20/1	12	1/2"	REFRIG	R	1200
21		SHUNT	TRIP SPA	Œ			22	20/1	12	1/2"	REFRIG	R	1200
23	20/1			SPARE			24	20/1	12	1/2"	REFRIG	R	1200
25	20/2	12	1/2"	EH-4	H	2000	26	20/3	10	1/27	FUEL STN	M	2500
27		% -,	-	- 	747.		28	V AN E	And h	1854F	13 44		
29	20/3	10	1/2"	FUEL STN	M	2500	30		are.	357	3772	877 .	
31							32				SPACE		
33	عبد ا	572	ga <mark>kansa</mark> a	V III s.	pinter)		34				SPACE		
35	20/1			SPARE			36	en e			SPACE		
37	20/1			SPARE			38	of control of the con			SPACE		
39	20/1			SPARE			40				SPACE		
41	20/1			SPARE			42	1			SPACE	II de seine de la constante	
DESC	RIPT		DF	LOAD							DEMAND		
A. L. Miller	PNLS	\	1	37040		VOLTAGE:			208		37040		
RECI	EPT.		0.5	3600		PHASES:			3		1800		
LIGH			1.25	0		SPARE 50:			0.2		0		
HEA	Γ		1	2000				No.			2000		
COO	L.	16 - 2007 16 - 2 2007 -	1	16600							16600		
MOT	OR	CONTRACTOR AND	1	16500							16500		
ОТН	ER		1	0							0		
SPAR	Œ	A STATE OF THE STA	1	7740							7740		
				CONNLOAD		AMP					DEMLOAD		Añ
				83480		232					81680		2

PNL.				F CKT. SPA	CES	Committee of the product was about		42		24 142814 0422 14334 4CV 16CV 24	DEVICE:		
PP V	AND READ STORY	1.00	AIC RA	participation of the second		42,000	A DESCRIPTION OF THE	and the second s		TYPE:	MLO		
NO. I	F,F(RYSV280)	A statement of the state	CABIN	MP700001288	granden ign	SURFAC	E	المواقع فالمدارين والمراجع والمسامي	il il	SIZE:	600A		
NO.	TA	WS	COND	DESCRIPT	TL	LOAD	NO.	TA	ws	COND	DESCRIPT	TL.	LOAD
1	50/3	4	1"	DRYING CAB	H	12000	2	20/1	10	1/2"	AIR SCRUB.	M	1600
3	# ****	/ 	1000		SHAT.		4	20/1	10	1/2"	AIR SCRUB.	M	1600
5	7. 5* 5/6	/ = -	###	1995 M			6	20/1	10	1/2"	AIR SCRUB.	M	1600
7	30/2	10	1/2"	ICE MKR	C	2000	8	20/1	10	1/2"	AIR SCRUB.	M	1600
9	4.772	3300	4000	, 755 <u>0</u>	(30.10)		10	20/3	10	1/2"	RU DOOR	M	2500
11	20/1*	10	1/2"	CORD REELS	R	800	12	***	- -) (See A	-	
13	20/3	10	1/2"	RU DOOR	M	2500	14	444	8. 222 5	W12	2. <u>W45.</u> 4	-	
15	WE-201	ÆŽ4	<u> 10-21-0</u> 1:	0.0000			16	20/3	10	1/2"	RU DOOR	M	2500
17	0.624	-22-	pattine.	Section 1	-4		18		144 <u>44</u> 47	3.00 mg	en de de la companya	التحد	
19	20/3	10	1/2"	RU DOOR	M	2500	20		3444			1244	
21		***		j a ⇔¥			22	20/1			SPARE		
23	(*************************************	(577.	i de s	West His			24	20/1			SPARE		
25	20/1			SPARE			26	20/1			SPARE		
27	20/1			SPARE			28	20/1			SPARE		
29	20/1			SPA RE			30	20/1			SPARE		
31				SPA CE			32				SPACE		
33				SPACE			34				SPACE		
35				SPA CE			36				SPA CE		
37				SPA CE			38				SPA CE		
39				SPA CE			40				SPACE		
41				SPA CE			42				SPA CE		
DESC	CRIPT.		DF	LOAD					le de la companya de		DEMAND		
OTH	. PNLS		1	0		VOLTAGE	•		208]	0		
REC	EPT.		0.5	800		PHASES:	Secretario de Constituto	THE TOTAL SERVICE	3		400		
LIGE	II		1.25	0		SPARE%			0.2		0		
HEA	Γ		1	12000						•	12000		
coo	L		1	2000							2000		
MOT	OR		1	16400							16400		
отн	ER		1	0		11 (6.27)					9		
SPAF	₹E		1	6240			i bez				6240		
	7 (g 90), y (g		200 EU 40	CONNLOAD		AMI	•			15000 115	DEMLOAD		AM
				37440		104		44			37040		10
NOT			SUSSES CAUSE CARRENT	BE SERVIC	28588	on a second residence of the	ATED.				True pillad fir	3.,	

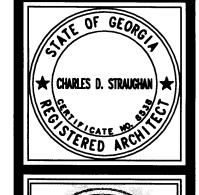

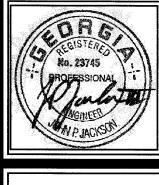

1. (770) 636-1188 X (770) 636-1184

L & DEYOUNG t of Georgia tts tts

IUSSEY, GAY, BELL & INTERNATIONAL, INC. OF ARCHITECTS

A Bell Company

DESIGNED DRAWN CHECKED JPJ DATE: MAY 14, 2012

JOB NO.611 1078 03

JOB NO.611 1078 03

SCALE: AS NOTED

GEORGIA
OARD SCHEDULES

IRE STATIO

DRAWING NUMBER

E2.2