



Forsyth County Procurement

Donna H. Kukarola, CPPO < CPPB Director

May 21, 2020

ADDENDUM #1 BID NO. 20-65-5212

For: Construction of refresh of Caney Creek Preserve

This addendum supersedes and supplements all portions of the bidding documents and becomes part of the contract documents for the above-referenced project.

Where any item called for in the specifications or indicated on the drawings is supplemented hereby, the original requirements shall remain in effect.

Where any original item is amended, voided or superseded hereby, the provision of such item not so specifically amended, voided or superseded shall remain in effect.

Questions received: *(response in italics)*

1. The Plans appear to be in 11" x 17" format and not the full size set, how can we obtain the full set?
Please see attached.

End of Addendum #1

Caney Creek Preserve Park Improvements Site Development Plans

Forsyth County, Georgia
Parcel ID: 112264

Consultants

Landscape Architect



Alfred Benesch & Company
2359 Perimeter Pointe Parkway, Suite 350
Charlotte, NC 28208
www.benesch.com
P 704.521.9880
Corp. NC License: F-1320

Civil Engineer




Alfred Benesch & Company
2359 Perimeter Pointe Parkway, Suite 350
Charlotte, NC 28208
www.benesch.com
P 704.521.9880
Corp. NC License: F-1320

Surveyor

Singleton Land Surveying Company Inc.
8641 Dorris Road, Suite 140C,
Douglasville, Georgia 30134
P (770)577-7001

Owner/Developer

Forsyth County
110 East Main Street,
Cumming, Georgia 30040
P (770)781-2101

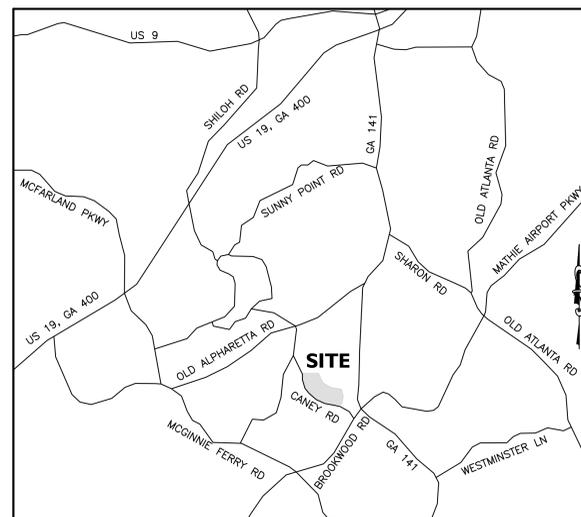

Vicinity Map

Schedule of Drawings

Civil/Landscape Architectural

- Cover Sheet
- C100 Overall Existing Conditions/ Demolition Plan
- C101 Existing Conditions/Demolition Plan Enlargement - West
- C102 Existing Conditions/Demolition Plan Enlargement - East
- C200 Overall Site Plan
- C201 Site Plan Enlargement - West
- C202 Site Plan Enlargement - East
- C300 Overall Grading/Utility Plan
- C301 Grading/Drainage Plan Enlargement - West
- C302 Grading/Drainage Plan Enlargement - East
- C303 Pipe Plan & Profiles
- C304 ESCP Plan - Initial Phase
- C305 ESCP Plan - Intermediate Phase
- C306 ESCP Plan - Final Phase
- C307 ESCP Plan - Notes 1 of 3
- C308 ESCP Plan - Notes 2 of 3
- C309 ESCP Plan - Notes 1 of 3
- C310 ESCP Details - 1 of 2
- C311 ESCP Details - 2 of 2
- C400 Overall Utility Plan
- C500 Overall Landscape Plan
- C501 Landscape Plan Enlargement - West
- C502 Landscape Plan Enlargement - East
- C600 Site Construction Details
- C601 Site Construction Details
- C602 Site Construction Details

Irrigation

- I100 Overall Irrigation Plan
- I101 Irrigation Plan Enlargement-West
- I102 Irrigation Plan Enlargement-East
- I103 Irrigation Details

Site Address:
Main Entrance = 2755 Caney Road
Secondary Entrance = 3055 Caney Road

Notes



- Source of Water and Sewer is Forsyth County Department of Water & Sewer.
- Notify Forsyth County Water and Sewer Department 24 hours prior to construction (404) 623-4241.
- Certificate of Occupancy will not be issued until final inspections completed by Forsyth County Water & Sewer Department.

Erosion and Sediment Control 24-Hour Contact
James Weldon (404) 276-3622

Forsyth County Board of Tax Assessors
2nd District, 1st Section, Land Lot(s) 988, 989, 990, 1026, 1027, 1060, 1061 ETAL
Total Area: 61.97 Acres
Total Area Disturbed: 2.0 Acres

Issued For Bids

Date of Issue: 04/27/20 Set No.: _____

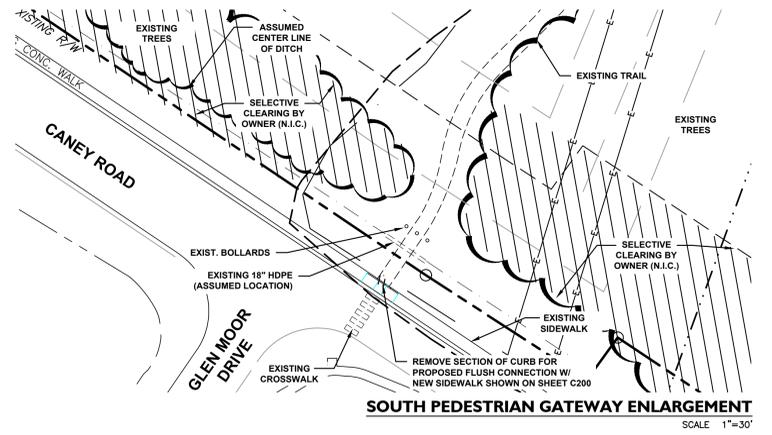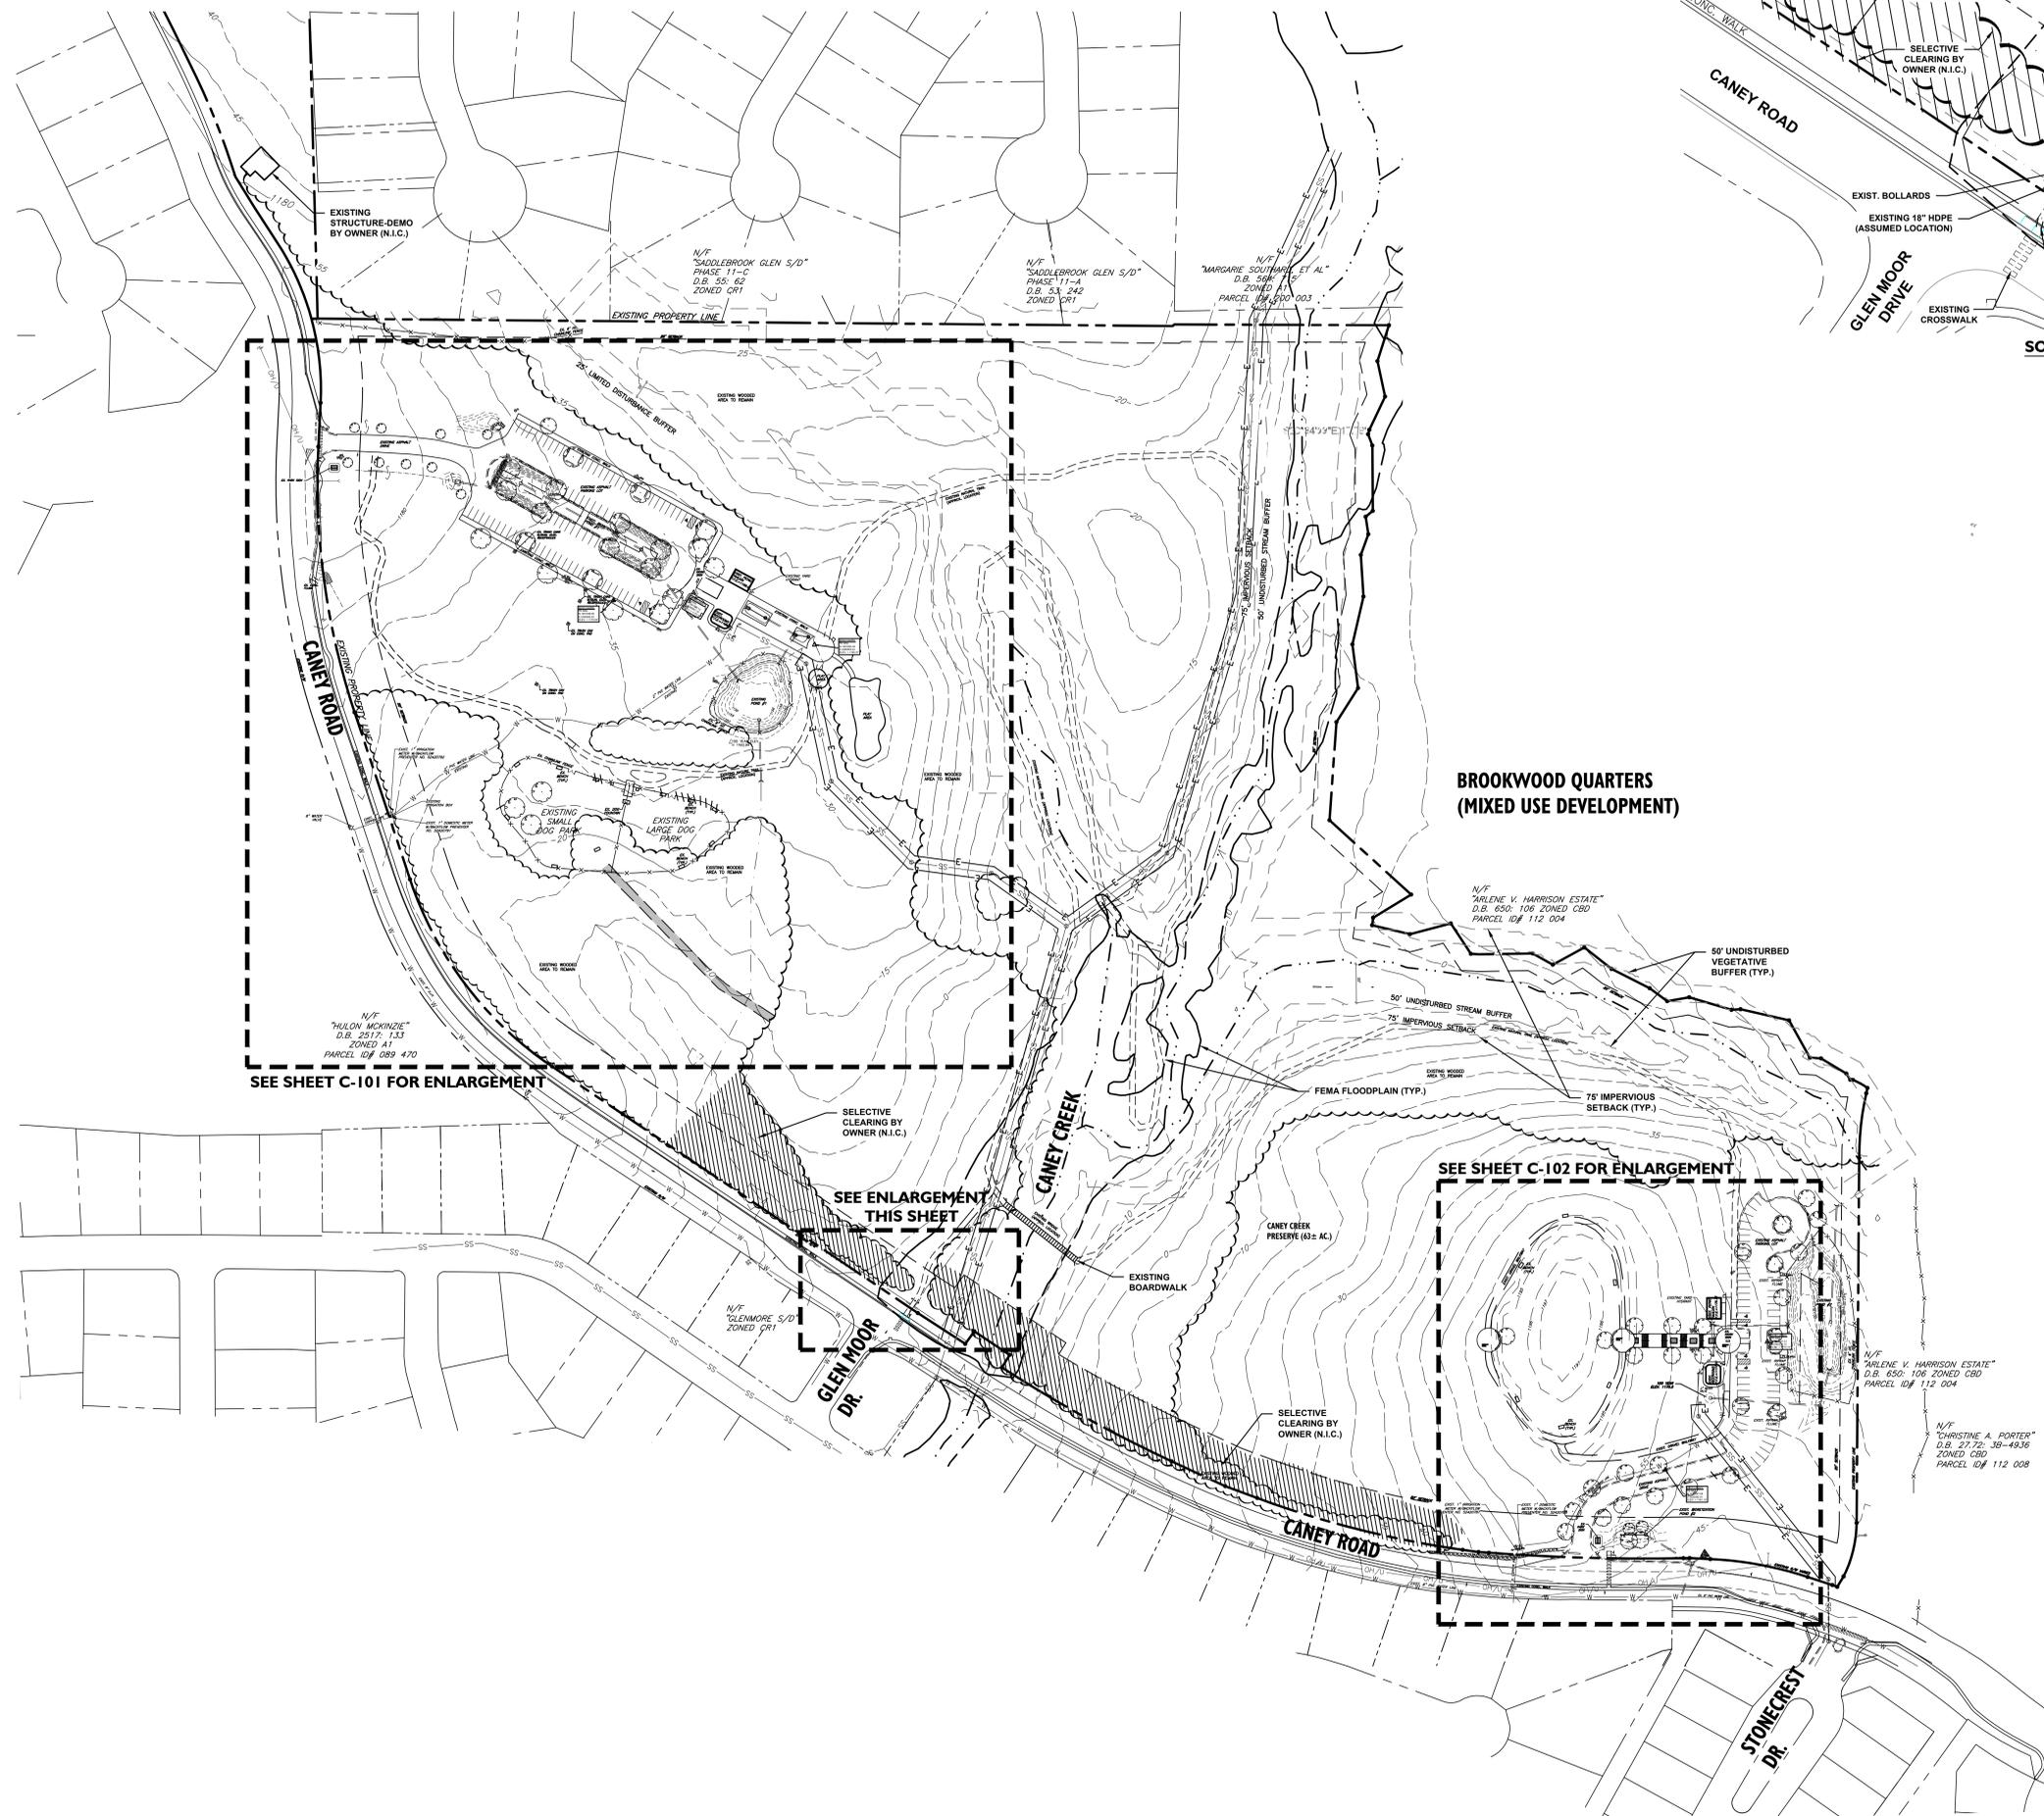


SOUTH PEDESTRIAN GATEWAY ENLARGEMENT
SCALE: 1"=30'

**BROOKWOOD QUARTERS
(MIXED USE DEVELOPMENT)**

DEMOLITION/CLEARING NOTES

- BOUNDARY AND TOPOGRAPHIC INFORMATION TAKEN FROM 2 SOURCES. HARRISON PROPERTY AS BUILT SURVEY DATED JUNE 2018 PREPARED BY SINGLETON LAND SURVEYING AND FROM FORSYTH COUNTY GIS.
- PROTECT ADJACENT CURBS, TREES, BUILDINGS, UTILITIES AND OTHER ITEMS TO REMAIN FROM DAMAGE. CONTRACTOR SHALL BE RESPONSIBLE FOR REPAIR AND/OR PAYMENT OF ANY DAMAGED ITEMS TO REMAIN.
- CONTRACTOR SHALL VERIFY LOCATION OF ALL UNDERGROUND UTILITIES PRIOR TO BEGINNING WORK, BOTH PUBLIC AND PRIVATE. CONTRACTOR IS FULLY RESPONSIBLE FOR ALL UNDERGROUND UTILITIES AND SHALL REPAIR ANY DAMAGE AS A RESULT OF THIS CONTRACT.
- CONTRACTOR SHALL REPORT ANY ENCROACHMENTS OR DISCREPANCIES IMMEDIATELY TO ALFRED BENESCH & COMPANY FOR DECISION.
- NO SOIL DISTURBANCE OR COMPACTION, CONSTRUCTION MATERIALS, TRAFFIC, BURIAL PITS, TRENCHING OR OTHER LAND DISTURBING ACTIVITY ALLOWED IN EXISTING WOODED AREAS UNLESS SHOWN ON PLAN.
- CLEARING LIMITS ON THE PLAN INDICATE THE EXTENT OF ALL MAJOR CLEARING REQUIRED. CONTRACTOR IS ALSO RESPONSIBLE FOR ANY INCIDENTAL CLEARING REQUIRED FOR MINOR DISCREPANCIES IN GRADE, UTILITY OR STORM PIPE INSTALLATIONS, EROSION CONTROL MEASURES, ETC.
- FEMA FIRM PANEL NUMBER: 13117C0227F, 13117C0239F
DATE: 03/04/2013. THE FLOODPLAIN RUNS THROUGH THE CENTER OF THE CANEY CREEK PRESERVE ON EITHER SIDE OF CANEY CREEK. THIS AREA WILL REMAIN UNDISTURBED.

NOTIFY FORSYTH COUNTY INSPECTOR 24 HOURS BEFORE THE BEGINNING PHASE OF CONSTRUCTION. (770) 781-2165.

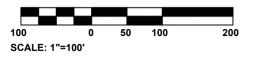

Seals:





Corp. NC License: F-1320

Caney Creek Preserve
2755 Caney Road, 3055 Caney Road
Forsyth County

Project No:	17.000291
Date:	01.08.20
Revisions:	
Per County Comments	01.31.20
Per County Comments	03.04.20
Per County Comments	04.27.20

Sheet Title:
**Overall Existing
Conditions/
Demolition
Plan**

Sheet No:
C100

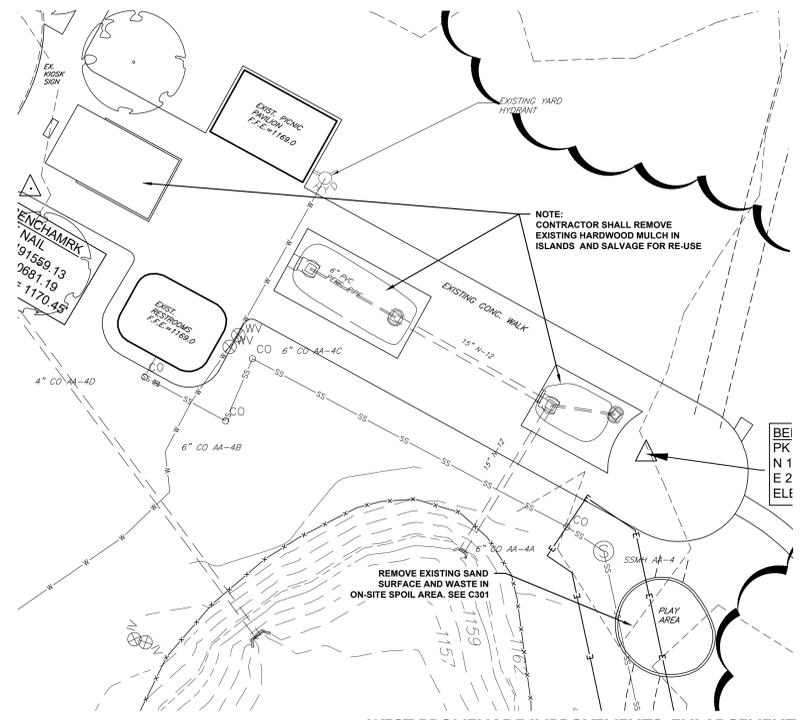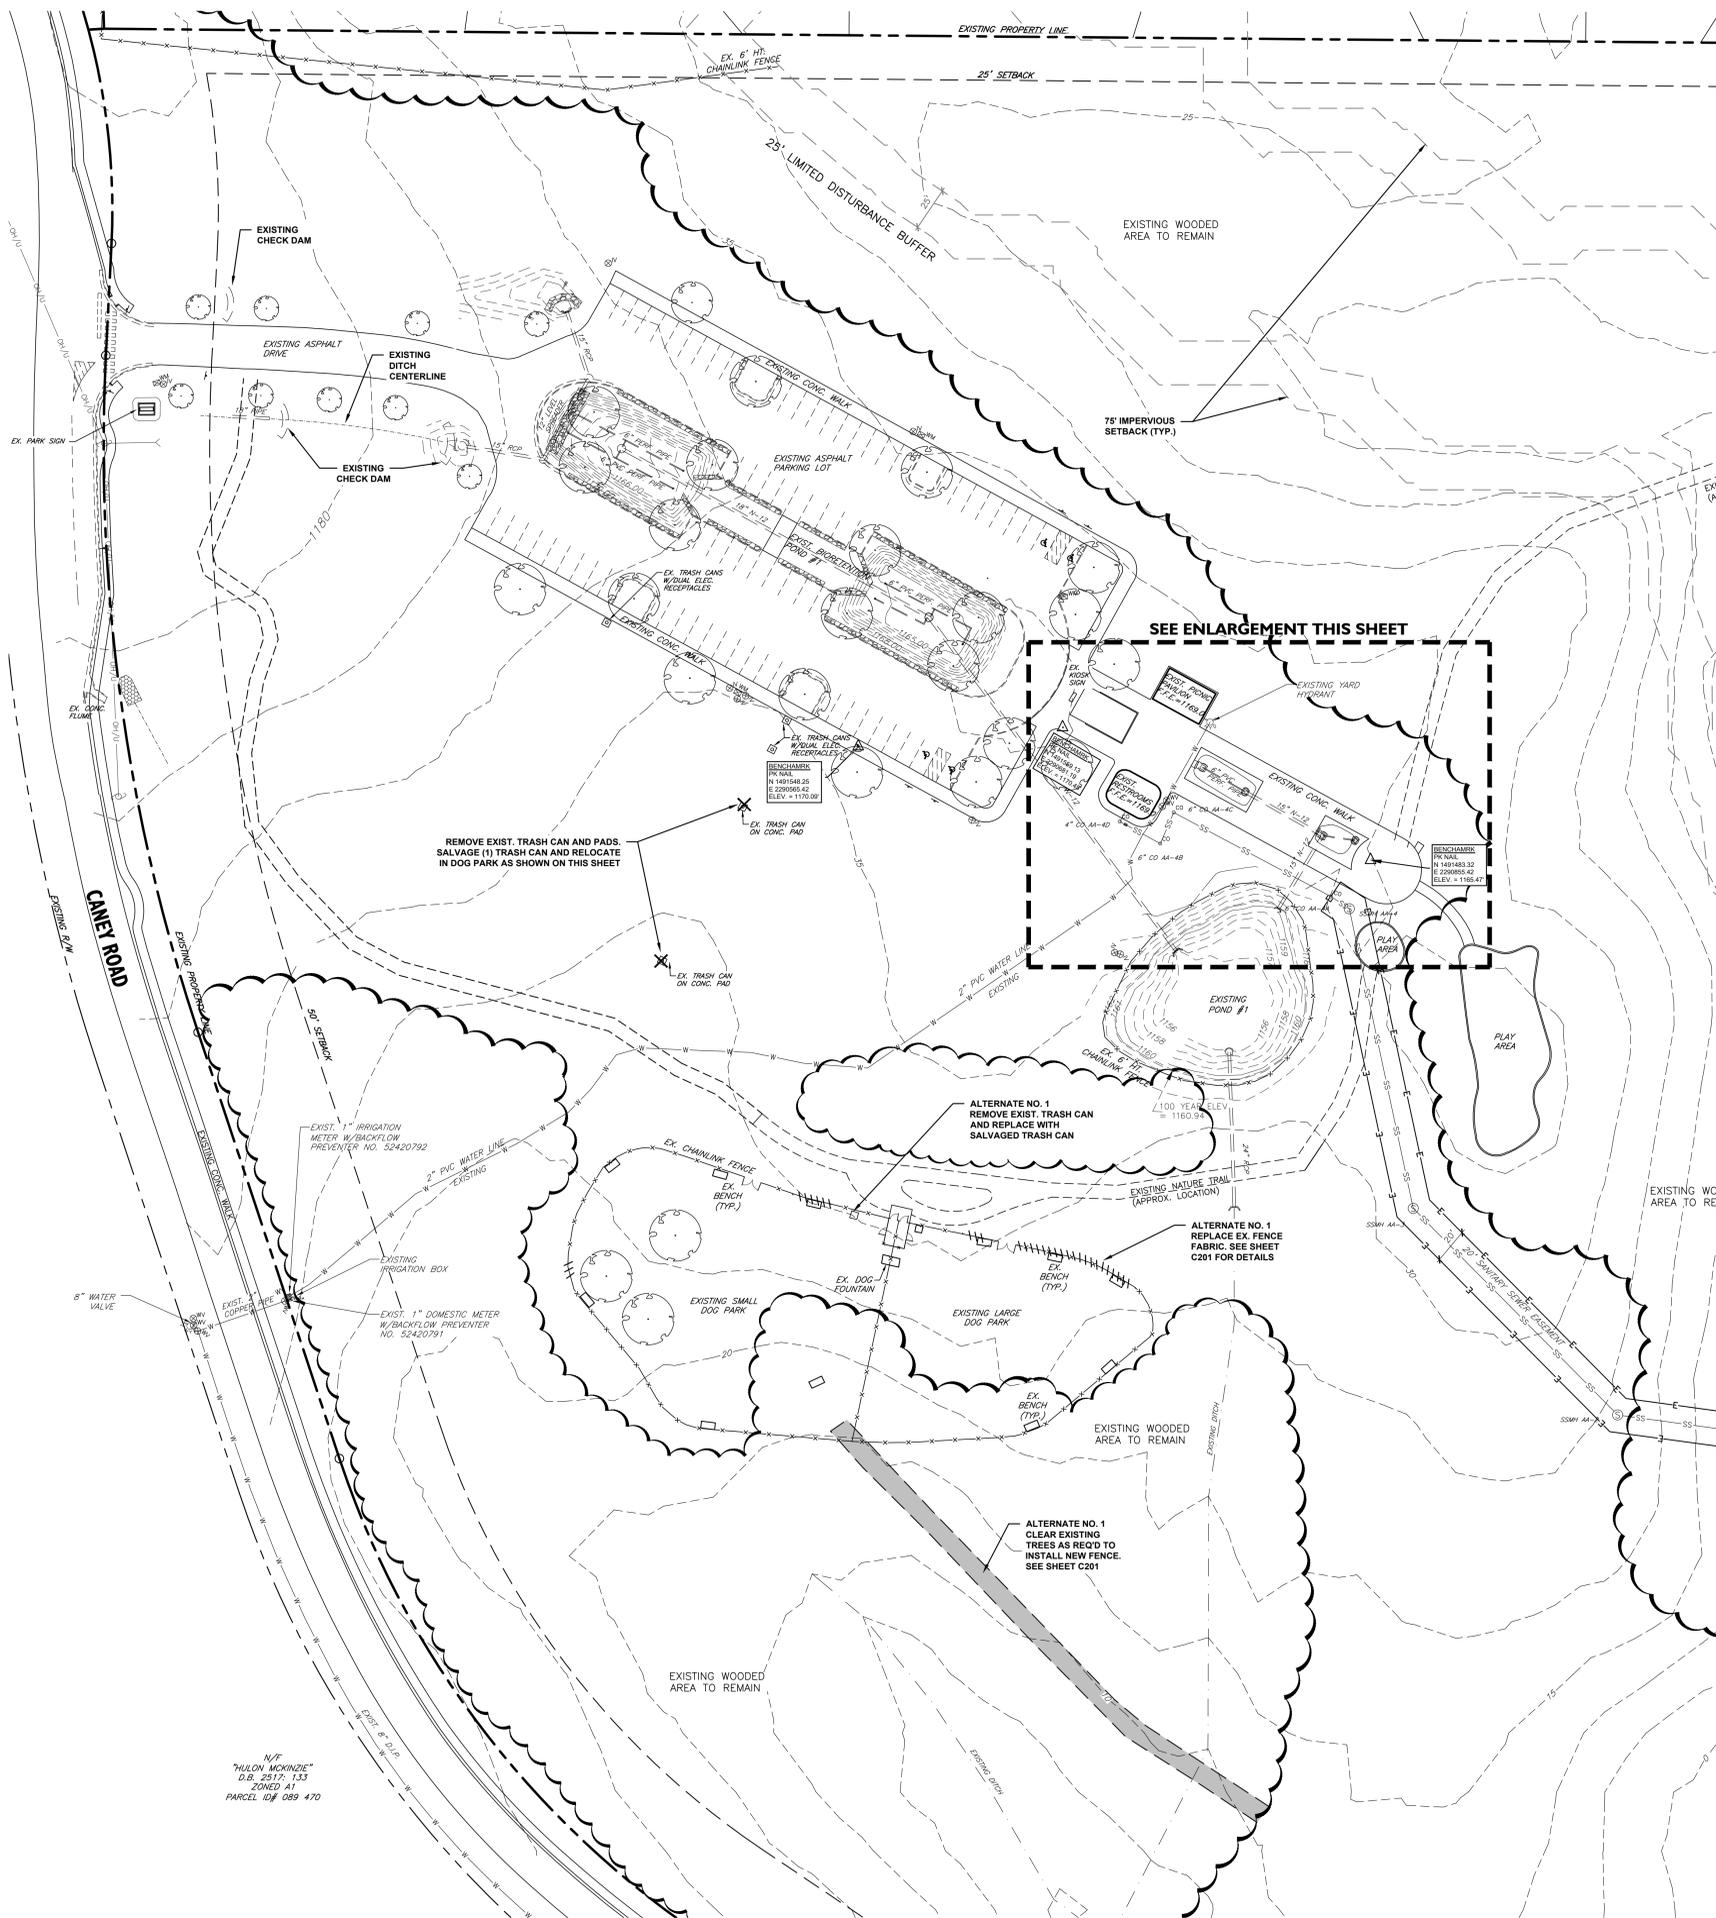


WEST PROMENADE IMPROVEMENTS ENLARGEMENT
SCALE 1"=20'

LEGEND

- X—X—X— EXISTING SIGN
- ⊙ EXISTING IRON PIN
- ⊙ EXISTING LIGHT POLE
- ⊙ EXISTING UTILITY POLE
- R/W RIGHT-OF-WAY
- HC ACCESSIBLE SPACE
- ⊙ EXISTING TREE TO REMAIN
- ⊗ EXISTING TREE TO BE REMOVED
- ⊙ EXISTING FIRE HYDRANT
- ⊙ EXISTING WATER VALVE
- ⊙ EXISTING WATER METER
- ⊙ EXISTING SEWER MANHOLE
- ⊙ EXISTING STORM MANHOLE
- ⊙ EXISTING DRAINAGE STRUCTURE
- ⊙ EXISTING CLEANOUT
- +XXX.X EXISTING SPOT ELEVATION
- ⊙ EXISTING GAS VALVE
- ⊙ EXISTING GAS METER
- X OR // EXISTING ITEMS TO BE REMOVED
- █ EXISTING TREES TO BE CLEARED
- - - SAWCUT LINE
- - - EXISTING CURB AND GUTTER
- - - PROPERTY LINE
- - - EXISTING FENCE
- - - EXISTING UNDERGROUND ELECTRIC LINE
- - - EXISTING OVERHEAD ELECTRIC LINE
- - - EXISTING UNDERGROUND TELEPHONE LINE
- - - EXISTING FIBER OPTIC LINE
- - - EXISTING SANITARY SEWER LINE
- - - EXISTING WATER LINE
- - - EXISTING GAS LINE
- - - EXISTING CONTOUR LINE
- - - EXISTING TREELINE
- - - EXISTING EASEMENT

NOTIFY FORSYTH COUNTY INSPECTOR 24 HOURS BEFORE THE BEGINNING PHASE OF CONSTRUCTION. (770) 761-2166.

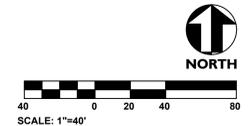

Seals:



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2755 Caney Road, 3055 Caney Road
Forsyth County

Project No: 17.000291
Date: 01.08.20



Revisions:

Per County Comments	01.31.20
Per County Comments	03.04.20
Per County Comments	04.27.20

Sheet Title:
**Existing Conditions/
Demolition Plan
Enlargement-
West**

Sheet No:
CI01

N/F "MILON MCKENZIE"
D.B. 2517, 133
PARCEL 089 089 470

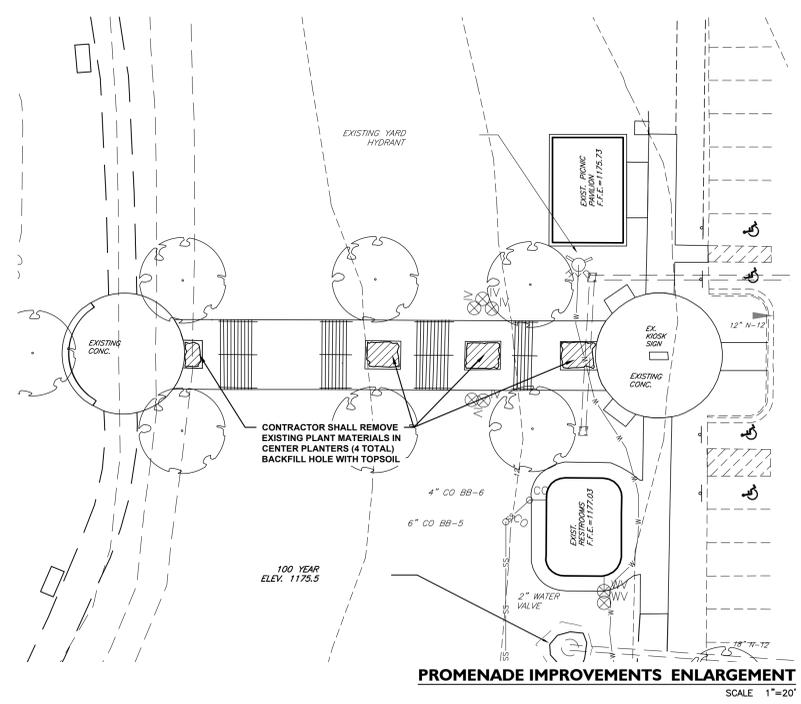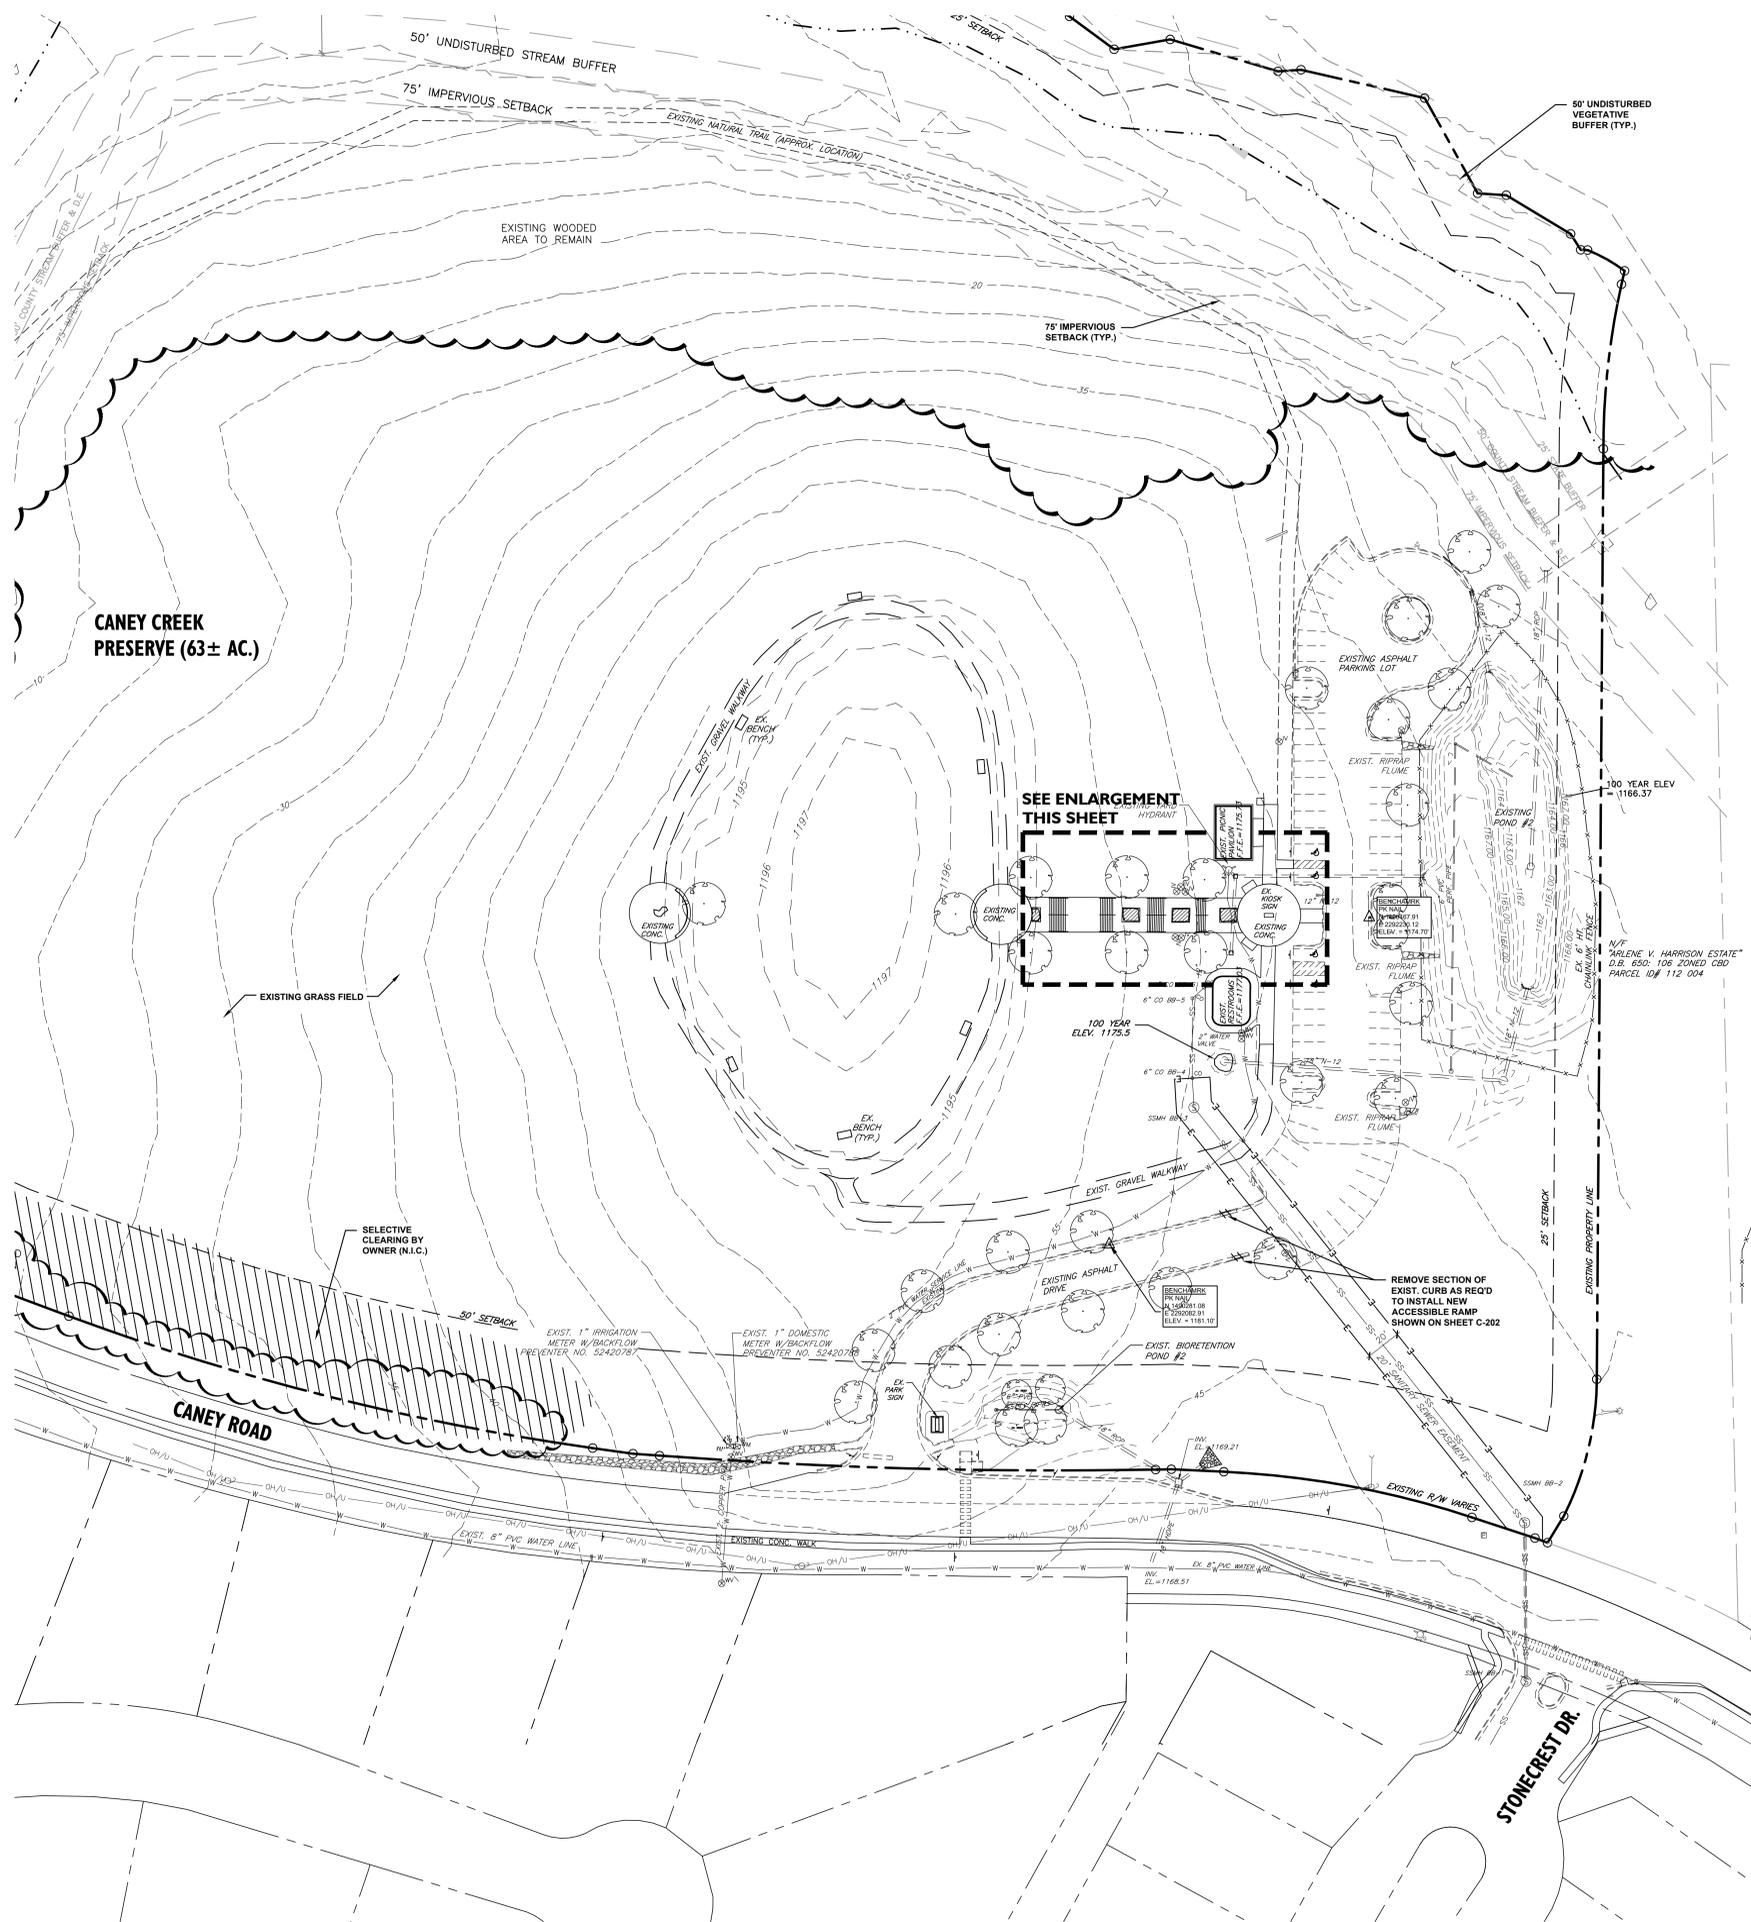

CANEY CREEK PRESERVE (63± AC.)

SEE ENLARGEMENT THIS SHEET

PROMENADE IMPROVEMENTS ENLARGEMENT
SCALE 1"=20'

LEGEND			
—	EXISTING SIGN	✕ OR //	EXISTING ITEMS TO BE REMOVED
EIP	EXISTING IRON PIN	---	SAW CUT LINE
*	EXISTING LIGHT POLE	---	EXISTING CURB AND GUTTER
○	EXISTING UTILITY POLE	---	PROPERTY LINE
R/W	RIGHT-OF-WAY	---	EXISTING FENCE
HC	ACCESSIBLE SPACE	---	EXISTING UNDERGROUND ELECTRIC LINE
○	EXISTING TREE TO REMAIN	OH/U	EXISTING OVERHEAD ELECTRIC LINE
✕	EXISTING TREE TO BE REMOVED	T	EXISTING UNDERGROUND TELEPHONE LINE
⊗	EXISTING FIRE HYDRANT	FO/C	EXISTING FIBER OPTIC LINE
⊙	EXISTING WATER VALVE	SS	EXISTING SANITARY SEWER LINE
⊙	EXISTING WATER METER	W	EXISTING WATER LINE
⊙	EXISTING SEWER MANHOLE	G	EXISTING GAS LINE
⊙	EXISTING STORM MANHOLE	XXX	EXISTING CONTOUR LINE
□	EXISTING DRAINAGE STRUCTURE	---	EXISTING TREELINE
+	EXISTING CLEANOUT	E	EXISTING EASEMENT
+XXX.X	EXISTING SPOT ELEVATION		
⊙	EXISTING GAS VALVE		
⊙	EXISTING GAS METER		



Corp. NC License: F-1320


Caney Creek Preserve
2755 Caney Road, 3055 Caney Road
Forsyth County



Project No:	17.000291
Date:	01.08.20
Revisions:	
Per County Comments	01.31.20
Per County Comments	03.04.20
Per County Comments	04.27.20

Sheet Title:
**Existing Conditions/
Demolition Plan
Enlargement-
East**

Sheet No:
C102

NOTIFY FORSYTH COUNTY INSPECTOR 24 HOURS BEFORE THE BEGINNING PHASE OF CONSTRUCTION. (770) 781-2165.

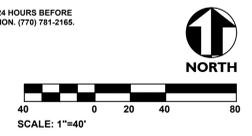

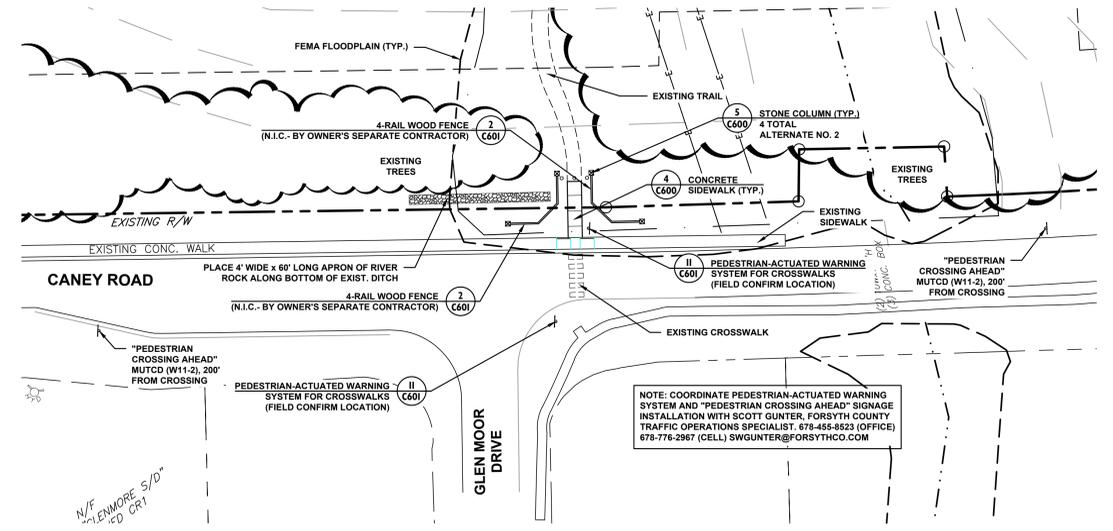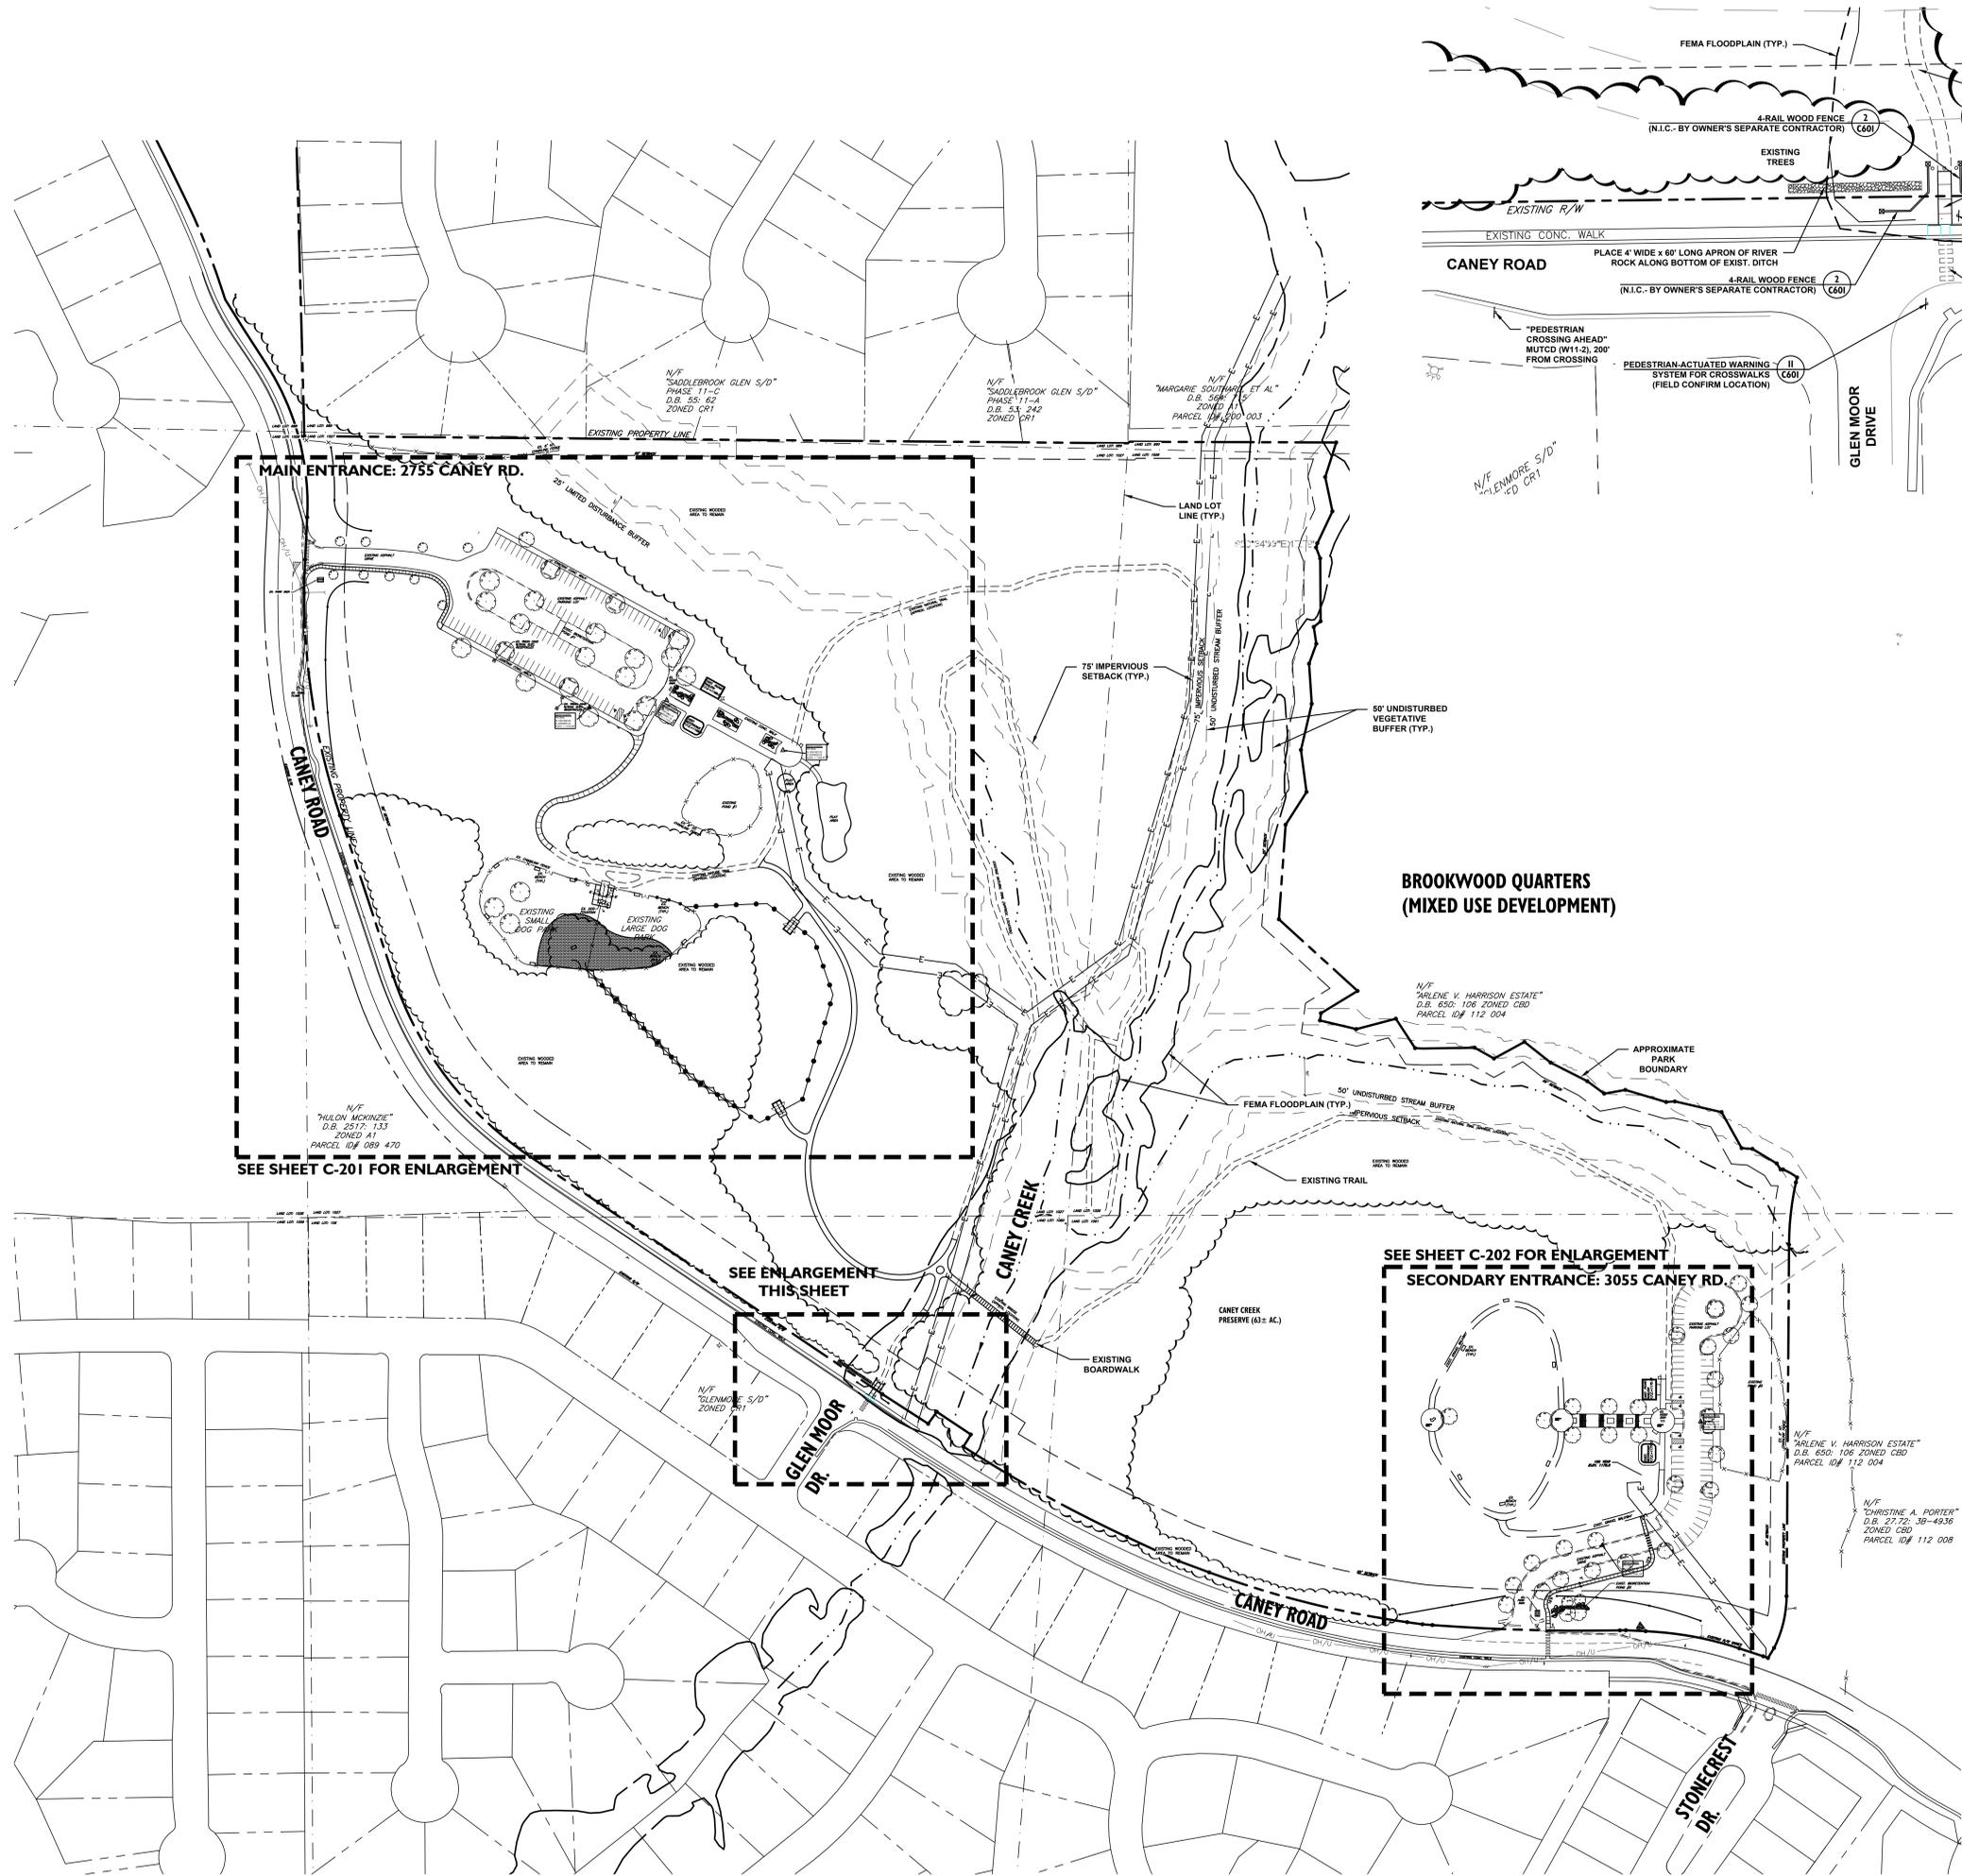

SOUTH PEDESTRIAN GATEWAY ENLARGEMENT
SCALE: 1"=30'
NORTH

NOTE: FIELD CONFIRM WIDTH OF EXISTING SANITARY SEWER EASEMENT WITH FORSYTH COUNTY ENGINEERING DEPARTMENT PRIOR TO CONSTRUCTION OF STONE COLUMNS AND FENCE.

SITE NOTES

- DIMENSIONS AND COORDINATE POINTS ARE TO FACE OF CURB, EDGE OF PAVEMENT, OR CORNER OF BUILDING UNLESS OTHERWISE NOTED.
- ALL IMPROVEMENTS AND CONSTRUCTION SHALL BE IN ACCORDANCE WITH STATE AND LOCAL STANDARDS.
- ANY DISCREPANCIES FOUND IN THE FIELD SHALL BE CALLED TO THE ATTENTION OF THE OWNER OR ENGINEER PRIOR TO PROCEEDING WITH WORK.
- PRIOR TO BEGINNING CONSTRUCTION, UNLESS OTHERWISE PROVIDED IN THE CONTRACT DOCUMENTS, THE CONTRACTOR SHALL SECURE AND PAY FOR ALL PERMITS BOTH SITE AND BUILDING RELATED INCLUDING BUT NOT LIMITED TO REGULATORY FEES, LICENSES, AND INSPECTIONS NECESSARY FOR PROPER EXECUTION AND COMPLETION OF THE WORK.
- THE GENERAL CONTRACTOR SHALL CONTACT ALL OWNERS OF EASEMENTS, UTILITIES, AND RIGHT-OF-WAYS, PUBLIC AND PRIVATE, PRIOR TO WORKING IN THESE AREAS.
- GENERAL CONTRACTOR SHALL MAINTAIN THE SITE IN A MANNER SO THAT WORKMEN AND THE PUBLIC SHALL BE PROTECTED FROM INJURY.
- USE CAUTION WHEN REPRODUCING COPIES OF THE CONSTRUCTION DRAWINGS. COPIES ARE SUBJECT TO DISTORTION AND INACCURACY IN THE SCALE OF DRAWINGS. VERIFY ANY DISCREPANCIES WITH BENESCH.
- ALL SIGNS, PAVEMENT MARKINGS, AND OTHER TRAFFIC CONTROL DEVICES SHALL CONFORM TO THE MANUAL ON UNIFORM TRAFFIC CONTROL DEVICES (MUTCD), LATEST EDITION AS AMENDED.
- ALL PAVEMENT MARKINGS SHALL BE FOUR (4) INCHES WIDE UNLESS INDICATED OTHERWISE ON THE DRAWINGS.
- CONTRACTOR SHALL FURNISH AND INSTALL ALL PAVEMENT MARKINGS AS SHOWN ON THE PLANS.
- THE ENGINEER WILL PROVIDE THE CONTRACTOR WITH AN ELECTRONIC FILE OF THESE DRAWINGS UPON REQUEST.
- STOP BEFORE YOU DIG. CALL 811. IT'S THE LAW.

GENERAL NOTES


- CONSTRUCTION WASTE AND/OR VEGETATIVE MATERIAL MAY BE BURNED OR BURIED AND MUST BE TAKEN TO A STATE APPROVED LANDFILL.
- PER UDC 10-1-13 OUTSIDE CONSTRUCTION SHALL BE LIMITED TO THE HOURS OF 7:00 AM TO 7:00 PM MONDAY TO FRIDAY; 8:00 AM TO 6:00 PM SATURDAY; AND THERE WILL BE NO OUTSIDE CONSTRUCTION ON SUNDAY.
- ALL STRUCTURES WILL COMPLY WITH THE FIRE SEPARATION DISTANCE REQUIREMENTS OF THE INTERNATIONAL BUILDING CODE AS ADOPTED AND AMENDED BY THE GA DEPARTMENT OF COMMUNITY AFFAIRS. APPROVAL OF THIS PERMIT WILL NOT JUSTIFY ANY OVIATION FROM THE FIRE SEPARATION DISTANCES.
- REQUIRED LANDSCAPING MUST BE IN PLACE PRIOR TO THE APPROVAL OF AN AS-BUILT.
- AS-BUILT REQUIRED FOR CO PRIOR TO FINAL BUILDING INSPECTION.



FORSYTH COUNTY DEPARTMENT OF ENGINEERING NOTES

- ALL IMPROVEMENTS TO CONFORM WITH FORSYTH COUNTY CONSTRUCTION STANDARDS AND SPECIFICATIONS, LATEST EDITION.
- NO STRUCTURES, FENCES, OR OTHER OBSTRUCTIONS MAY BE LOCATED WITHIN A DRAINAGE OR ACCESS EASEMENT WITHOUT PRIOR APPROVAL BY THE FORSYTH COUNTY DEPARTMENT OF ENGINEERING.
- APPROVAL OF THESE PLANS DOES NOT CONSTITUTE APPROVAL BY FORSYTH COUNTY OF ANY LAND DISTURBING ACTIVITIES WITHIN WETLAND AREAS. IT IS THE RESPONSIBILITY OF THE PROPERTY OWNER TO CONTACT THE APPROPRIATE REGULATORY AGENCY FOR APPROVAL OF ANY WETLAND DISTURBANCE.
- NOTIFY FORSYTH COUNTY INSPECTOR 24 HOURS BEFORE THE BEGINNING PHASE OF CONSTRUCTION. (770) 781-2165.
- APPROVAL OF THESE PLANS IS SUBJECT TO, AND CONTINGENT UPON THE APPLICANT OBTAINING ANY AND ALL NECESSARY APPROVALS FROM ANY AND ALL APPLICABLE AGENCIES INCLUDING, BUT NOT LIMITED TO THE UNITED STATES ARMY CORPS OF ENGINEERS, THE UNITED STATES ENVIRONMENTAL PROTECTION AGENCY, USDA-NRCS, GEORGIA DEPARTMENT OF NATURAL RESOURCES, GEORGIA ENVIRONMENTAL PROTECTION DIVISION, AND THE GEORGIA SOIL AND WATER CONSERVATION COMMISSION.
- ALL UNDISTURBED BUFFERS SHALL BE IDENTIFIED WITH ORANGE, FOUR-FOOT TREE-SAVE FENCING PRIOR TO ANY LAND DISTURBANCE (UDC SEC. 18-10.1).

Total Area: 61.97 Acres
Total Area Disturbed: 2.0 Acres

Project No:	17.000291
Date:	01.08.20
Revisions:	
Per County Comments	01.31.20
Per County Comments	03.04.20
Per County Comments	04.27.20

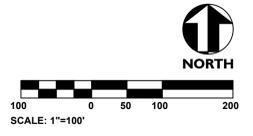

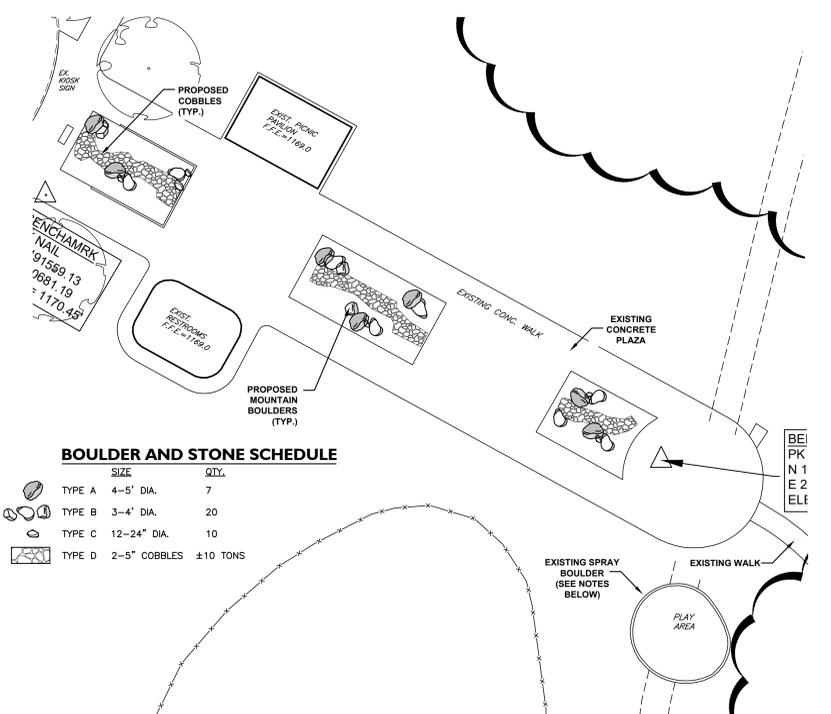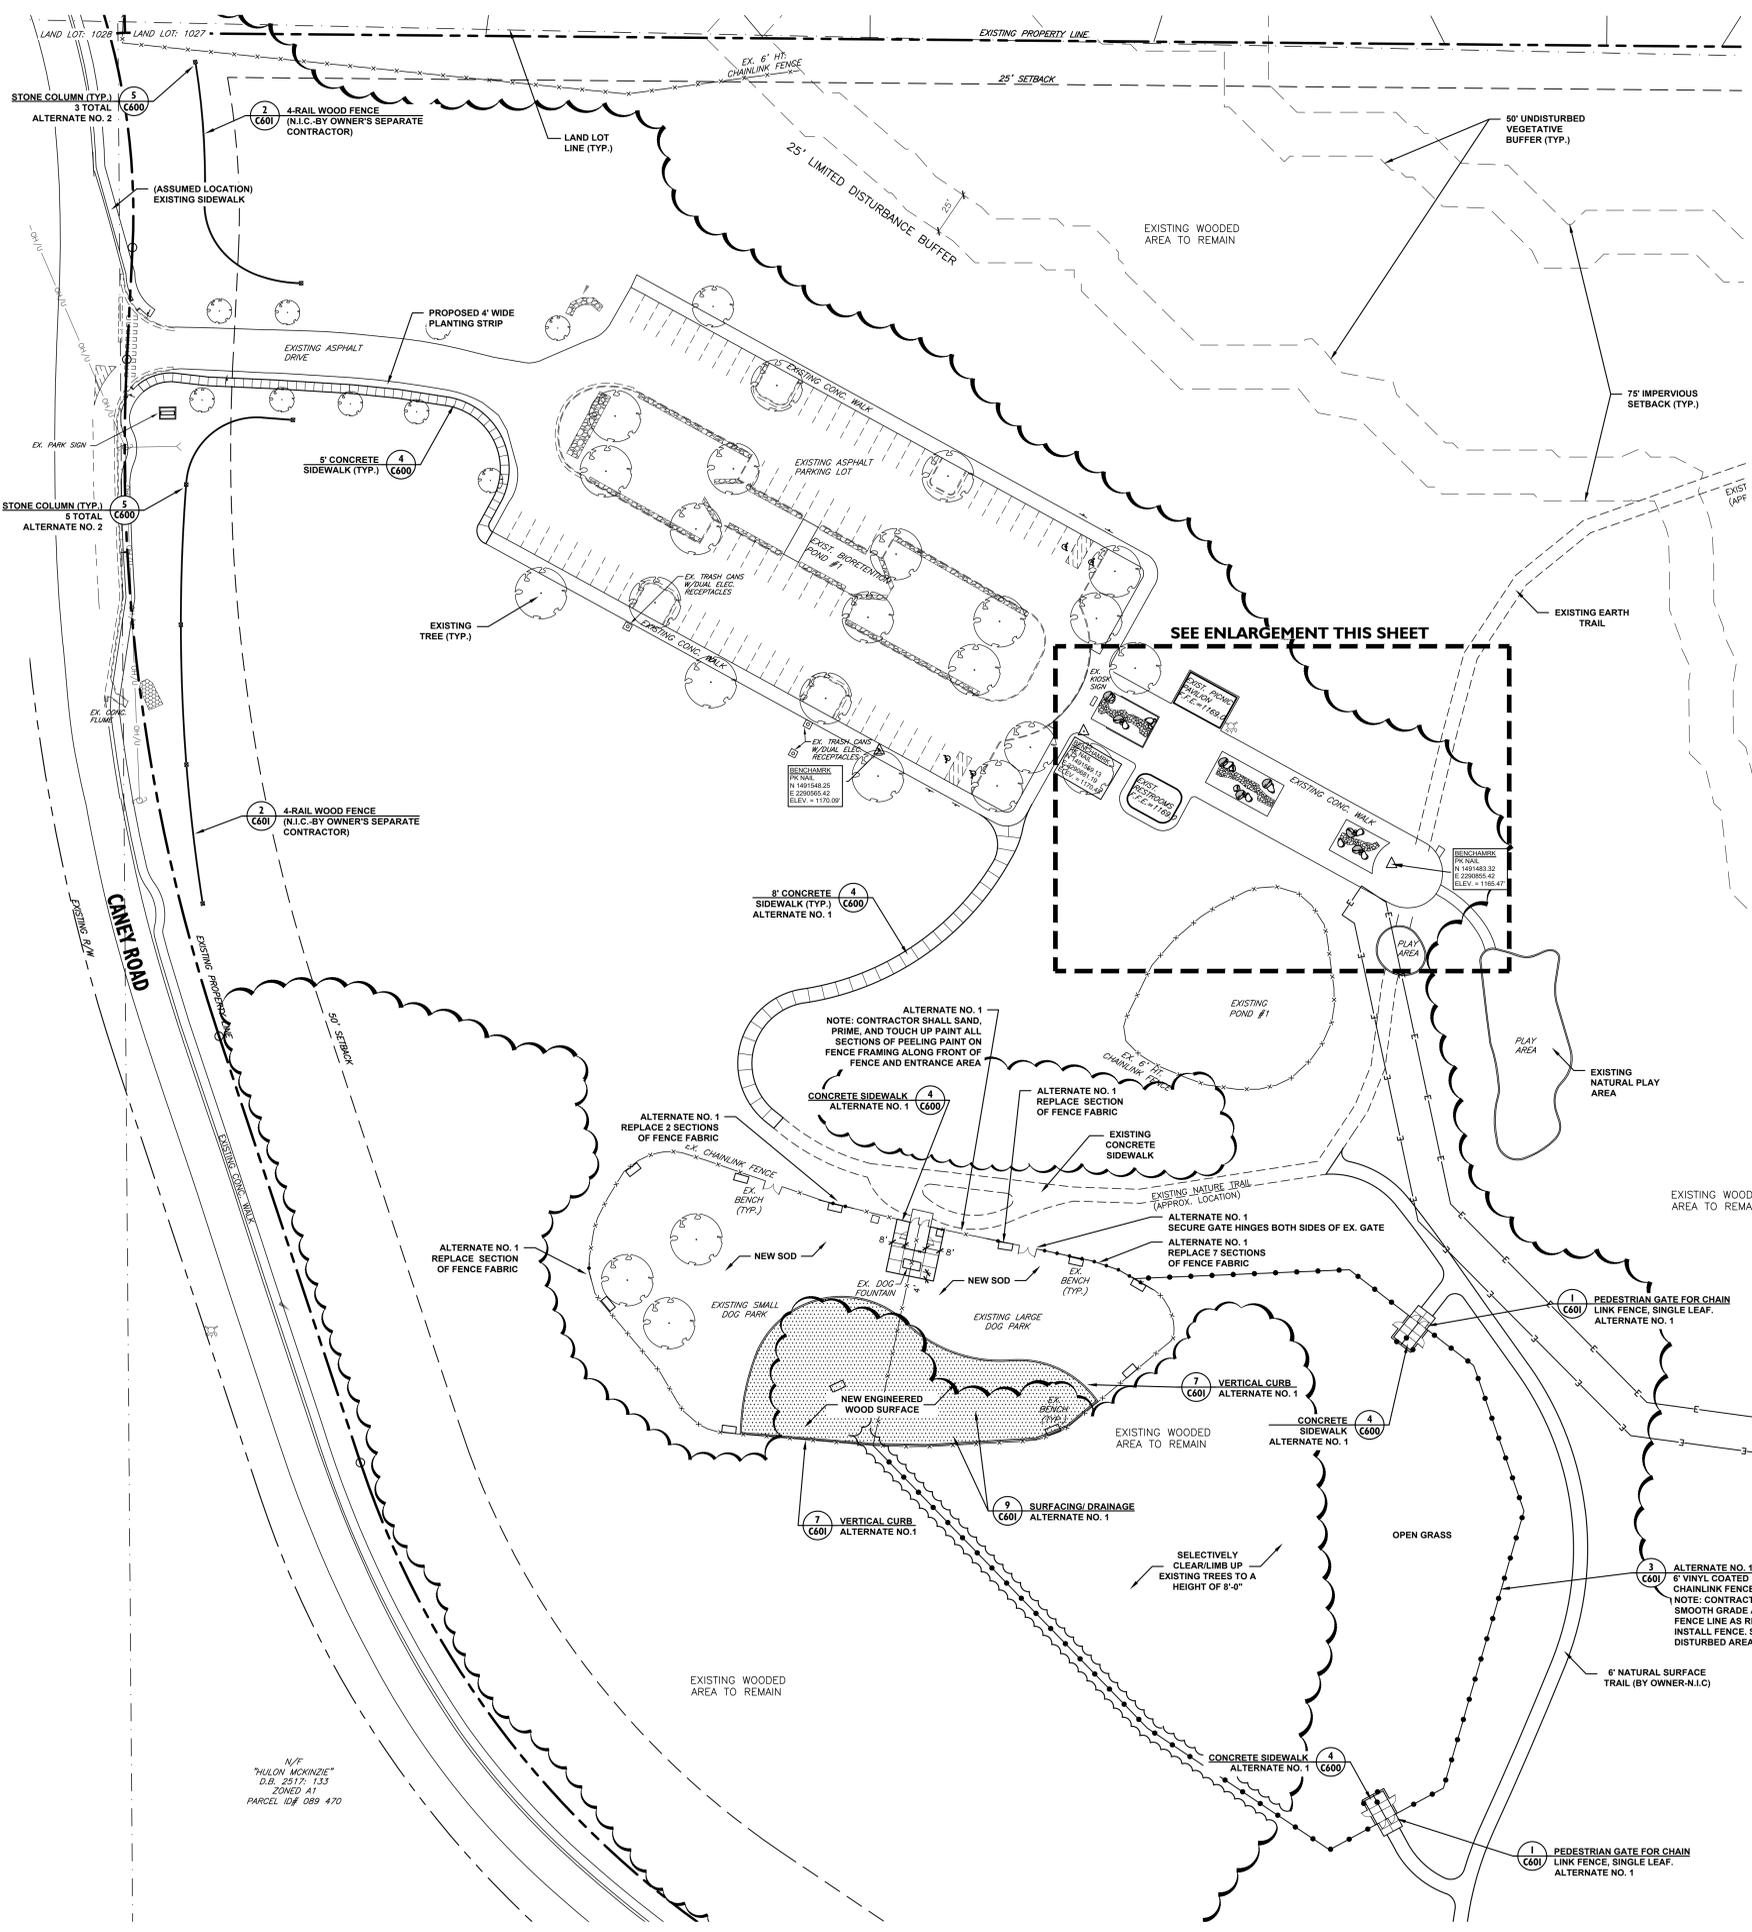

BOULDER AND STONE SCHEDULE

SIZE	QTY.
TYPE A 4-5' DIA.	7
TYPE B 3-4' DIA.	20
TYPE C 12-24' DIA.	10
TYPE D 2-5" COBBLES	±10 TONS


WEST PROMENADE IMPROVEMENTS ENLARGEMENT
SCALE 1"=20'

SPRAY BOULDER
REPAIR EXISTING SPRAY BOULDER WATER FEATURE.
WORK INCLUDES:
1) REMOVE PLAY SAND AND USE AS FILL IN OPEN SPACE AREA BY PARKING LOT.
2) INSTALL RUBBER PLAY SURFACE & DRAINAGE SYSTEM.
3) REPAIR/REPLACE SPRAY FEATURE ACTIVATION BUTTON.

LEGEND

- EXISTING SIGN
- PROPOSED SIGN
- EIP EXISTING IRON PIN
- ⊙ EXISTING LIGHT POLE
- ⊙ EXISTING UTILITY POLE
- R/W RIGHT-OF-WAY
- HC ACCESSIBLE SPACE
- ⊙ EXISTING TREE TO REMAIN
- ⊙ EXISTING FIRE HYDRANT
- ⊙ # OF PARKING SPACES
- ⊙ CENTERLINE
- ⊙ ACCESSIBLE RAMP
- ⊙ PROPOSED BOLLARD
- ⊙ EXISTING CURB AND GUTTER
- PROPERTY LINE
- EXISTING EASEMENT
- EXISTING FENCE
- PROPOSED FENCE
- EXISTING OVERHEAD UTILITY LINE
- LAND LOT LINES
- EXISTING ASPHALT PAVEMENT

NOTIFY FORSYTH COUNTY INSPECTOR 24 HOURS BEFORE THE BEGINNING PHASE OF CONSTRUCTION. (770) 781-2165.

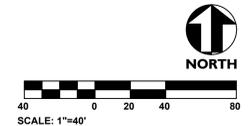

N/F
"MILON MCKENZIE"
D.B. 2517, 1.33
ZONED A1
PARCEL ID# 089 470



Corp. NC License: F-1320

Caney Creek Preserve
2755 Caney Road, 3055 Caney Road
Forsyth County


Project No: 17.000291
Date: 01.08.20

Revisions:

- Per County Comments 01.31.20
- Per County Comments 03.04.20
- Per County Comments 04.27.20

Sheet Title:
**Site Plan
Enlargement-
West**

Sheet No:
C201

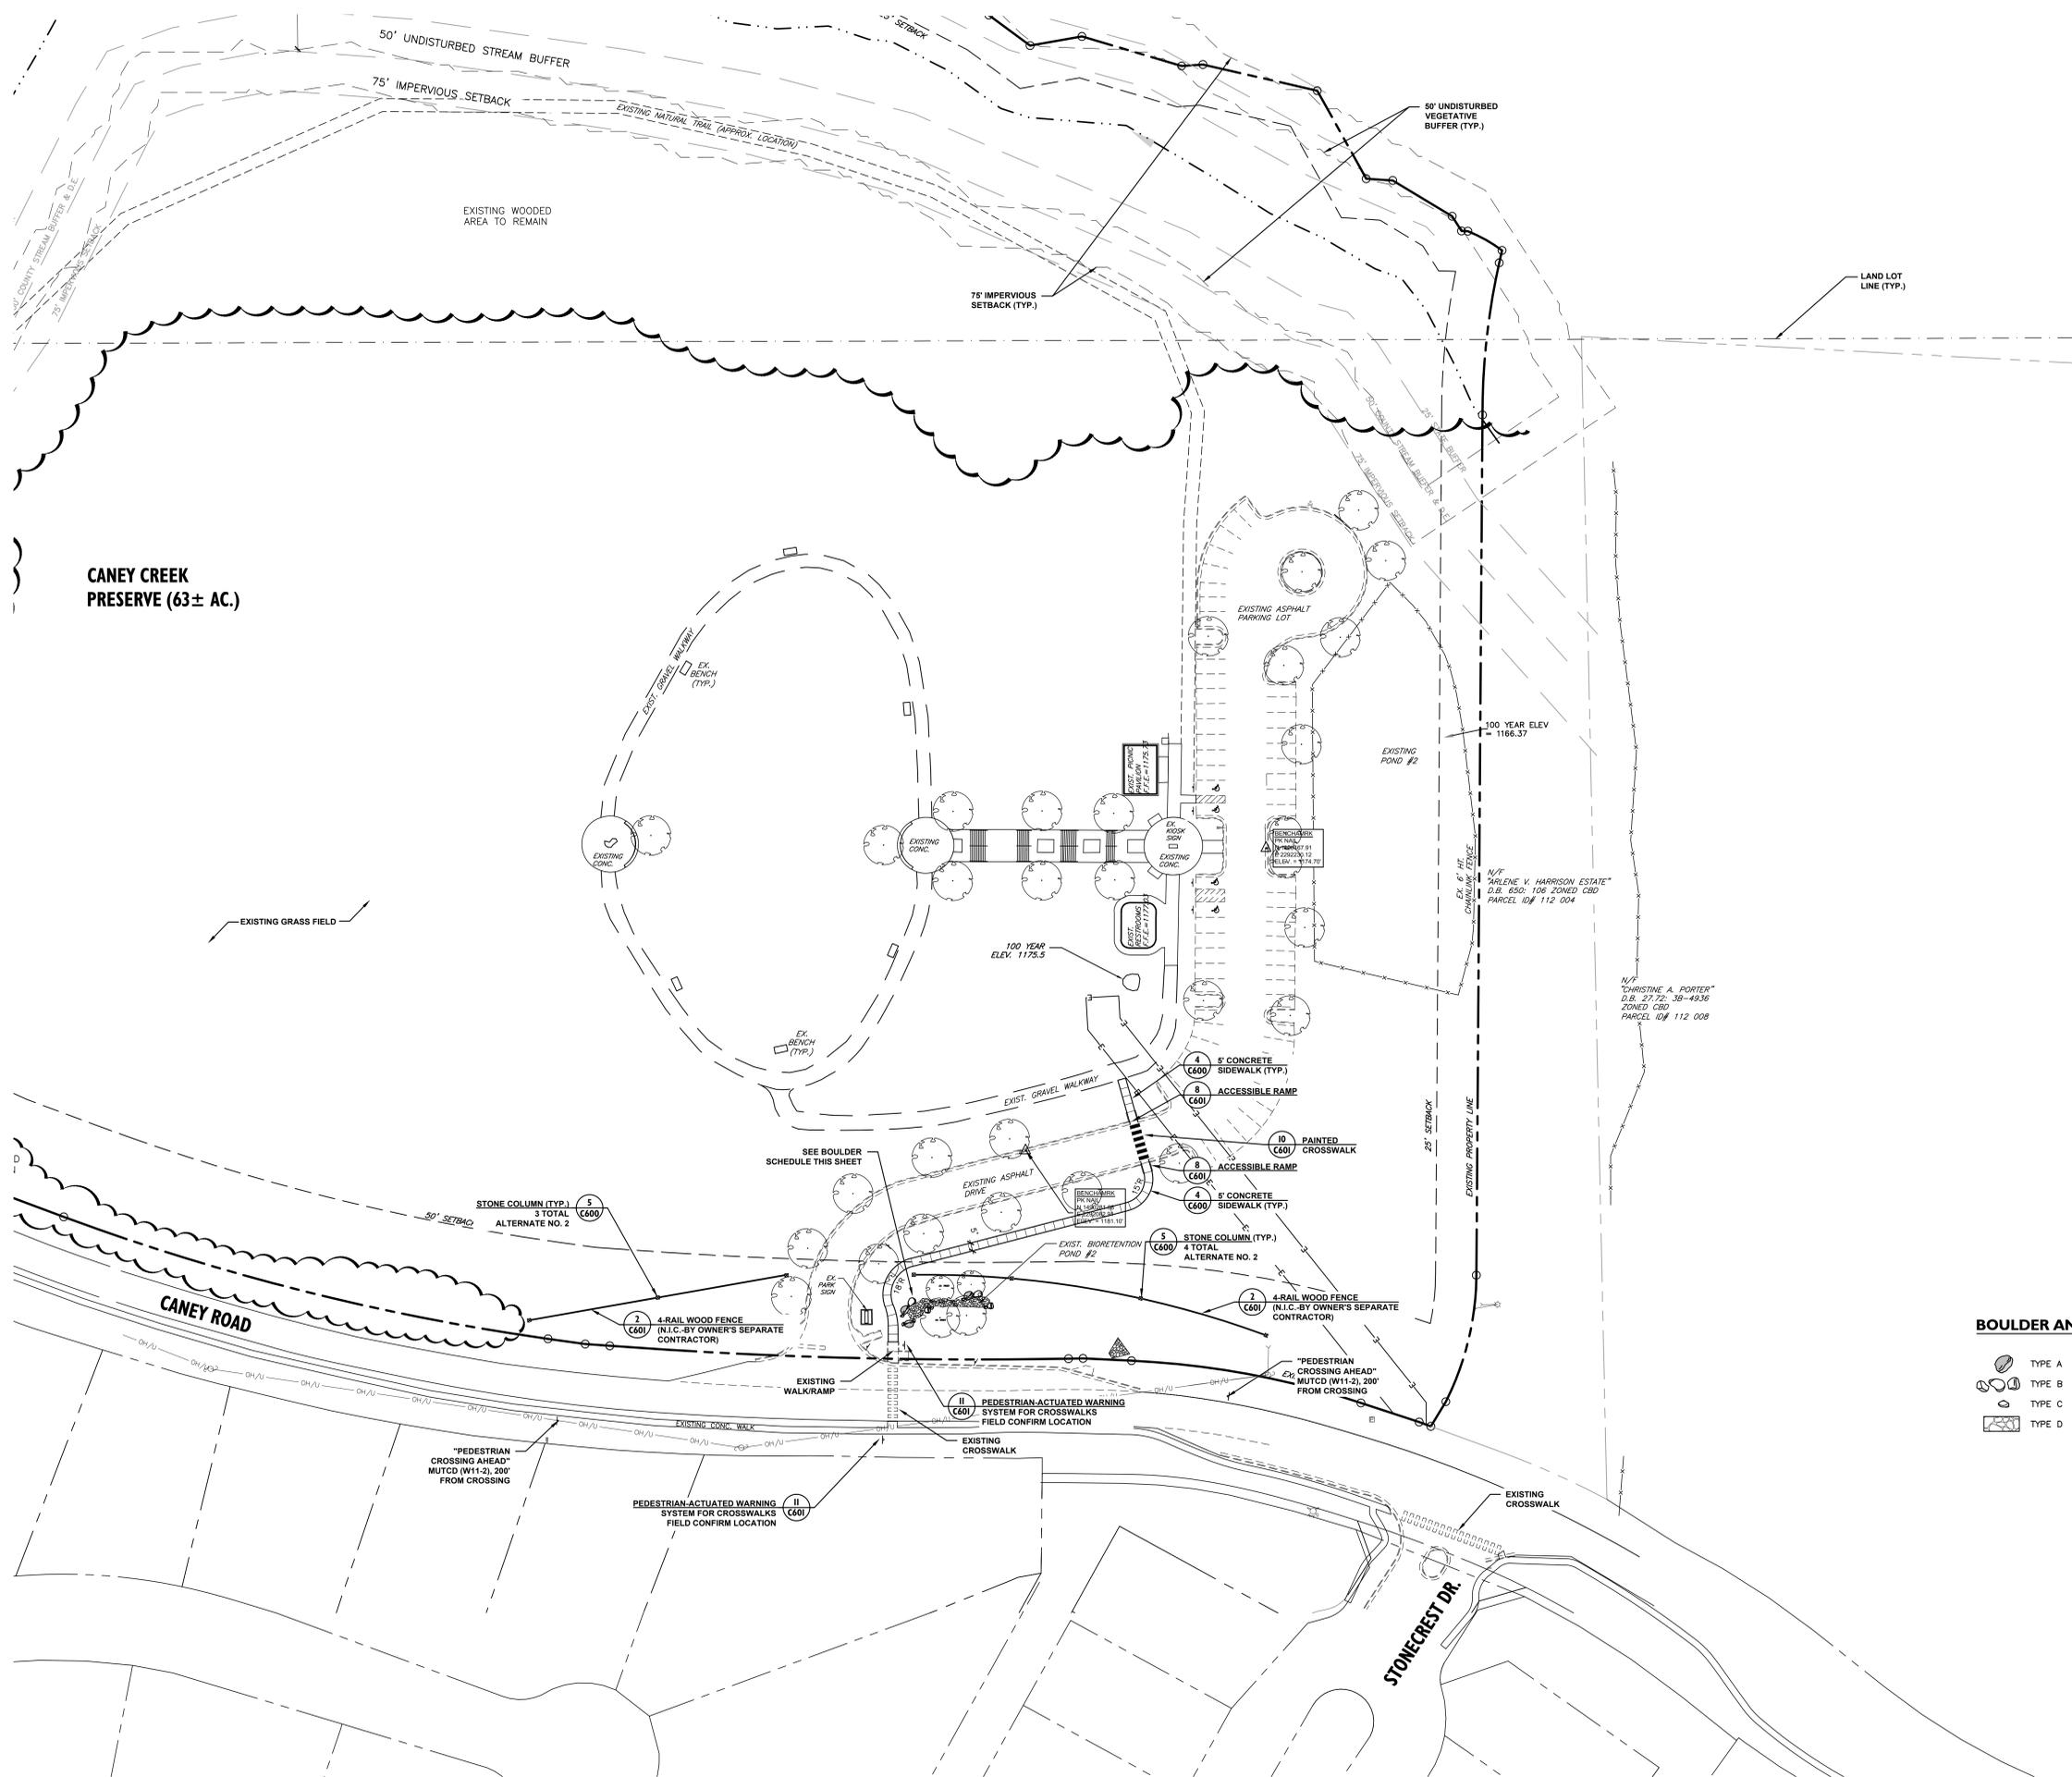


CANEY CREEK PRESERVE (63± AC.)

BOULDER AND STONE SCHEDULE

	SIZE	QTY.
●	TYPE A 4-5" DIA.	3
○	TYPE B 3-4" DIA.	4
○	TYPE C 12-24" DIA.	7
□	TYPE D 2-5" COBBLES	±5 TONS

NOTIFY FORSYTH COUNTY INSPECTOR 24 HOURS BEFORE THE BEGINNING PHASE OF CONSTRUCTION. (770) 791-2166.

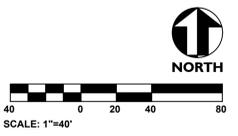

Seals:



Corp. NC License: F-1320

Caney Creek Preserve
 2755 Caney Road, 3055 Caney Road
 Forsyth County


Project No: 17.000291
 Date: 01.08.20

Revisions:

Per County Comments	01.31.20
Per County Comments	03.04.20
Per County Comments	04.27.20

Sheet Title:
**Site Plan
 Enlargement-
 East**

Sheet No:
C202

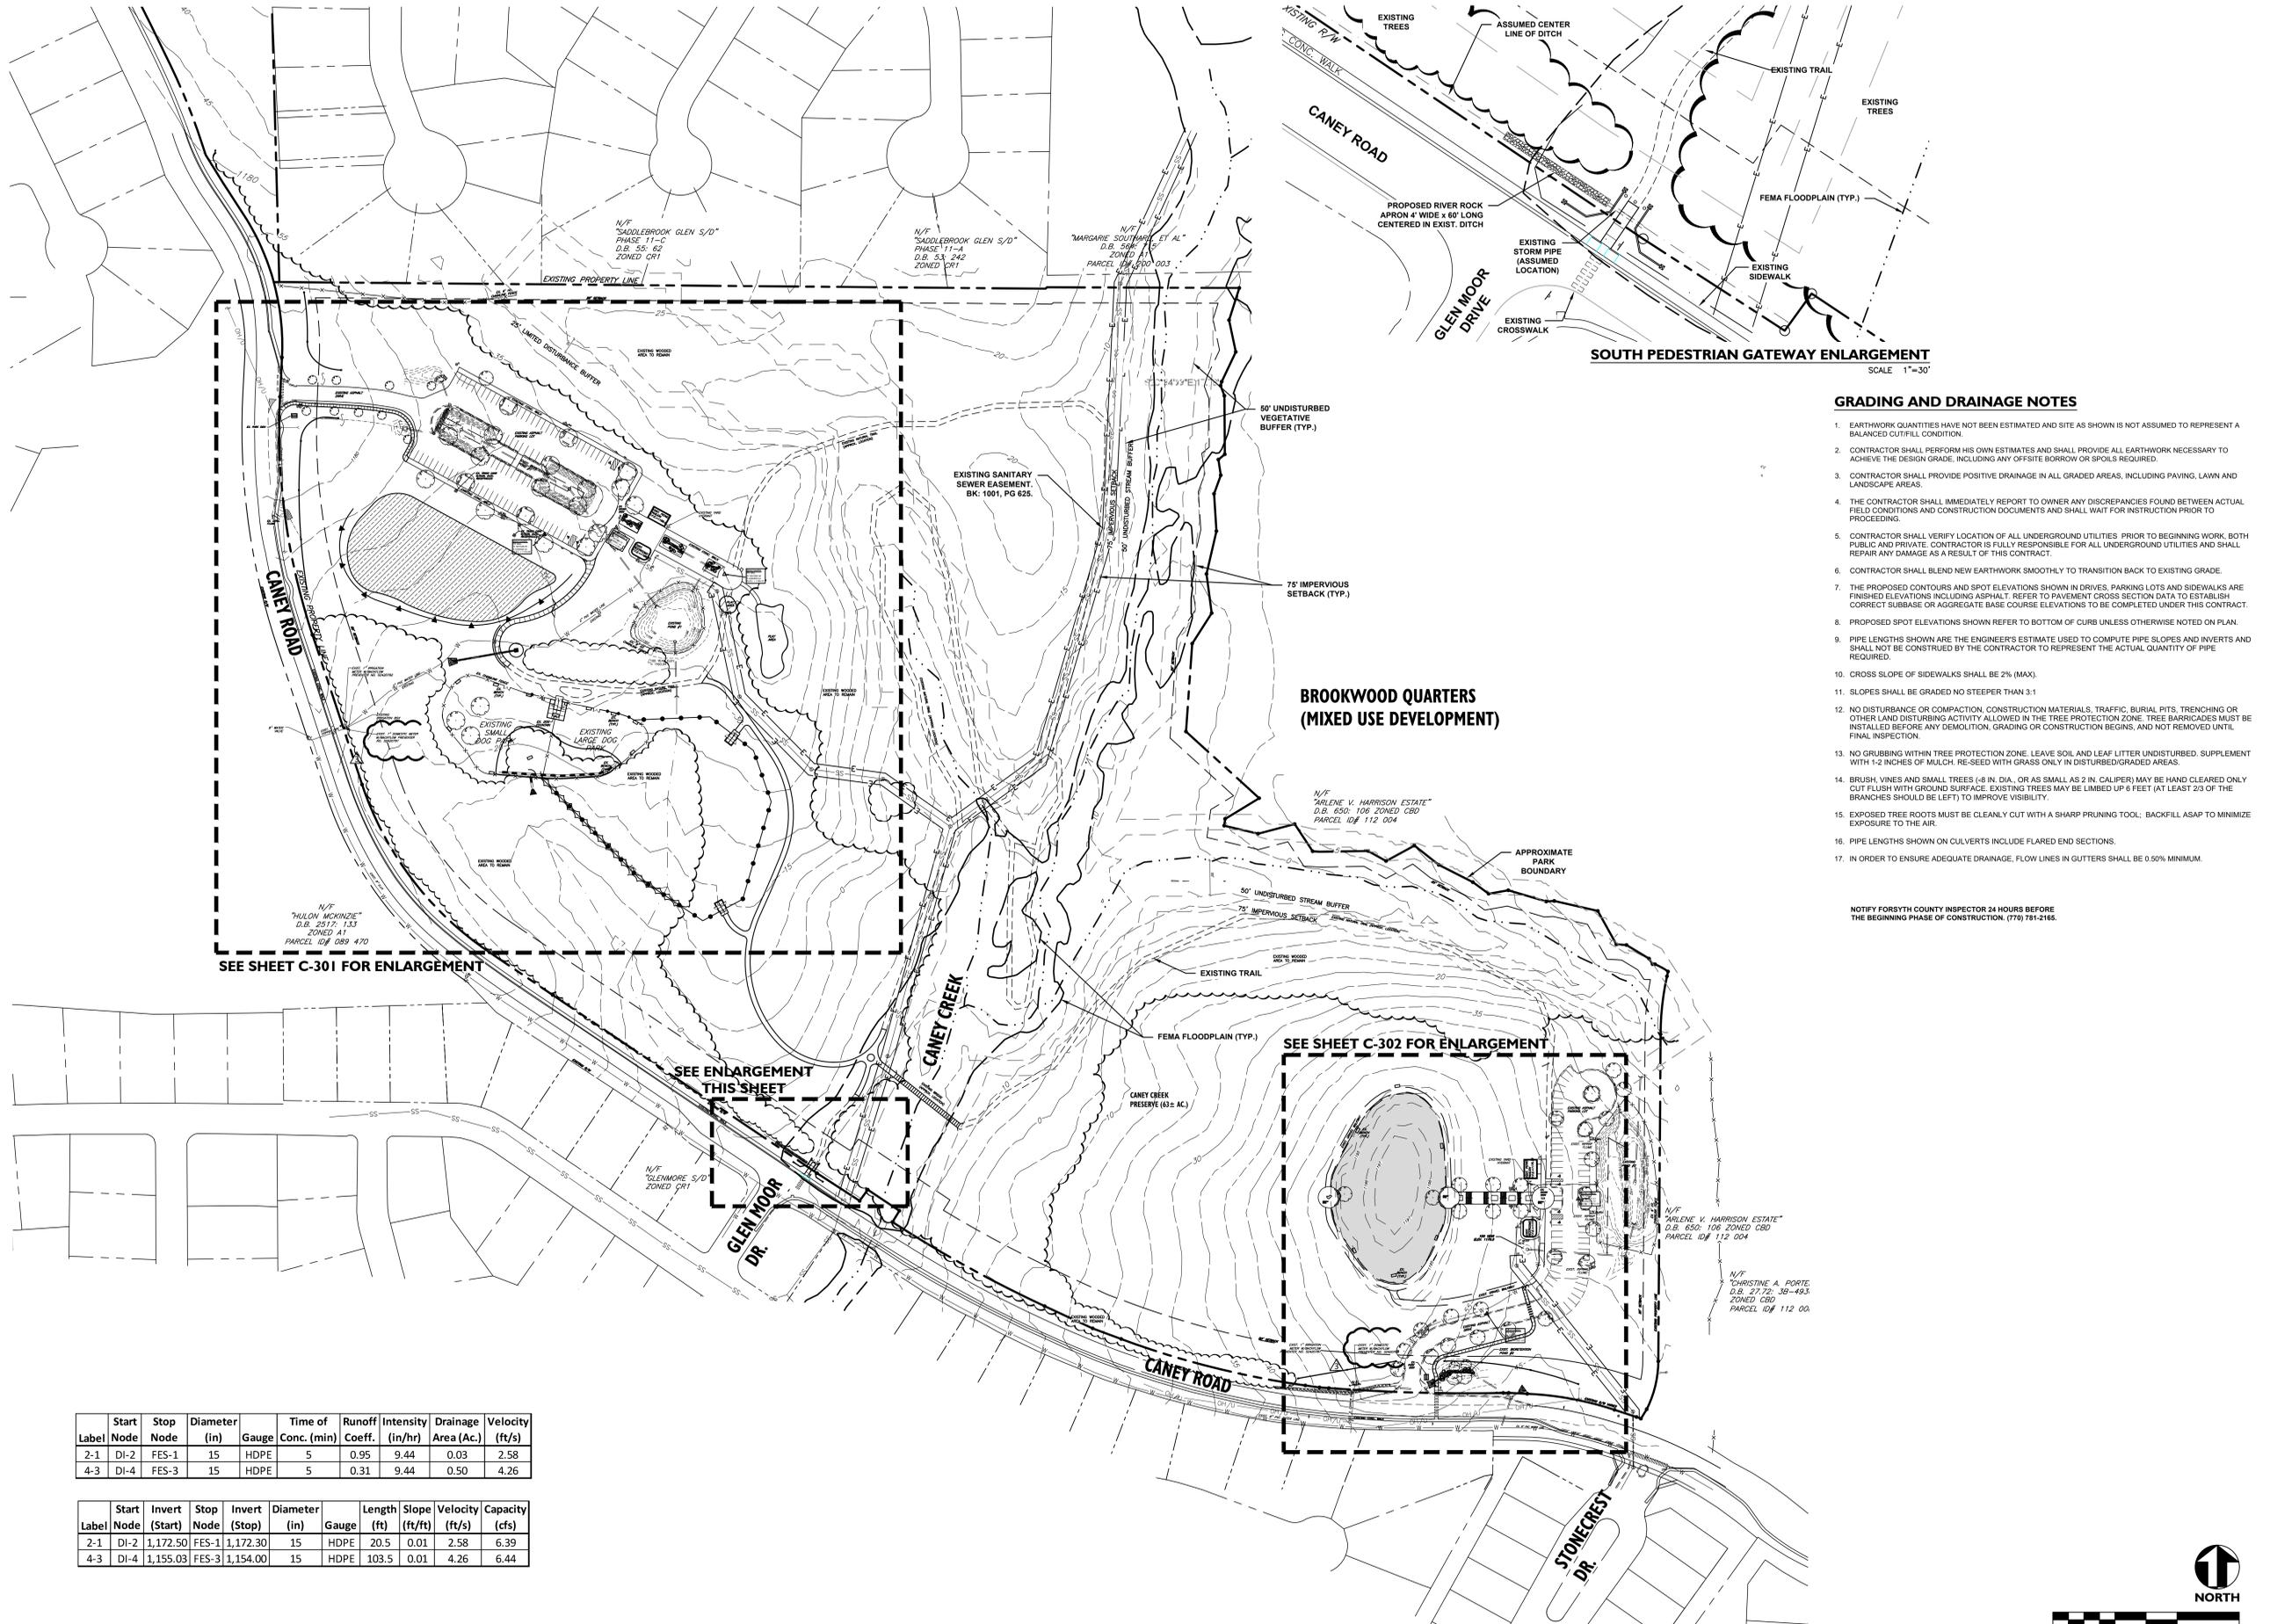

- GRADING AND DRAINAGE NOTES**
- EARTHWORK QUANTITIES HAVE NOT BEEN ESTIMATED AND SITE AS SHOWN IS NOT ASSUMED TO REPRESENT A BALANCED CUT/FILL CONDITION.
 - CONTRACTOR SHALL PERFORM HIS OWN ESTIMATES AND SHALL PROVIDE ALL EARTHWORK NECESSARY TO ACHIEVE THE DESIGN GRADE, INCLUDING ANY OFFSITE BORROW OR SPOILS REQUIRED.
 - CONTRACTOR SHALL PROVIDE POSITIVE DRAINAGE IN ALL GRADED AREAS, INCLUDING PAVING, LAWN AND LANDSCAPE AREAS.
 - THE CONTRACTOR SHALL IMMEDIATELY REPORT TO OWNER ANY DISCREPANCIES FOUND BETWEEN ACTUAL FIELD CONDITIONS AND CONSTRUCTION DOCUMENTS AND SHALL WAIT FOR INSTRUCTION PRIOR TO PROCEEDING.
 - CONTRACTOR SHALL VERIFY LOCATION OF ALL UNDERGROUND UTILITIES PRIOR TO BEGINNING WORK, BOTH PUBLIC AND PRIVATE. CONTRACTOR IS FULLY RESPONSIBLE FOR ALL UNDERGROUND UTILITIES AND SHALL REPAIR ANY DAMAGE AS A RESULT OF THIS CONTRACT.
 - CONTRACTOR SHALL BLEND NEW EARTHWORK SMOOTHLY TO TRANSITION BACK TO EXISTING GRADE.
 - THE PROPOSED CONTOURS AND SPOT ELEVATIONS SHOWN IN DRIVES, PARKING LOTS AND SIDEWALKS ARE FINISHED ELEVATIONS INCLUDING ASPHALT. REFER TO PAVEMENT CROSS SECTION DATA TO ESTABLISH CORRECT SUBBASE OR AGGREGATE BASE COURSE ELEVATIONS TO BE COMPLETED UNDER THIS CONTRACT.
 - PROPOSED SPOT ELEVATIONS SHOWN REFER TO BOTTOM OF CURB UNLESS OTHERWISE NOTED ON PLAN.
 - PIPE LENGTHS SHOWN ARE THE ENGINEER'S ESTIMATE USED TO COMPUTE PIPE SLOPES AND INVERTS AND SHALL NOT BE CONSTRUED BY THE CONTRACTOR TO REPRESENT THE ACTUAL QUANTITY OF PIPE REQUIRED.
 - CROSS SLOPE OF SIDEWALKS SHALL BE 2% (MAX).
 - SLOPES SHALL BE GRADED NO STEEPER THAN 3:1
 - NO DISTURBANCE OR COMPACTION, CONSTRUCTION MATERIALS, TRAFFIC, BURIAL PITS, TRENCHING OR OTHER LAND DISTURBING ACTIVITY ALLOWED IN THE TREE PROTECTION ZONE. TREE BARRICADES MUST BE INSTALLED BEFORE ANY DEMOLITION, GRADING OR CONSTRUCTION BEGINS, AND NOT REMOVED UNTIL FINAL INSPECTION.
 - NO GRUBBING WITHIN TREE PROTECTION ZONE. LEAVE SOIL AND LEAF LITTER UNDISTURBED. SUPPLEMENT WITH 1-2 INCHES OF MULCH. RE-SEED WITH GRASS ONLY IN DISTURBED/GRADED AREAS.
 - BRUSH, VINES AND SMALL TREES (4-8 IN. DIA., OR AS SMALL AS 2 IN. CALIPER) MAY BE HAND CLEARED ONLY CUT FLUSH WITH GROUND SURFACE. EXISTING TREES MAY BE LIMBED UP 6 FEET (AT LEAST 2/3 OF THE BRANCHES SHOULD BE LEFT) TO IMPROVE VISIBILITY.
 - EXPOSED TREE ROOTS MUST BE CLEANLY CUT WITH A SHARP PRUNING TOOL; BACKFILL ASAP TO MINIMIZE EXPOSURE TO THE AIR.
 - PIPE LENGTHS SHOWN ON CULVERTS INCLUDE FLARED END SECTIONS.
 - IN ORDER TO ENSURE ADEQUATE DRAINAGE, FLOW LINES IN GUTTERS SHALL BE 0.50% MINIMUM.
- NOTIFY FORSYTH COUNTY INSPECTOR 24 HOURS BEFORE THE BEGINNING PHASE OF CONSTRUCTION. (770) 781-2165.

Label	Start Node	Stop Node	Diameter (in)	Gauge	Time of Conc. (min)	Runoff Coeff.	Intensity (in/hr)	Drainage Area (Ac.)	Velocity (ft/s)
2-1	DI-2	FES-1	15	HDPE	5	0.95	9.44	0.03	2.58
4-3	DI-4	FES-3	15	HDPE	5	0.31	9.44	0.50	4.26



Label	Start Node	Invert (Start)	Stop Node	Invert (Stop)	Diameter (in)	Gauge	Length (ft)	Slope (ft/ft)	Velocity (ft/s)	Capacity (cfs)
2-1	DI-2	1,172.50	FES-1	1,172.30	15	HDPE	20.5	0.01	2.58	6.39
4-3	DI-4	1,155.03	FES-3	1,154.00	15	HDPE	103.5	0.01	4.26	6.44

Caney Creek Preserve
 2755 Caney Road, 3055 Caney Road
 Forsyth County

Project No: 17.000291
 Date: 01.08.20

Revisions:

Per County Comments	01.31.20
Per County Comments	03.04.20
Per County Comments	04.27.20

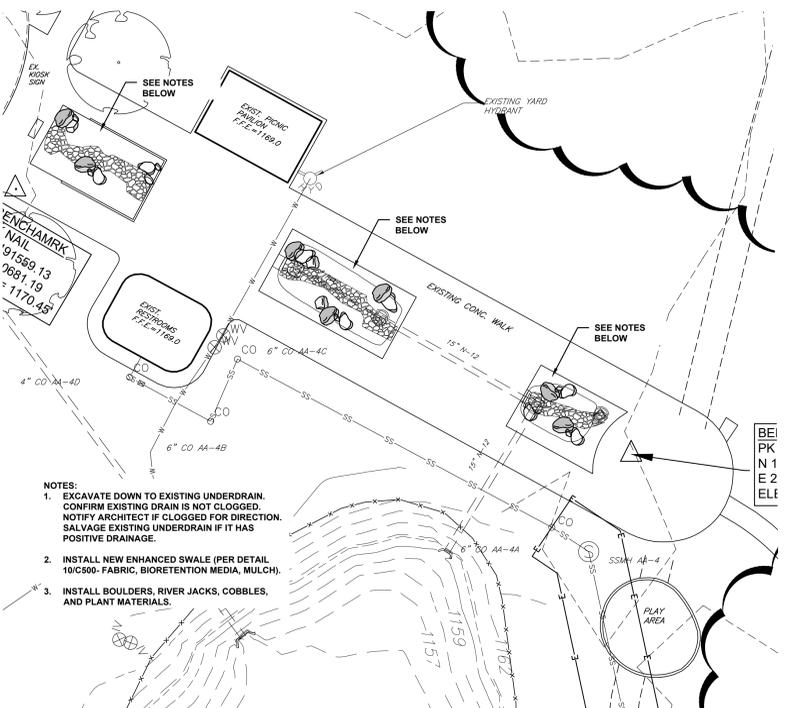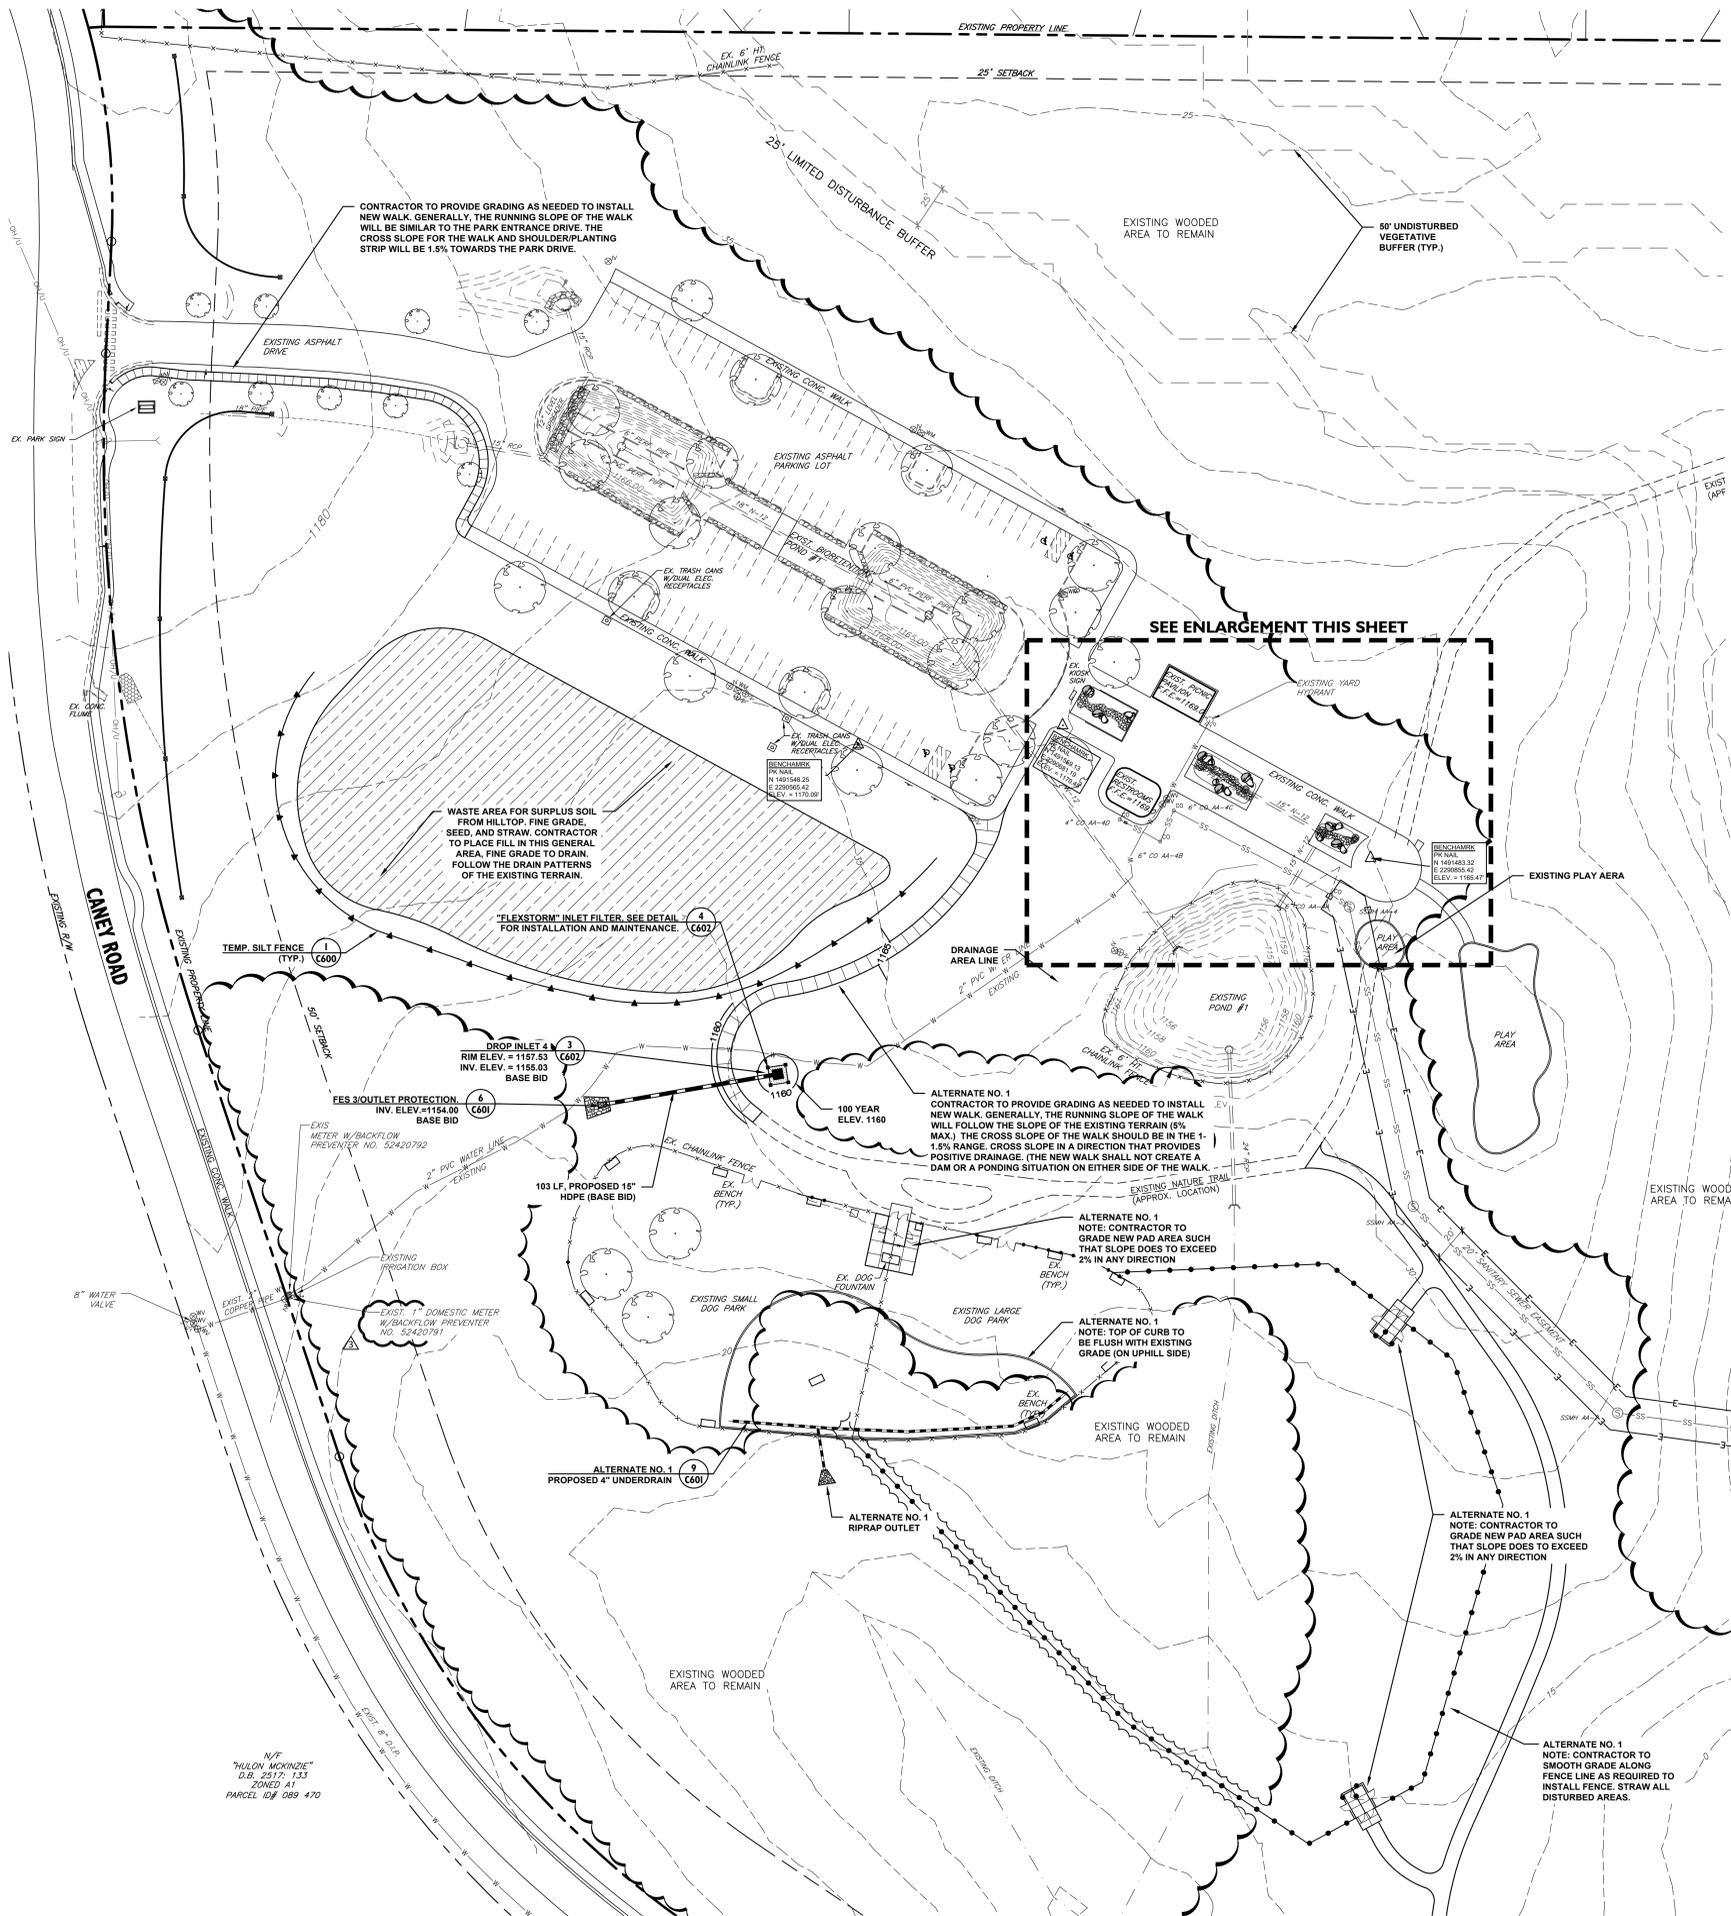


WEST PROMENADE IMPROVEMENTS ENLARGEMENT
SCALE 1"=20'

DISTURBED AREA = 1.0 AC

NOTIFY FORSYTH COUNTY INSPECTOR 24 HOURS BEFORE THE BEGINNING PHASE OF CONSTRUCTION. (770) 781-2165.

- LEGEND**
- - - - - EXISTING SIGN
 - EIP EXISTING IRON PIN
 - EXISTING LIGHT POLE
 - EXISTING UTILITY POLE
 - R/W RIGHT-OF-WAY
 - ⊕ EXISTING FIRE HYDRANT
 - ⊕ EXISTING WATER VALVE
 - ⊕ EXISTING WATER METER
 - ⊕ EXISTING SEWER MANHOLE
 - EXISTING CLEANOUT
 - EXISTING DRAINAGE STRUCTURE
 - PROPOSED DRAINAGE STRUCTURE
 - ⊕ EXISTING GAS VALVE
 - ⊕ EXISTING GAS METER
 - ==== EXISTING CURB AND GUTTER
 - - - - - PROPERTY LINE
 - - - - - EXISTING FENCE
 - - - - - EXISTING UNDERGROUND ELECTRIC LINE
 - - - - - EXISTING OVERHEAD ELECTRIC LINE
 - - - - - EXISTING UNDERGROUND TELEPHONE LINE
 - - - - - EXISTING SANITARY SEWER LINE
 - - - - - EXISTING WATER LINE
 - - - - - EXISTING CONTOUR LINE
 - - - - - PROPOSED CONTOUR LINE
 - ==== EXISTING STORM DRAINAGE PIPE
 - ==== PROPOSED STORM DRAINAGE PIPE
 - - - - - EXISTING GAS LINE
 - ⊕ EXISTING STORM MANHOLE
 - - - - - EXISTING EASEMENT
 - - - - - EXISTING TREELINE
 - TEMPORARY INLET PROTECTION

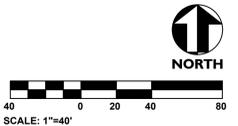

- NOTES:**
- EXCAVATE DOWN TO EXISTING UNDERDRAIN. CONFIRM EXISTING DRAIN IS NOT CLOGGED. NOTIFY ARCHITECT IF CLOGGED FOR DIRECTION. SALVAGE EXISTING UNDERDRAIN IF IT HAS POSITIVE DRAINAGE.
 - INSTALL NEW ENHANCED SWALE (PER DETAIL 18C600- FABRIC, BIORETENTION MEDIA, MULCH).
 - INSTALL BOULDERS, RIVER JACKS, COBBLES, AND PLANT MATERIALS.

SEE ENLARGEMENT THIS SHEET

CONTRACTOR TO PROVIDE GRADING AS NEEDED TO INSTALL NEW WALK. GENERALLY, THE RUNNING SLOPE OF THE WALK WILL BE SIMILAR TO THE PARK ENTRANCE DRIVE. THE CROSS SLOPE FOR THE WALK AND SHOULDER/PLANTING STRIP WILL BE 1.5% TOWARDS THE PARK DRIVE.

WASTE AREA FOR SURPLUS SOIL FROM HILLTOP. FINE GRADE, SEED, AND STRAW. CONTRACTOR TO PLACE FILL IN THIS GENERAL AREA. FINE GRADE TO DRAIN. FOLLOW THE DRAIN PATTERNS OF THE EXISTING TERRAIN.

ALTERNATE NO. 1
CONTRACTOR TO PROVIDE GRADING AS NEEDED TO INSTALL NEW WALK. GENERALLY, THE RUNNING SLOPE OF THE WALK WILL FOLLOW THE SLOPE OF THE EXISTING TERRAIN (5% MAX.) THE CROSS SLOPE OF THE WALK SHOULD BE IN THE 1-1.5% RANGE. CROSS SLOPE IN A DIRECTION THAT PROVIDES POSITIVE DRAINAGE. (THE NEW WALK SHALL NOT CREATE A DAM OR A PONDING SITUATION ON EITHER SIDE OF THE WALK.)

ALTERNATE NO. 1
NOTE: CONTRACTOR TO GRADE NEW PAD AREA SUCH THAT SLOPE DOES NOT EXCEED 2% IN ANY DIRECTION

ALTERNATE NO. 1
NOTE: TOP OF CURB TO BE FLUSH WITH EXISTING GRADE (ON UPHILL SIDE)

ALTERNATE NO. 1
NOTE: CONTRACTOR TO GRADE NEW PAD AREA SUCH THAT SLOPE DOES NOT EXCEED 2% IN ANY DIRECTION

ALTERNATE NO. 1
NOTE: CONTRACTOR TO SMOOTH GRADE ALONG FENCE LINE AS REQUIRED TO INSTALL FENCE. STRAW ALL DISTURBED AREAS.

N/F "MULCH MORTAR"
D.B. 2517, 133
ZONED A1
PARCEL ID# 089 470



Corp. NC License: F-1320

Caney Creek Preserve
2755 Caney Road, 3055 Caney Road
Forsyth County







Project No: 17.000291
Date: 01.08.20

Revisions:

Per County Comments	01.31.20
Per County Comments	03.04.20
Per County Comments	04.27.20

Sheet Title:
**Grading Plan
Enlargement-
West**

Sheet No:
C301

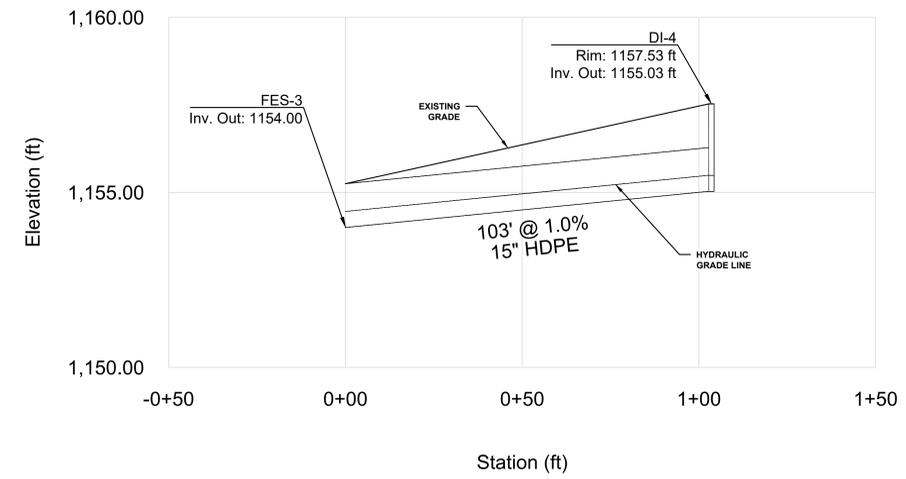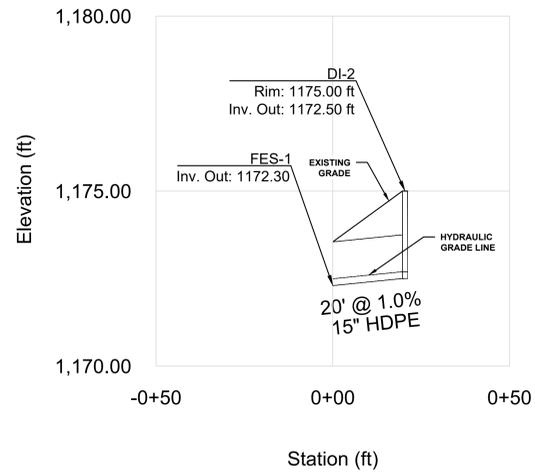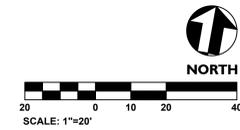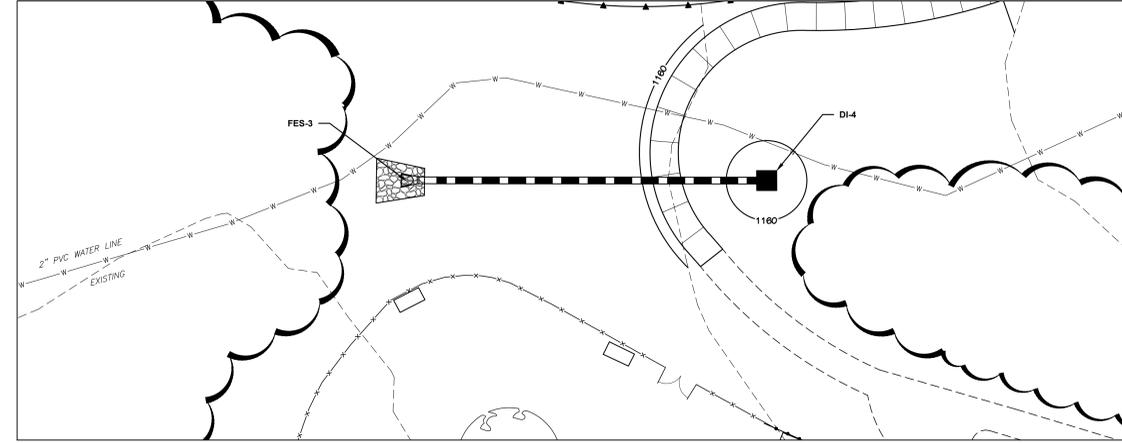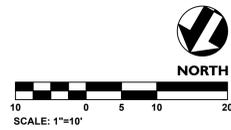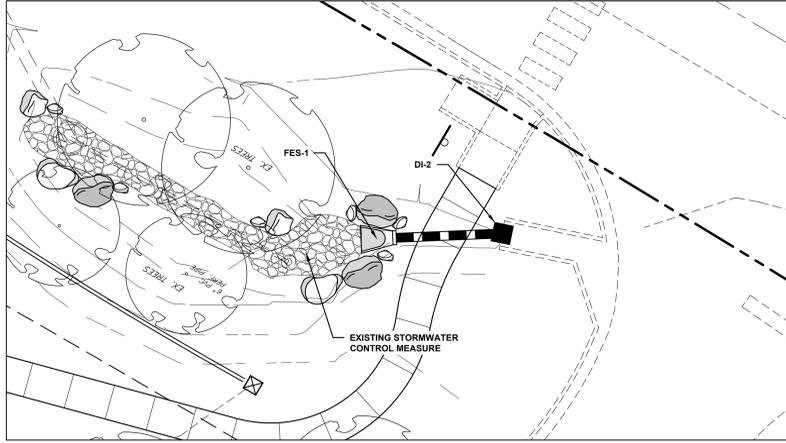

Seals:



Corp. NC License: F-1320



Caney Creek Preserve
 2755 Caney Road, 3055 Caney Road
 Forsyth County

Project No:	17.000291
Date:	01.08.20
Revisions:	
Per County Comments	01.31.20
Per County Comments	03.04.20
Per County Comments	04.27.20

Sheet Title:
**Pipe Plan &
 Profiles**

NOTIFY FORSYTH COUNTY INSPECTOR 24 HOURS BEFORE
 THE BEGINNING PHASE OF CONSTRUCTION. (770) 781-2165.

Sheet No:
C303

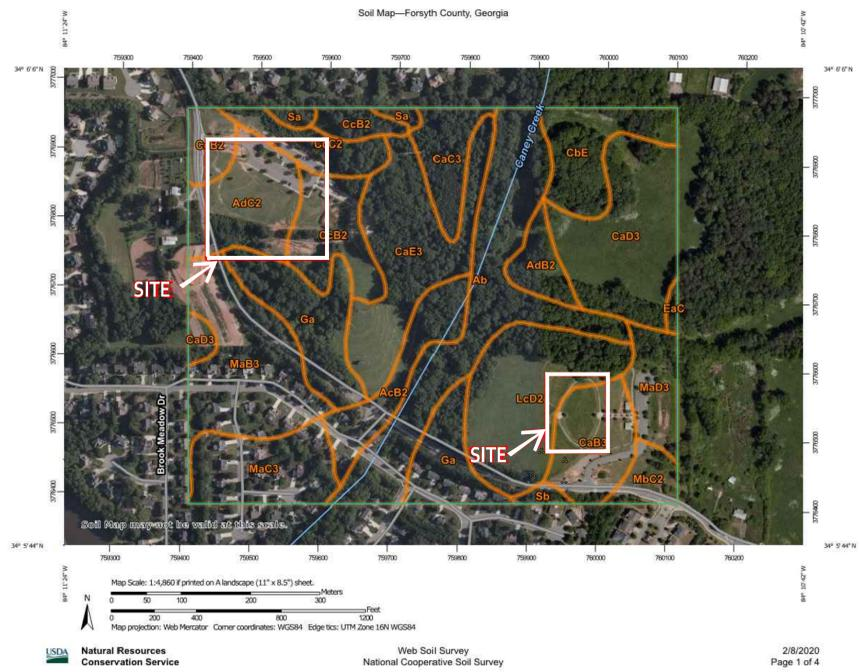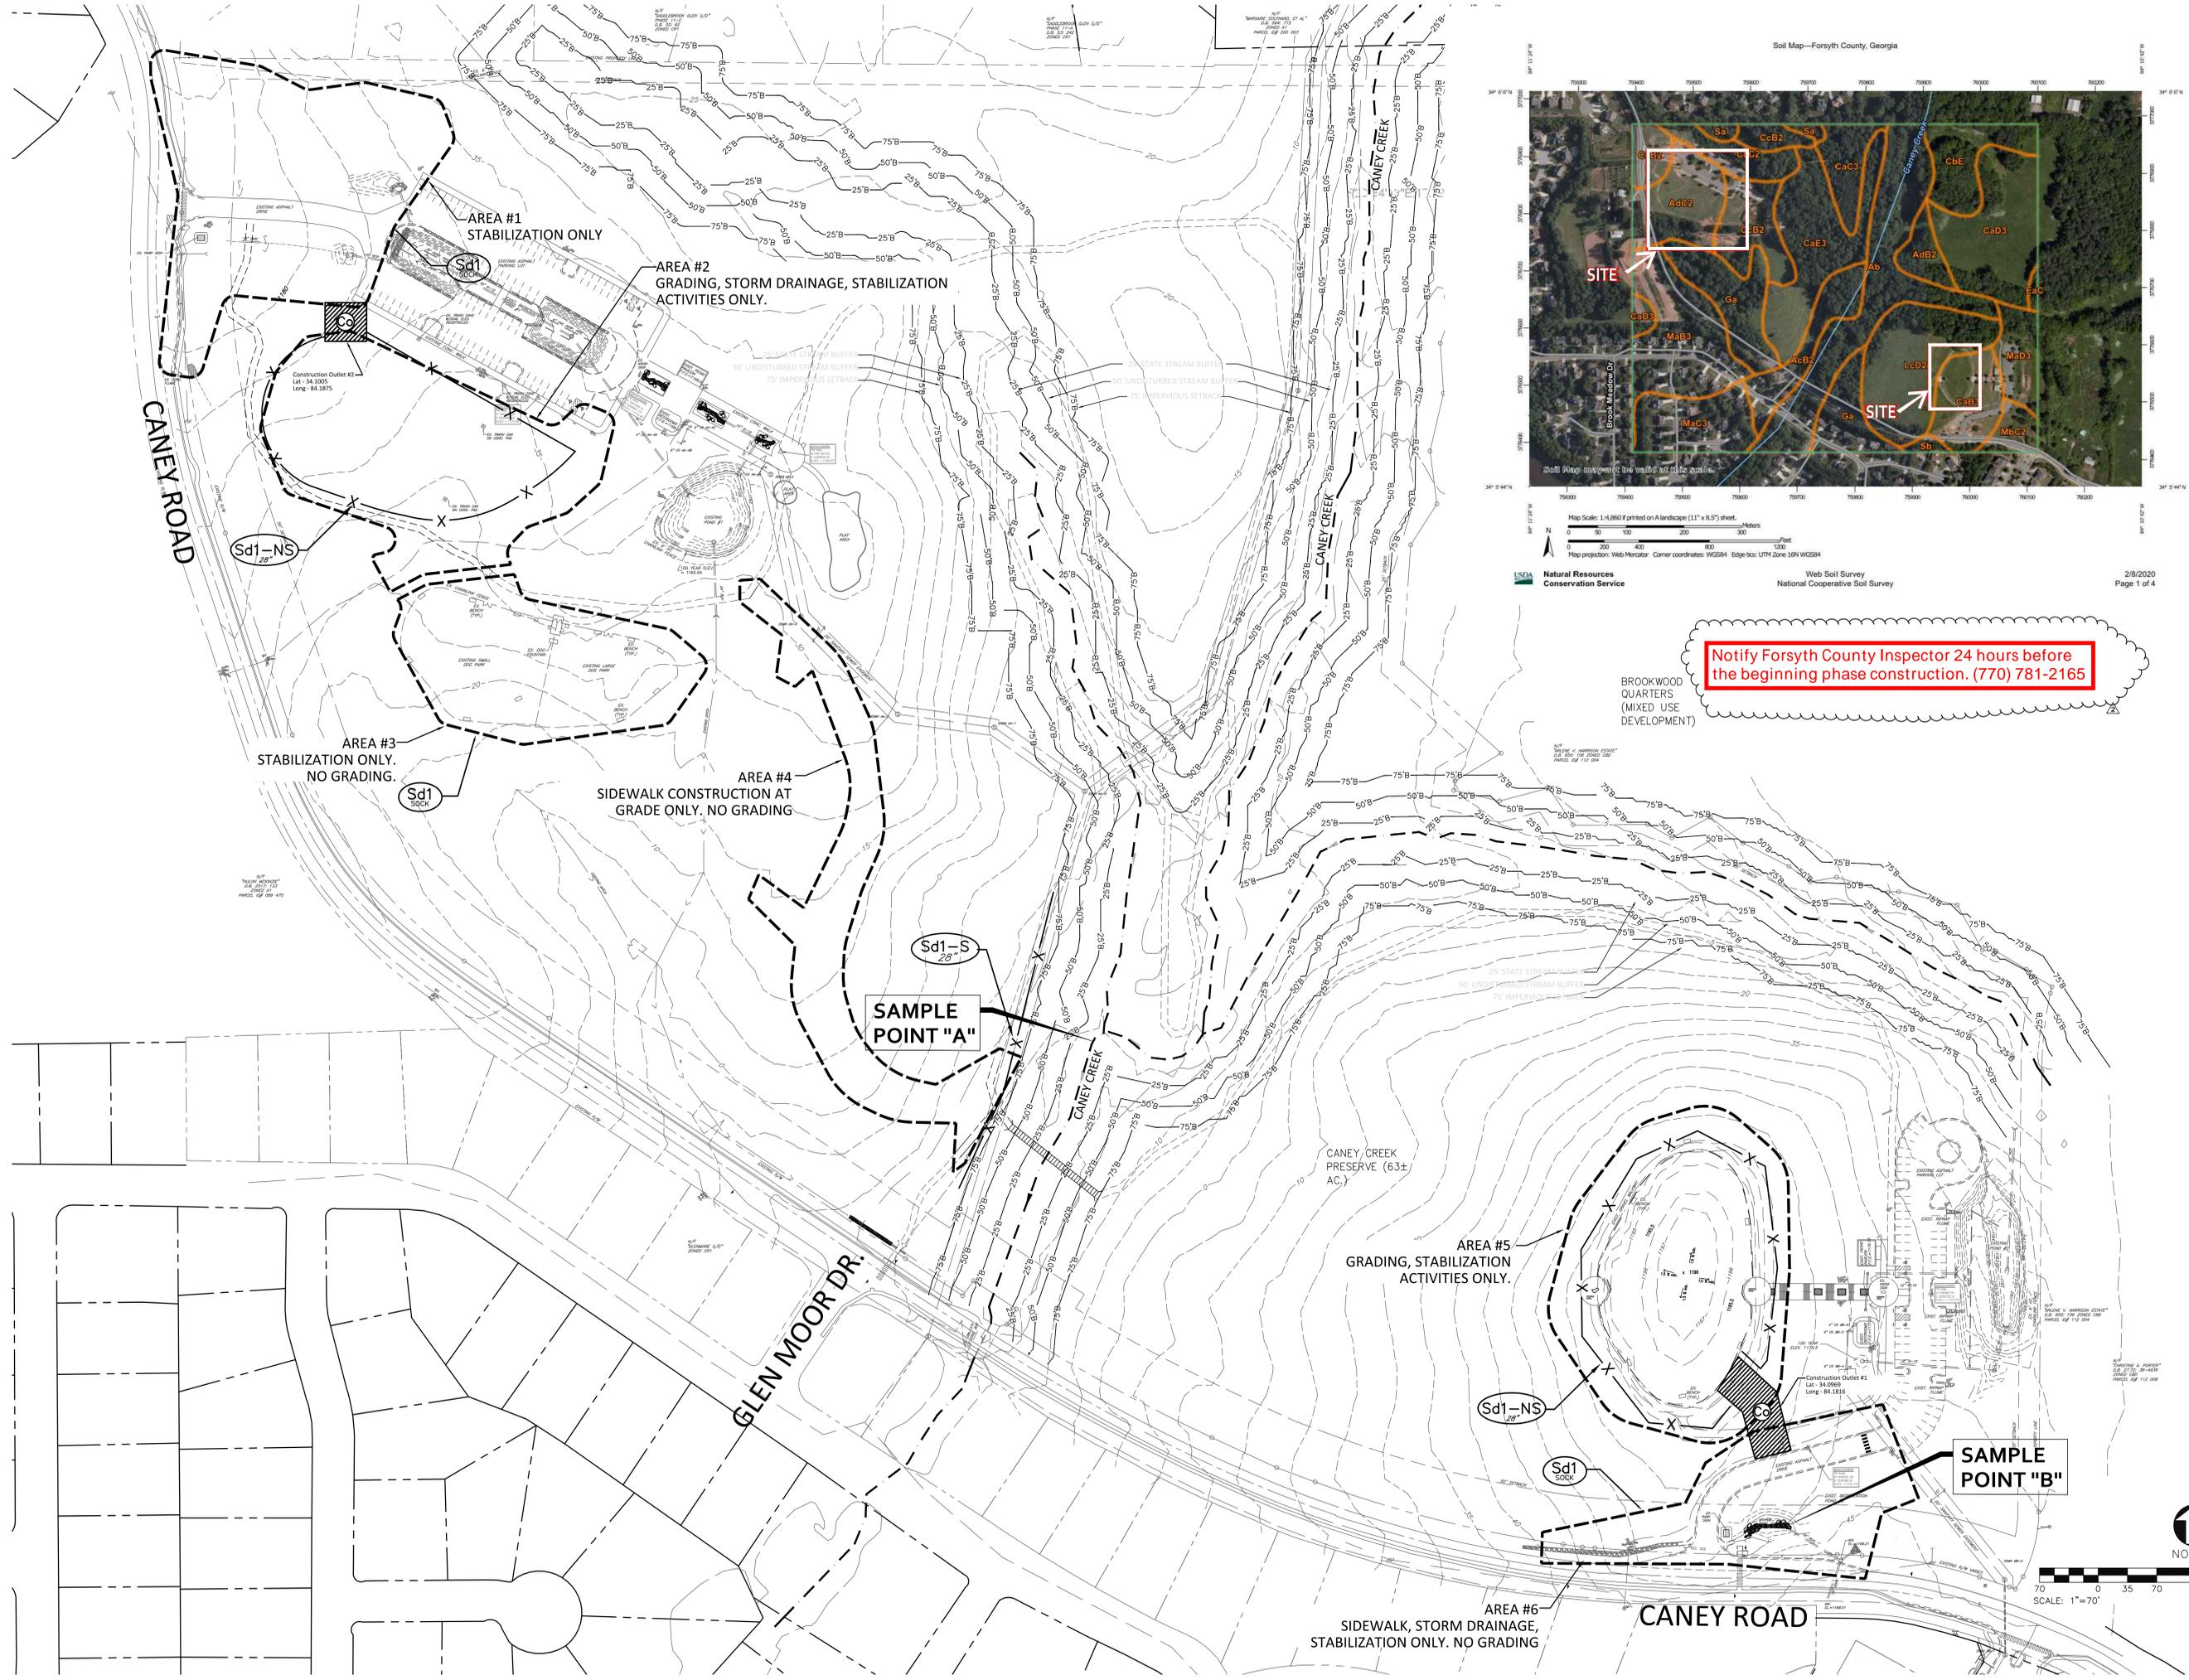

Notify Forsyth County Inspector 24 hours before the beginning phase construction. (770) 781-2165


BROOKWOOD QUARTERS (MIXED USE DEVELOPMENT)



Caney Creek Preserve
 2755 Caney Road, 3055 Caney Road
 Forsyth County

Project No: 17.000291
 Date: 01.08.20
 Revisions:
 Per County Comments (ENTIRE SHEET ADD'D) 02.13.20
 Add note for 24 hour 03/06/20 notification

Sheet Title:
ESCP Plan - INITIAL PHASE

Sheet No:
C304

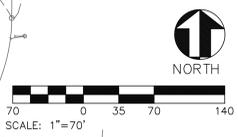

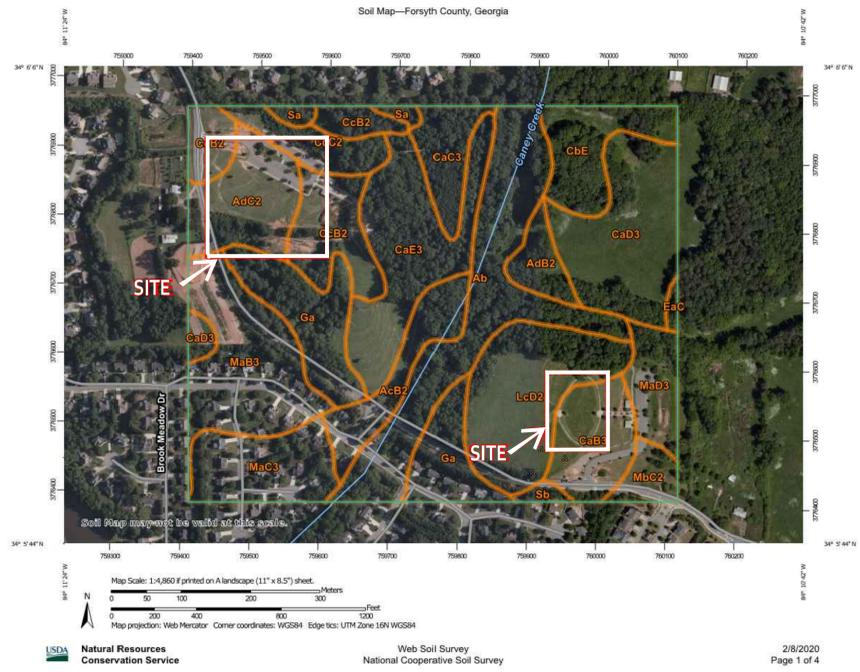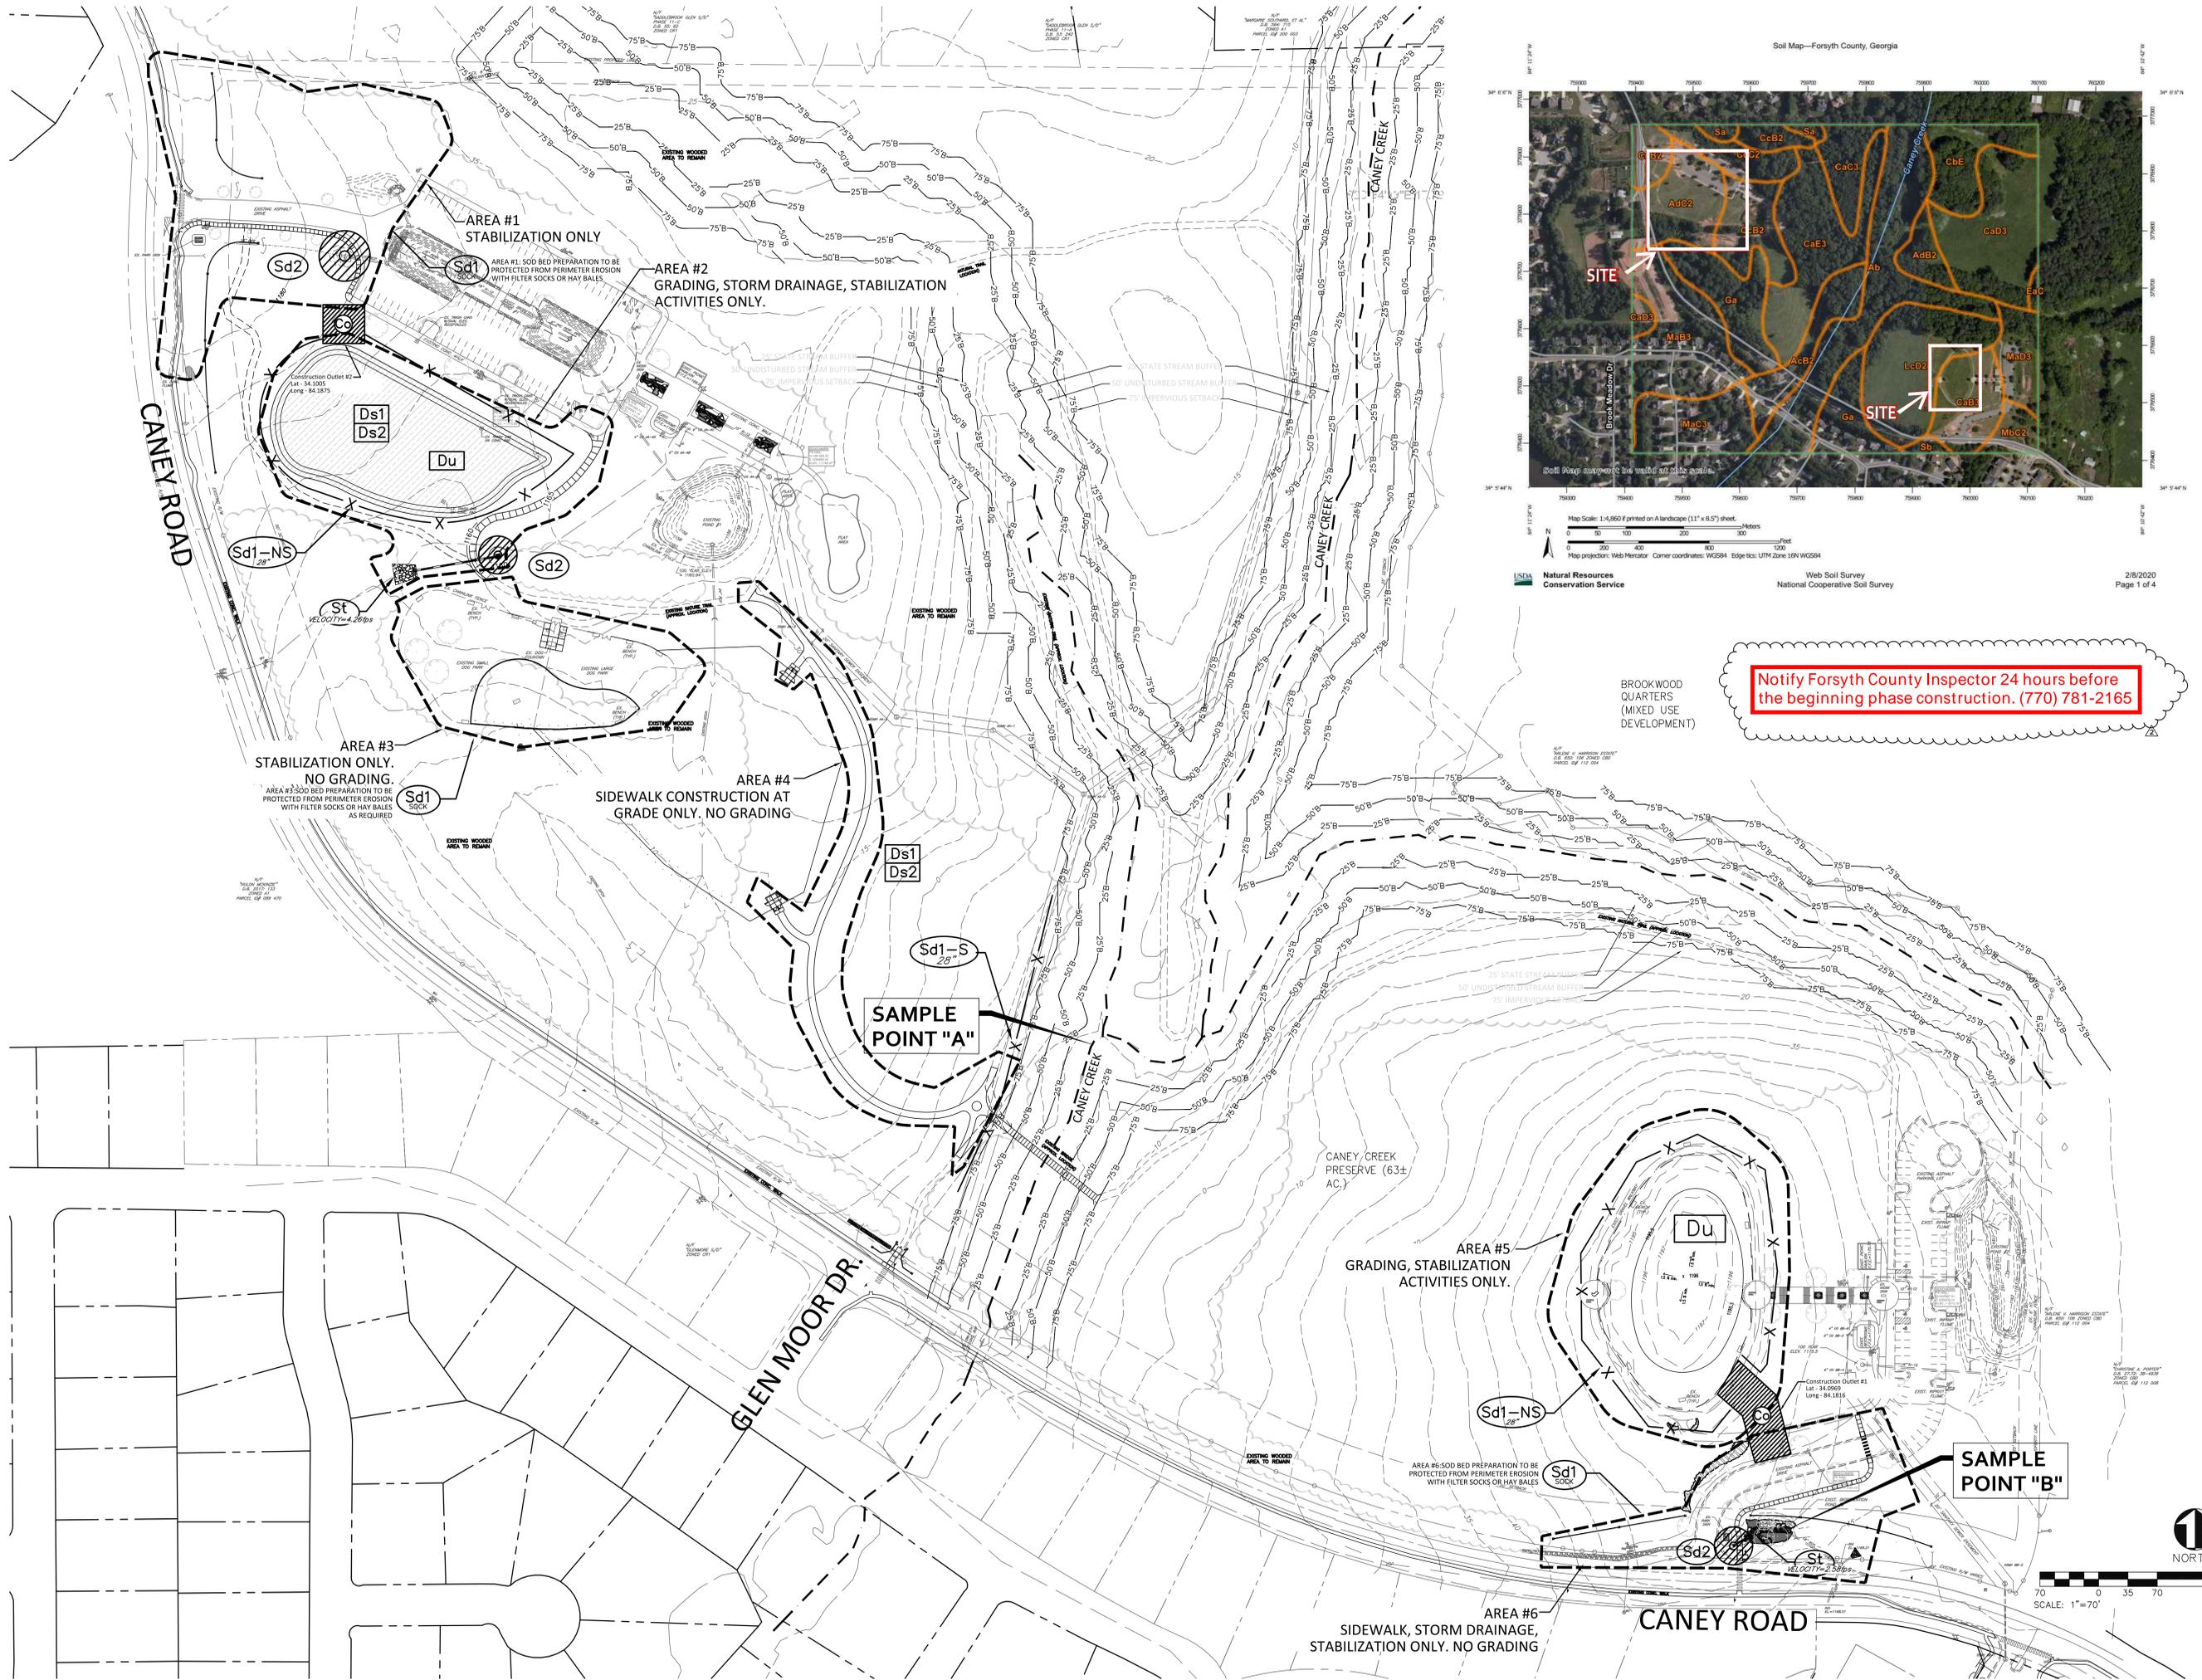



Notify Forsyth County Inspector 24 hours before the beginning phase construction. (770) 781-2165

Caney Creek Preserve
2755 Caney Road, 3055 Caney Road
Forsyth County

Project No: 17.000291
Date: 01.08.20
Revisions:
Per County Comments (ENTIRE SHEET ADDED) 02.13.20
Add note for 24 hour 03/09/20 notification

Sheet Title:
ESCP PLAN - INTERMEDIATE PHASE

Sheet No:
C305

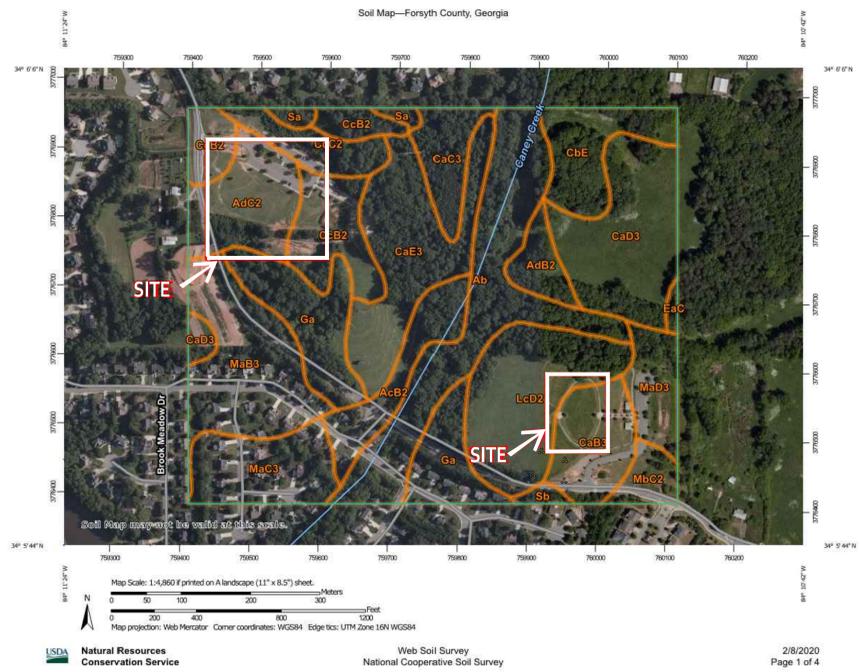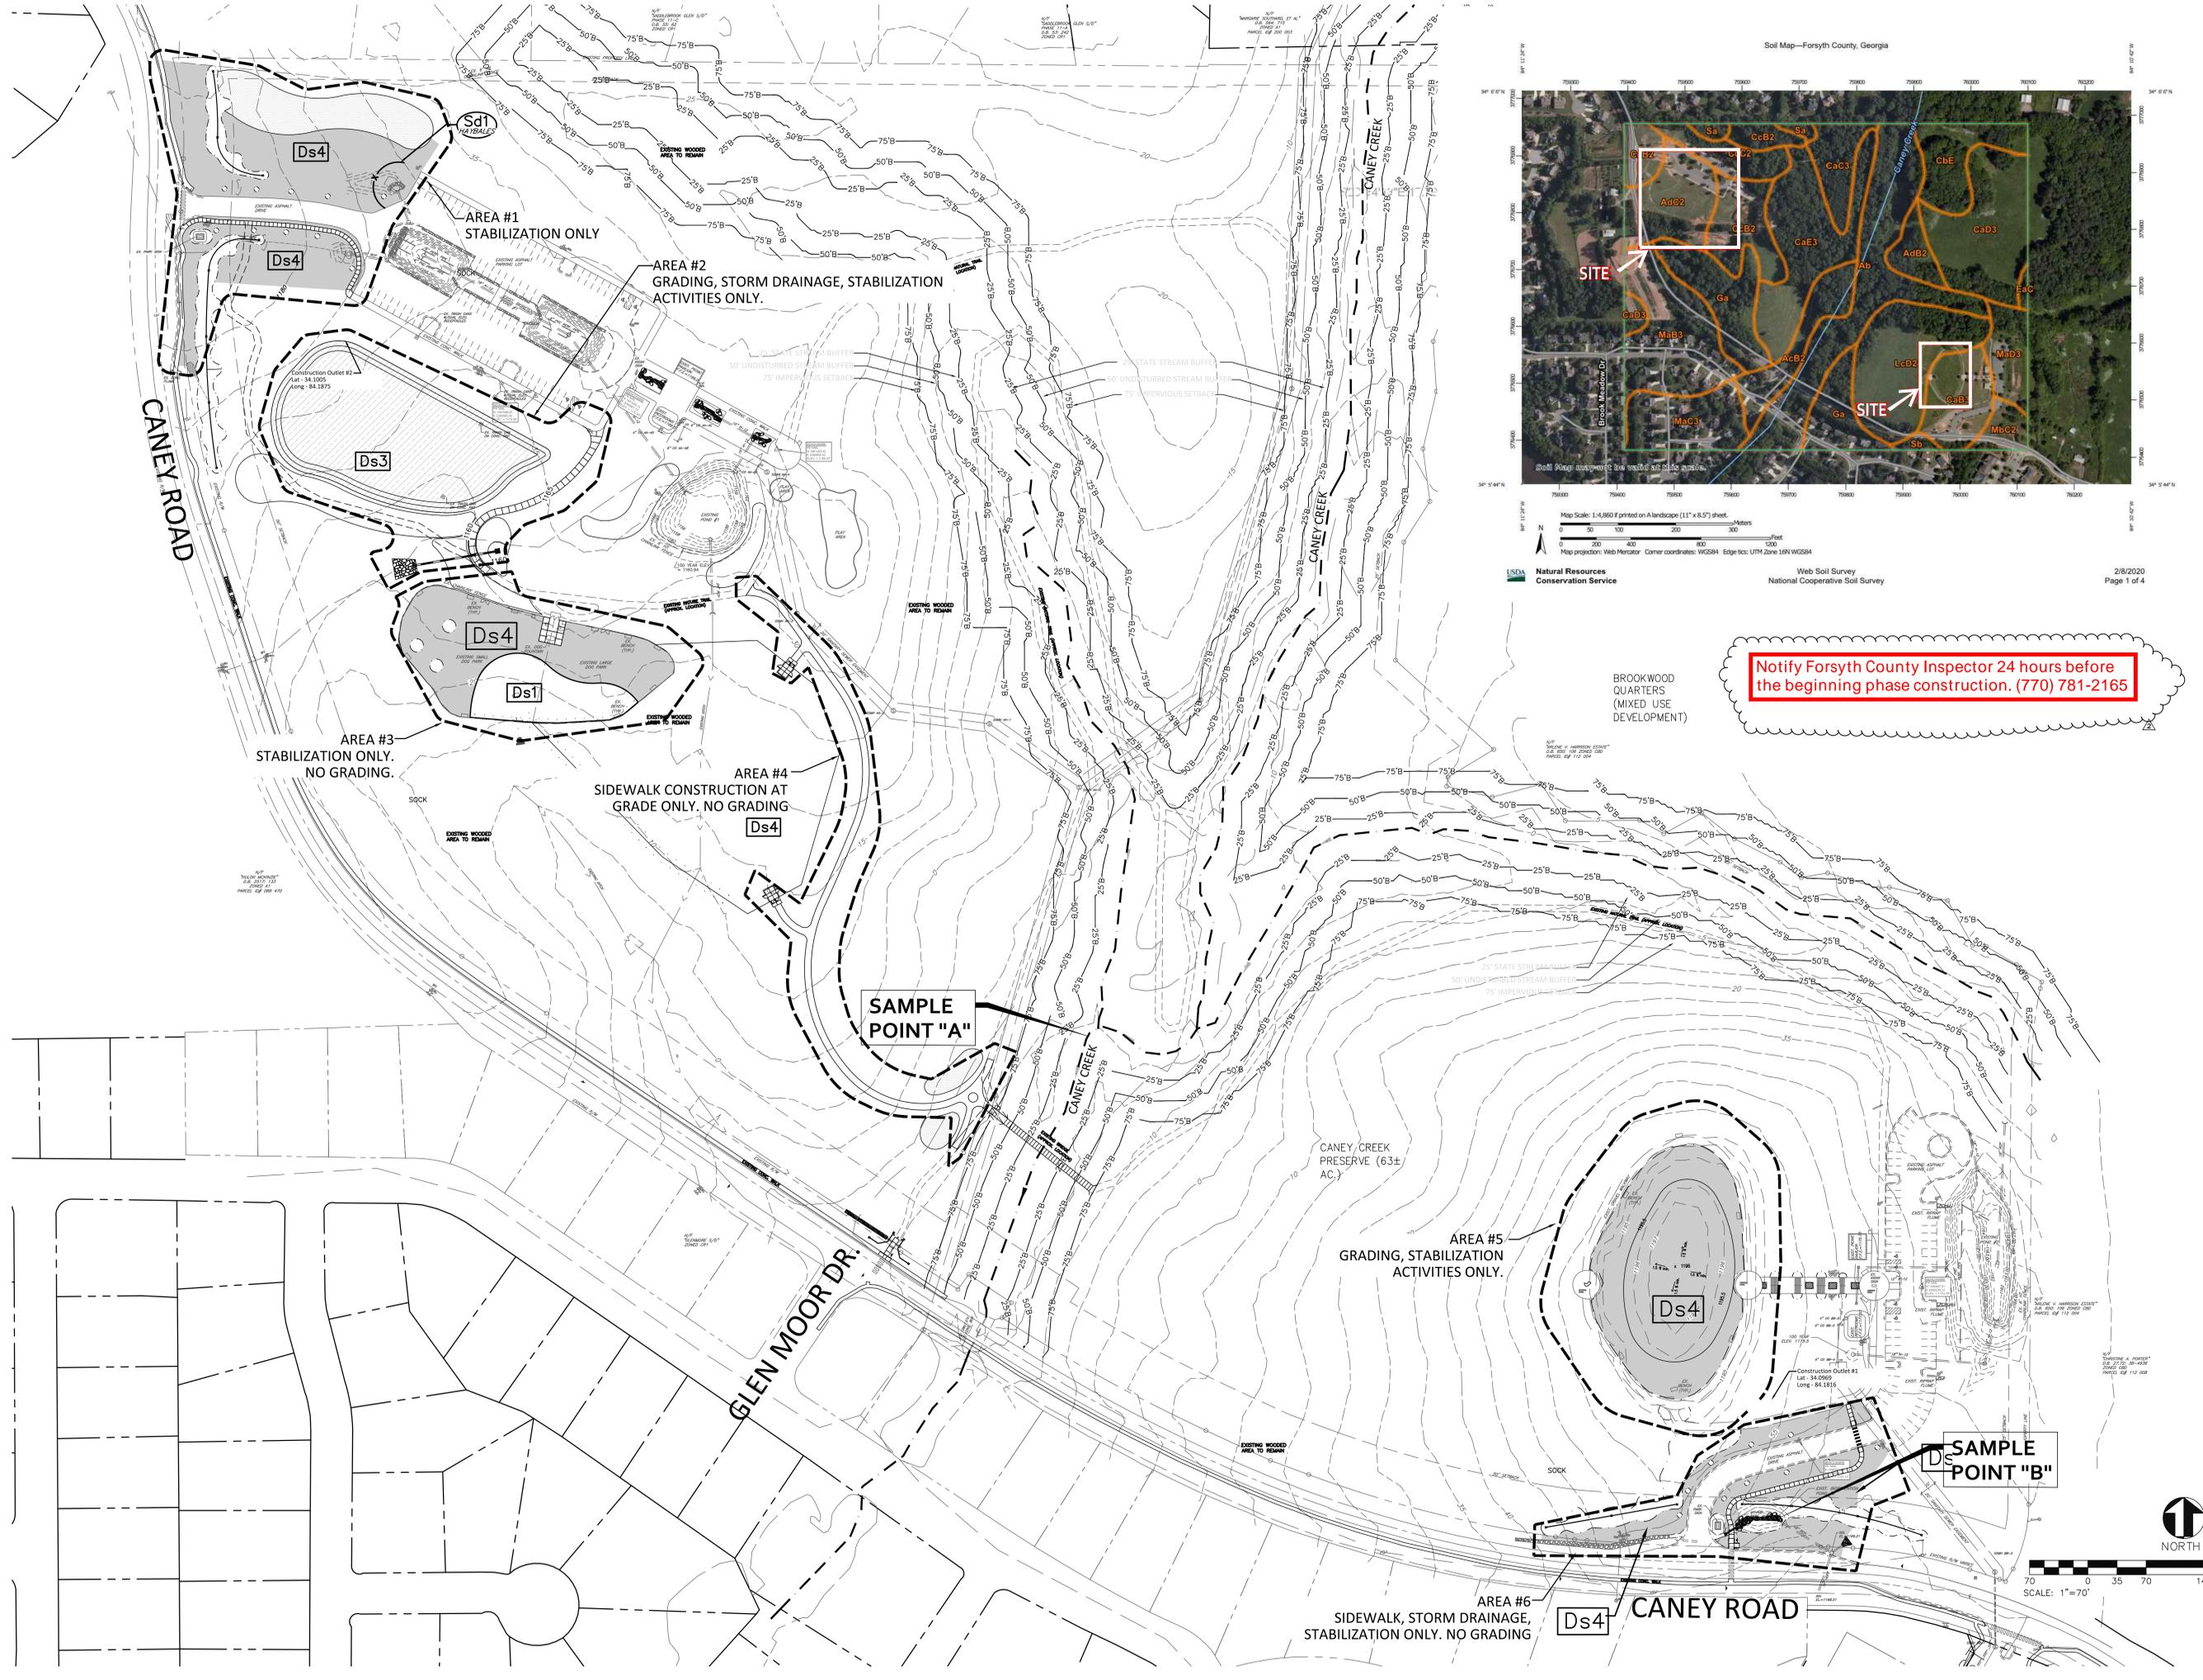

Notify Forsyth County Inspector 24 hours before the beginning phase construction. (770) 781-2165

Caney Creek Preserve
2755 Caney Road, 3055 Caney Road
Forsyth County

Project No: 17.000291
Date: 01.08.20

Revisions:

Per County Comments (ENTIRE SHEET ADD'D)	02.13.20
Add note for 24 hour 01/08/20 notification	



Sheet Title:
ESCP PLAN - FINAL PHASE

Sheet No:
C306


Seals:



Corp. NC License: F-1320

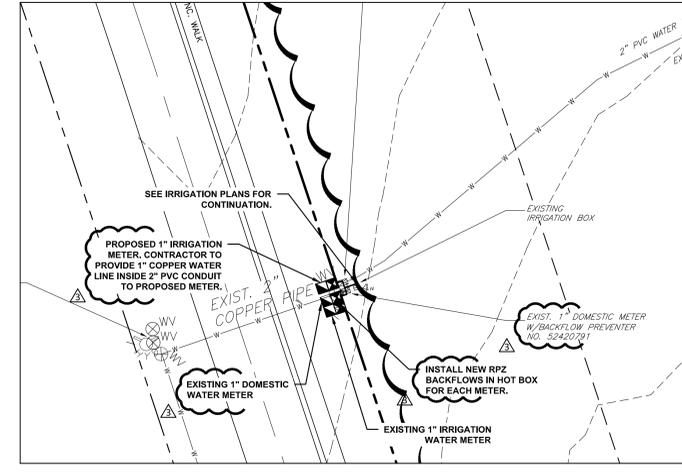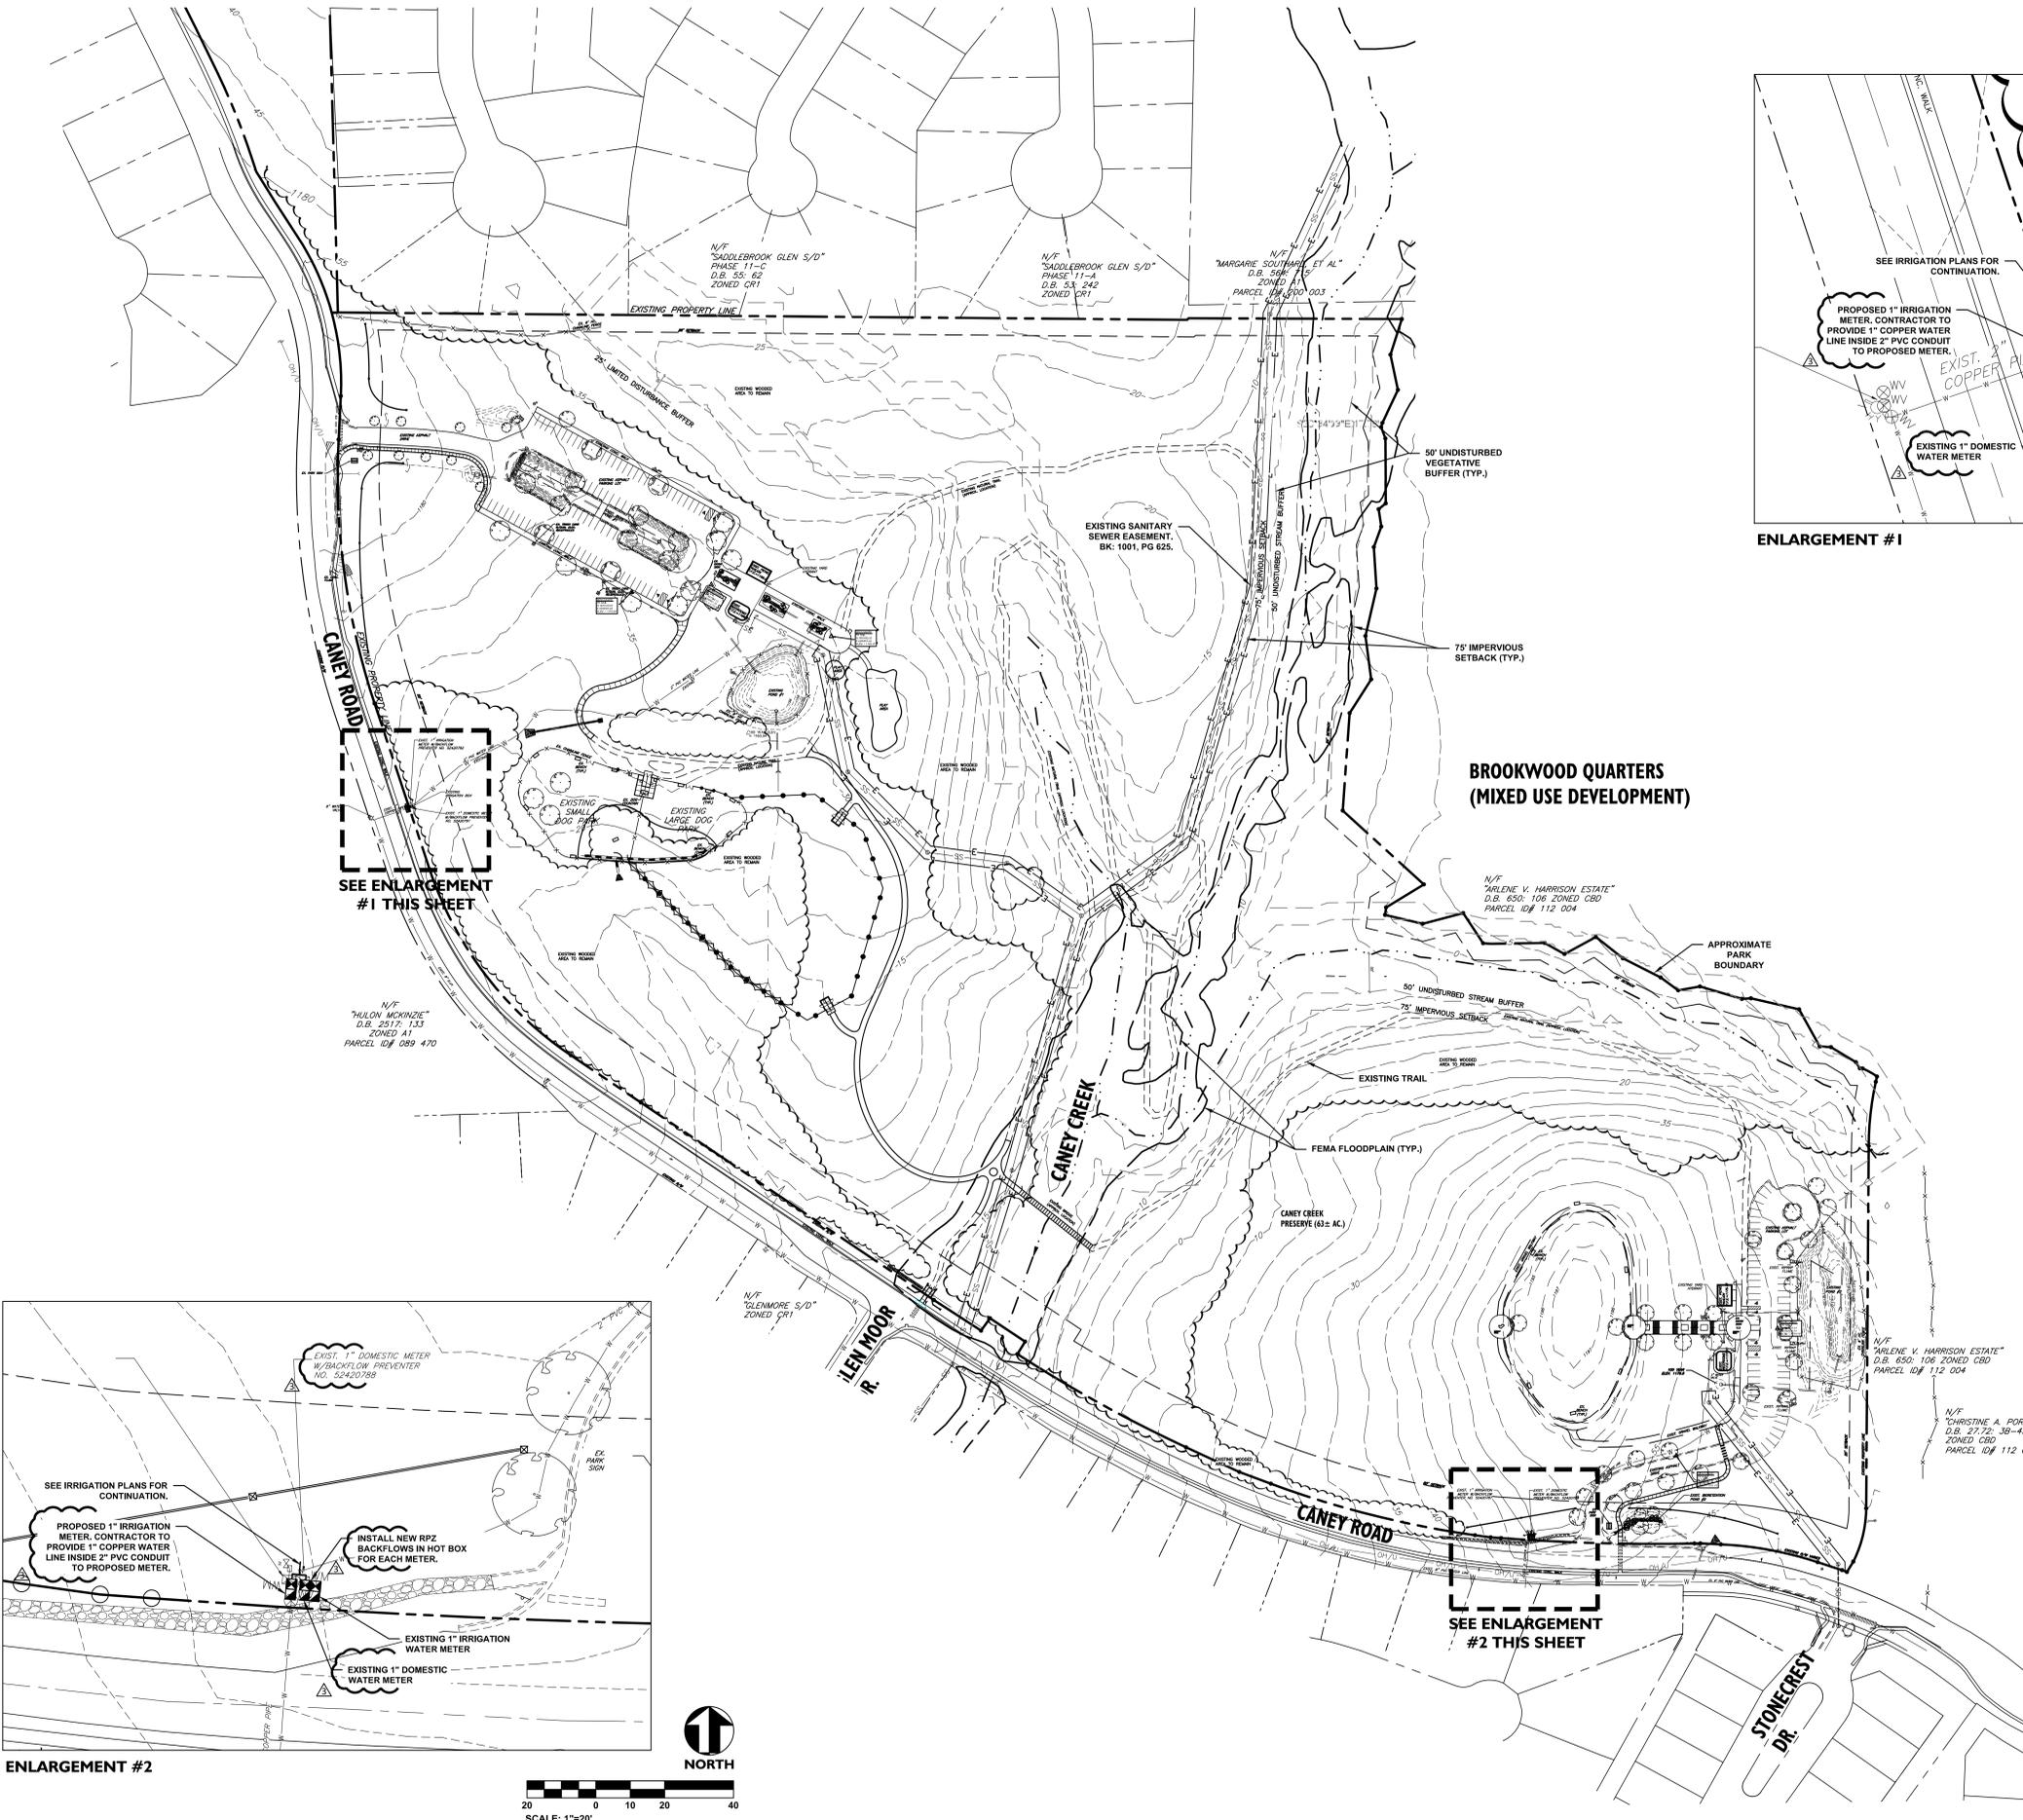

ENLARGEMENT #1

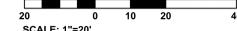

UTILITY NOTES

1. UTILITY CONSTRUCTION SHALL BE IN ACCORDANCE WITH ALL APPLICABLE LOCAL AND STATE CODE REQUIREMENTS.
2. THE CONTRACTOR SHALL BE RESPONSIBLE FOR VERIFYING THE LOCATION OF ALL EXISTING UNDERGROUND UTILITIES (STORM DRAINAGE, ELECTRIC, GAS, TELEPHONE, ETC.) PRIOR TO CONSTRUCTION. INFORMATION SHOWN ON THIS PLAN IS FOR REFERENCE ONLY AND SHALL BE FIELD VERIFIED BY THE CONTRACTOR.
3. THE CONTRACTOR SHALL NOTIFY THE ARCHITECT/ENGINEER IMMEDIATELY IF ANY DISCREPANCIES BETWEEN THE CONSTRUCTION PLANS AND ACTUAL FIELD CONDITIONS ARE FOUND.
4. THE CONNECTION TO EXISTING WATER MAINS SHALL BE PERFORMED ONLY AFTER ALL PRESSURE TESTING AND CALCORINATION ARE SUCCESSFULLY COMPLETED AND THE LOCAL REVIEW AUTHORITY HAS APPROVED THE CONNECTION. THE CONTRACTOR SHALL AVOID DISRUPTION OF EXISTING SERVICE.
5. UNLESS OTHERWISE NOTED, THE PHYSICAL CONNECTION BETWEEN THE SITE UTILITY LINES AND THE PIPE INSTALLED BY THE PLUMBING CONTRACTOR SHALL BE MADE BY THE SITE UTILITY CONTRACTOR.
6. PIPE LENGTHS SHOWN ON PLAN ARE THE ENGINEER'S ESTIMATE USED TO COMPUTE PIPE SLOPES AND INVERTS AND SHALL NOT BE CONSTRUED BY THE CONTRACTOR TO REPRESENT THE ACTUAL QUANTITY OF PIPE REQUIRED.
7. IRRIGATION SYSTEMS ARE PROHIBITED ON ALL EXISTING AND PROPOSED COUNTY RIGHT-OF-WAY AND CONSIDERED TO BE A VIOLATION OF THE COUNTY'S ORDINANCE PROHIBITING UNPERMITTED HIGH-OF-WAY ENCROACHMENTS.


FORSYTH COUNTY WATER NOTES

1. NOTIFY FORSYTH COUNTY WATER AND SEWER DEPT. 24 HOURS PRIOR T ANY SEWER CONSTRUCTION AT (404) 623-4241.
2. WATER SERVICE IS PROVIDED BY THE FORSYTH COUNTY DEPARTMENT OF WATER AND SEWER.
3. THE DEVELOPER/CONTRACTOR IS RESPONSIBLE FOR MAINTENANCE OF ALL INFRASTRUCTURE FOR A PERIOD OF 18 MONTHS AFTER THE RECORDING DATE OF THE FINAL PLAT.
4. ALL WORK AND MATERIALS ARE TO CONFORM TO CURRENT FORSYTH COUNTY STANDARDS.
5. THE CONTRACTOR SHALL CALL THE UTILITIES PROTECTION CENTER "CALL BEFORE YOU DIG", TELEPHONE NUMBER 1-800-282-7411, BEFORE INITIATING EXCAVATION ACTIVITIES.
6. ALL WATER LINES SHALL BE DUCTILE IRON PIPE CLASS 50 OR 350.
7. WATER LINES SHALL BE INSTALLED 5' BACK OF CURB.
8. WATER LINES SHALL HAVE AT LEAST 4 FEET OF COVER OR BE 4 FEET BELOW GRADE WHICHEVER IS GREATER.
9. SHORT SIDE SERVICES SHALL BE 3/4\"/>

NOTIFY FORSYTH COUNTY INSPECTOR 24 HOURS BEFORE THE BEGINNING PHASE OF CONSTRUCTION. (770) 781-2165.

I CERTIFY THAT THE PROPOSED WATER DISTRIBUTION SYSTEM HAS BEEN DESIGNED IN ACCORDANCE WITH THE FCDWS SPECIFICATION DOCUMENT TITLED "STANDARD SPECIFICATIONS FOR WATER DISTRIBUTION SYSTEMS AND SANITARY SEWER SYSTEMS", INCLUDING ALL AMENDMENTS.

William J. Taylor
 4-22-20

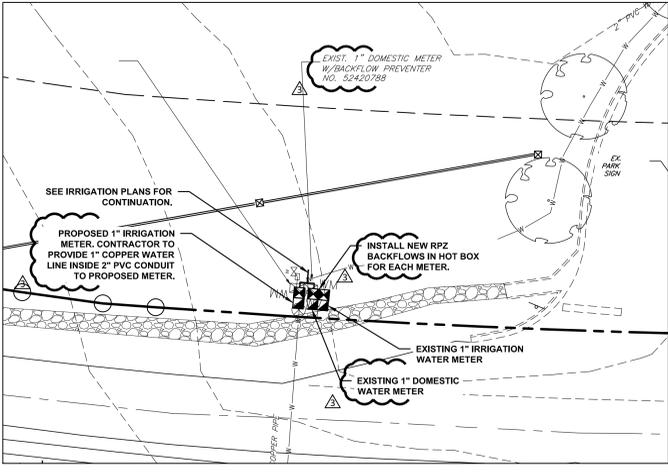

ENLARGEMENT #2




Caney Creek Preserve
 2755 Caney Road, 3055 Caney Road
 Forsyth County

Project No:	17.000291
Date:	01.08.20
Revisions:	
Per County Comments	01.31.20
Per County Comments	03.04.20
Per County Comments	04.27.20

Sheet Title:
Overall Utility Plan

Sheet No:
C400

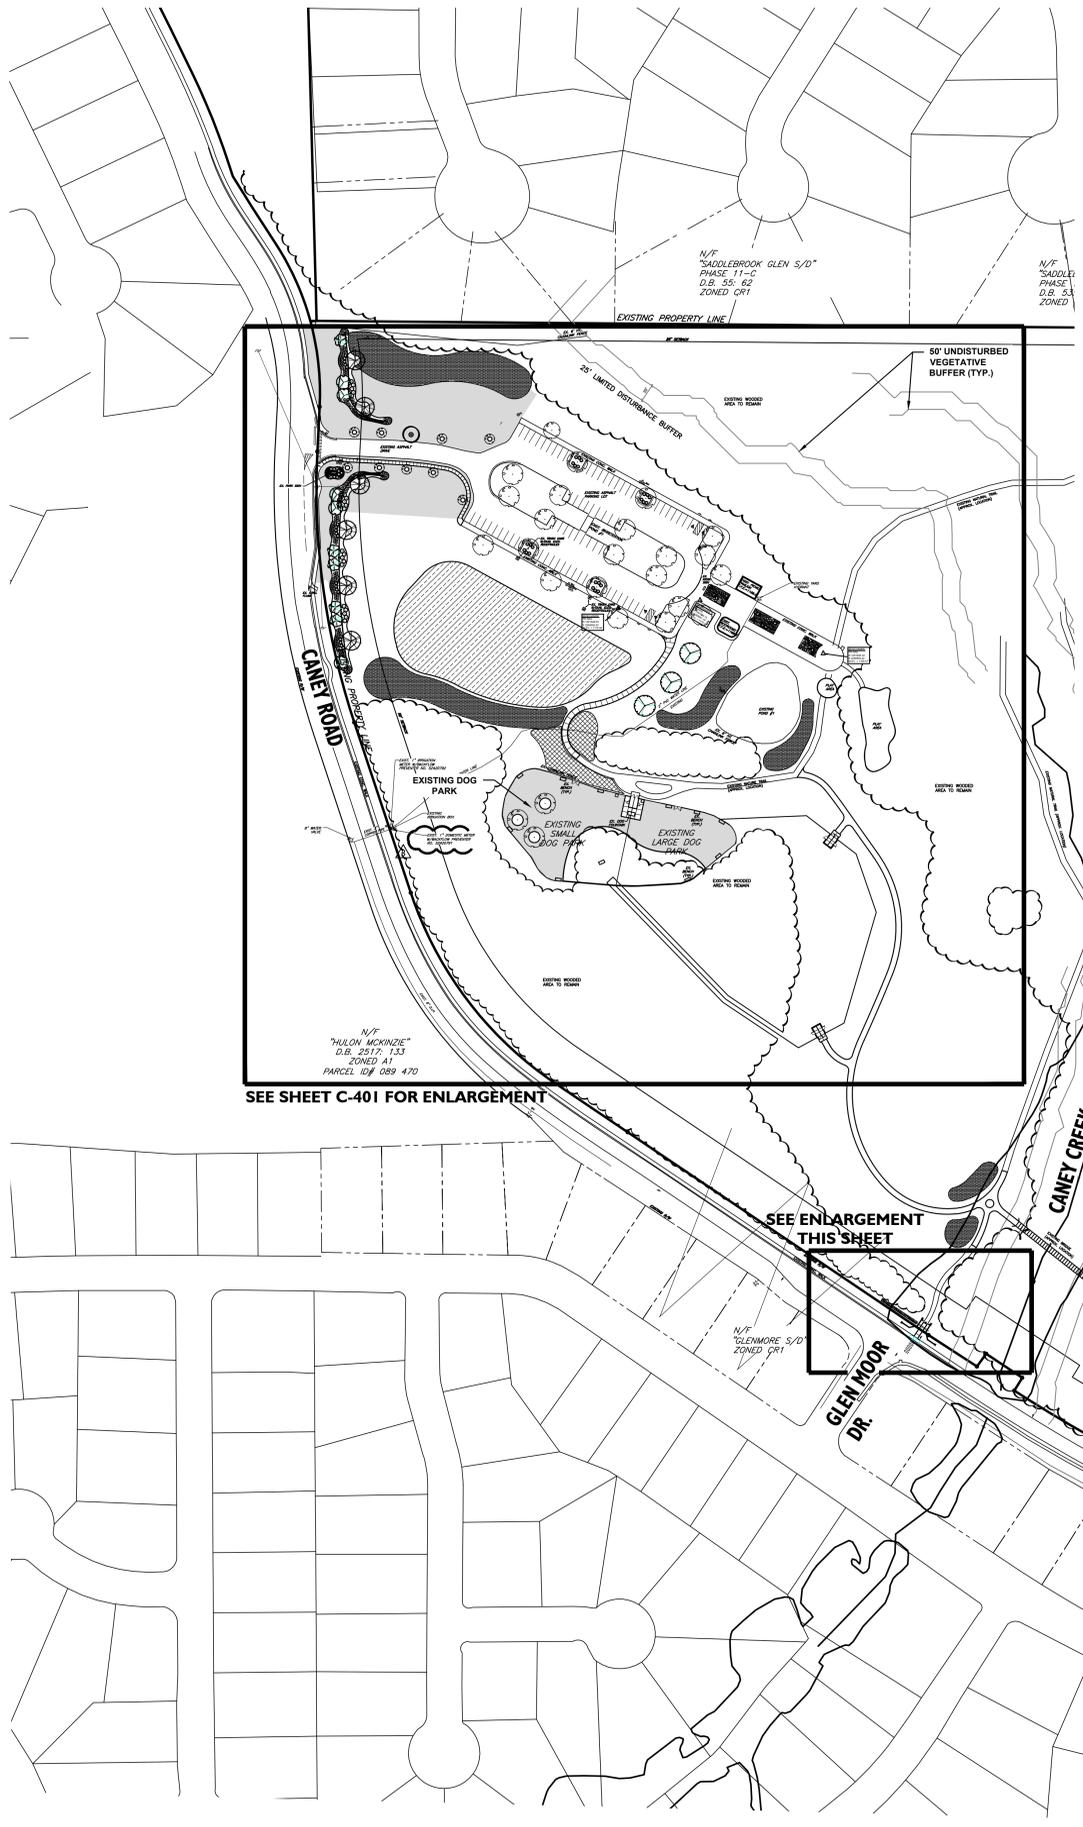


PLANT SCHEDULE

TREES	QTY	BOTANICAL / COMMON NAME	ROOT	CAL.	REMARKS	SIZE
AR	1	Acer rubrum 'Autumn Glory' / Autumn Glory Maple	B & B	2" Cal	MATCHED, STRAIGHT	10-12' HT.
AA	1	Amelanchier arborea 'Autumn Brilliance' / Downy Serviceberry	B & B	1 1/2" per stem	MULTI-STEM	8-10' HT.
CC	11	Cercis canadensis 'Forest Pansy' TM / Forest Pansy Redbud	B & B	1.5" Cal	MATCHED, STRAIGHT	6-8' HT.
CV	10	Chionanthus virginicus 'Spring Fleecing' / White Fringetree	B & B	1 1/2" per stem		6-8' HT.
GB	3	Ginkgo biloba 'Autumn Gold' TM / Maidenhair Tree	B & B	2.5" Cal	MATCHED, STRAIGHT	12-14' ht, 6'-8" w
GT	6	Gleditsia triacanthos 'Skyline' / Skyline Honey Locust	B & B	2" Cal	MATCHED, STRAIGHT	10-12' HT.
PT	2	Pinus taeda / Loblolly Pine	B & B	2" Cal	FULL	8-10' HT.
QS	14	Quercus shumardii / Shumard Red Oak	B & B	2" Cal	MATCHED, STRAIGHT	12-14' ht, 6'-8" w
TO	4	Thuja occidentalis 'Art Boe' TM / North Pole Arborvitae	15 gal		Full, Straight Specimen	5'-6" ht.

SHRUBS	QTY	BOTANICAL / COMMON NAME	CONT	REMARKS	HEIGHT	SPREAD
AZ	56	Azalea Encore 'Autumn Embers' TM / Autumn Embers Azalea	3 gal	3.5" O.C.	15-18" HT.	15-18"
CE	11	Callicarpa dichotoma 'Early Amethyst' / Beautyberry	3 gal	3.5" O.C.	18-24" HT.	18-24"
DV	70	Distylium x Vintage Jade / Vintage Jade Distylium	3 gal	4.5" O.C.	15-18" HT.	18-24"
HR	25	Hibiscus x Robert Fleming / Robert Fleming Hibiscus	3 gal	30" oc	15-18" HT.	18-24"
HP	49	Hydrangea paniculata 'LimeLight' / LimeLight Hydrangea	3 gal	6" O.C.	18-24" HT.	18-24"
HS	27	Hydrangea quercifolia 'Ruby Slippers' / Ruby Slippers Hydrangea	3 gal	4" O.C.	15-18" HT.	18"
IT	112	Itea virginica 'Little Henry' TM / Virginia Sweetgum	3 gal	3" O.C.	15-18" HT.	15-18"
LC2	65	Loropetalum chinense 'Darcuma' / Darcuma Dwarf Loropetalum	3 gal	3" O.C.	15-18" HT.	15-18"
LP	12	Loropetalum chinense 'Purple Pixie' / Purple Pixie Loropetalum	3 gal	4" O.C.	12-15"	15-18"
M22	39	Miscanthus sinensis 'Gracilimus' / Maiden Grass	3 gal	3.5" O.C.	18-24" HT.	18-24"
MR	212	Muhlenbergia capillaris 'Regal Mist' TM / Muhly	3 gal	3" O.C.	12-15"	15-18"
RM	76	Rosa 'Meigilli' / Peach Drift Groundcover Rose	3 gal	24" O.C.	12-15"	12'-15"
RG	44	Rudbeckia fulgida 'Goldstrum' / Black Eyed Susan	1 gal	18" o.c.	12-15"	15-18"
VB	16	Viburnum x burkwoodii / Burkwood Viburnum	7 gal	5" O.C.	24-30" HT.	18-24"

GROUND COVERS	QTY	BOTANICAL / COMMON NAME	CONT	REMARKS	SPACING
BF	30	Iris versicolor / Blue Flag	1 qt.		24" O.C.
JF	28	Juncus effusus / Soft Rush	1 gal		30" O.C.
LB	40	Lobelia siphilitica 'Big Blue' / Blue Lobelia	4" pot		16" O.C.
PT2	319	Pachysandra terminalis / Japanese Spurge	4" pot	12" oc	12" O.C.
PH	120	Panicum virgatum 'Heavy Metal' / Blue Switch Grass	1 gal		30" O.C.
SB	86	Stachys byzantina 'Big Ears' / Lamb's Ear	4" pot		16" O.C.
SL	36	Stokesia laevis / Stokes' Aster	1 gal		16" O.C.
VM	654	Vinca minor / Common Periwinkle	4" pot	16" O.C.	16" O.C.

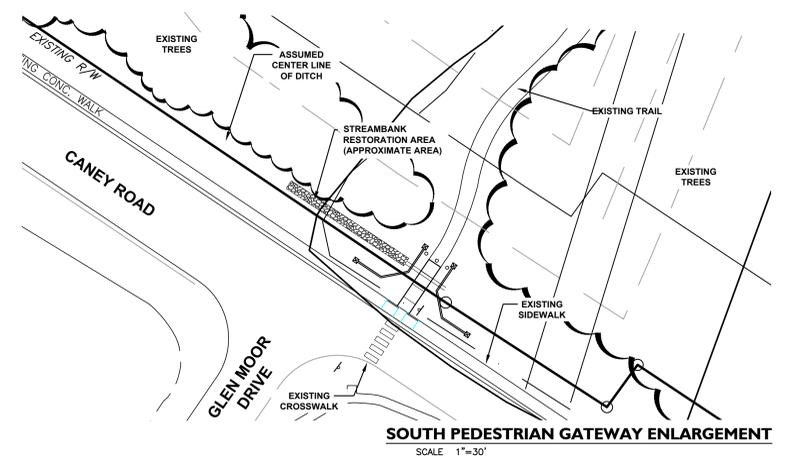

SEE SHEET C-401 FOR ENLARGEMENT

SEE ENLARGEMENT THIS SHEET

SEE SHEET C-402 FOR ENLARGEMENT

BROOKWOOD QUARTERS (MIXED USE DEVELOPMENT)

LANDSCAPE NOTES

PLANT MATERIAL

- MINIMUM TREE SIZE AT PLANTING IS 2" CALIPER AND 9' TALL FOR SINGLE-STEM TREES. ALL MULTI-STEM PLANTS MUST BE TREE FORM, MAXIMUM 3 TO 5 TRUNKS, AND MINIMUM 10' TALL.
- ALL NEW TREES MUST HAVE STRAIGHT TRUNKS WITH STRONG CENTRAL LEADERS INTACT TO THE TOP OF THE CROWN UNLESS MULTI-STEM TREES ARE SPECIFIED. ALL TREES SHALL BE TYPICAL OF THEIR SPECIES AND VARIETY. HAVE NORMAL GROWTH HABITS, HAVE WELL-DEVELOPED BRANCHES, BE VIGOROUS AND HAVE FIBROUS ROOT SYSTEMS. TREES WITH CO-DOMINANT BRANCHING WILL NOT BE ACCEPTED. TREES THAT HAVE BEEN SHEARED, TOPPED OR CUT BACK TO MULTIPLE THE BRANCHING STRUCTURE WILL NOT BE ACCEPTED. TREES SHALL BE FREE OF ABRASIONS, DAMAGE, DISEASE, PESTS AND CRACKS. ALL PRUNING CUTS GREATER THAN 7" DIAMETER SHALL HAVE CALLUS TISSUE FORMED PRIOR TO PLANTING. NO PRUNING CUT ON THE TRUNK SHALL BE MORE THAN ONE-HALF THE DIAMETER OF THE CENTRAL LEADER AT THE HEIGHT WHERE THE CUT WAS MADE. ROOT FLARES SHALL BE LOCATED AT GRADE. TREES WITH MORE THAN 2" OF SOIL COVERING THE ROOT BALL FLARE FROM WILL NOT BE ACCEPTED.
- SIZE OF PLANTS, SPREAD OF ROOTS AND SIZE OF BALLS SHALL BE IN ACCORDANCE WITH ANSI Z90.1 (LATEST EDITION) AS PUBLISHED BY THE AMERICAN NURSERY & LANDSCAPE ASSOCIATION.
- ALL TREES OF A PARTICULAR SPECIES AND VARIETY SHALL BE UNIFORM IN SIZE AND CONFIGURATION.

PLANTING REQUIREMENTS

- PLASTIC HOSE PARTS WILL NOT BE ACCEPTED FOR TREE STAKING. SEE DETAILS AND SPECIFICATIONS FOR APPROVED STAKING METHODS/MATERIALS.
- ALL STRAPPING AND TOP 1/2 OF WIRE BASKET AND BURLAP MUST BE CUT AWAY AND REMOVED FROM ROOT BALL WHEN PLANTING.
- FOR NEW PLANTING AREAS, REMOVE ALL PAVEMENT, GRAVEL, SUB-BASE AND CONSTRUCTION DEBRIS. REMOVE COMPACTED SOIL AND ADD 24" NEW TOPSOIL, OR TILL AND AMEND THE TOP 24" OF EXISTING SOIL TO MEET TOPSOIL PLANTING MIX STANDARDS FOR TREES.
- ALL SAUCERS SHALL BE SOAKED WITH WATER AND MULCHED IMMEDIATELY FOLLOWING PLANTING.
- THE TOP OF ALL ROOT BALLS FOR SHRUBS & GROUNDCOVERS SHALL BEAR THE SAME RELATIONSHIP TO FINISHED GRADE, AS BORN TO PREVIOUS GROWING CONDITIONS.
- ALL ROOT BALLS REMOVED FROM CONTAINERS SHALL BE SCARIFIED PRIOR TO BACKFILLING.
- MULCH A MINIMUM 4 FOOT AREA AROUND EACH TREE AND - MULCH A CONTINUOUS AREA AROUND ALL SHRUB BEDS, AS INDICATED ON THE PLAN. MULCH SHALL BE 3-4" THICK. MULCH AROUND TREES SHALL BE TAPERED TOWARD TRUNK SO THAT NO MORE THAN 2" IS PLACED AT TREE TRUNK AS SHOWN ON DETAIL. SEE SPECIFICATIONS FOR TYPE.

UTILITY ISSUES

- LARGE MATURING TREES MAY NOT BE PLANTED WITHIN 20' OF OVERHEAD POWER DISTRIBUTION OR TRANSMISSION LINES. IF TREES CONFLICT WITH POWER LINES OR SIGNS, CALL LANDSCAPE ARCHITECT TO RESOLVE BEFORE PLANTING.
- CONTRACTOR IS RESPONSIBLE FOR HAVING ALL UNDERGROUND UTILITIES LOCATED AND CLEARLY PAINTED WITHIN 10 DAYS OF ANY GROUND DISTURBING ACTIVITY. OWNER WILL NOT PAY FOR UTILITY REPAIRS DUE TO FAILURE TO MARK AND OBSERVE UTILITY LOCATIONS.
- ADJUST TREE PLANTING LOCATIONS TO AVOID UNDERGROUND UTILITIES. PLANT 15' FROM ALL UNDERGROUND UTILITIES (SEWER AND STORM DRAINAGE, GAS WATER, PHONE AND ELECTRICAL LINES).

GENERAL

- THE LANDSCAPE CONTRACTOR SHALL BE RESPONSIBLE FOR THE QUANTITY OF PLANTS SHOWN ON THE PLAN. ANY DISCREPANCIES BETWEEN QUANTITIES ON PLAN AND PLANT LIST SHALL BE BROUGHT TO THE ATTENTION OF THE LANDSCAPE ARCHITECT AND ANY FIELD ADJUSTMENTS OR QUANTITY ADJUSTMENTS MUST BE AUTHORIZED PRIOR TO PLANTING.
- ALL PLANTS SHALL BE GUARANTEED TO BE IN HEALTHY CONDITION FOR ONE (1) YEAR AFTER ACCEPTANCE BY OWNER OF ALL PLANT MATERIAL.
- ALL DISTURBED AREAS SHALL BE SEEDED AS SPECIFIED.
- SEE EROSION CONTROL/GRADING PLAN FOR ADDITIONAL TREE PRESERVATION NOTES.

NOTIFY FORSYTH COUNTY INSPECTOR 24 HOURS BEFORE THE BEGINNING PHASE OF CONSTRUCTION. (770) 781-2165.

benesch
 Alfred Benesch & Company
 2359 Perimeter Pointe Parkway, Suite 200
 Charlotte, NC 28203
 www.benesch.com
 P 704.521.9880

Seals:


Corp. NC License: F-1320

Caney Creek Preserve
 2755 Caney Road, 3055 Caney Road
 Forsyth County

Project No:	17.000291
Date:	01.08.20
Revisions:	
	01.31.20
	03.04.20
	04.27.20

Sheet Title:
Overall Landscape Plan

Sheet No:
C500

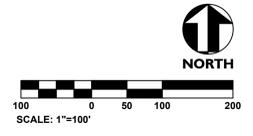

IRRIGATION LEGEND

- #1, #2 [Symbol] NEW PROPOSED 1" IRRIGATION WATER METER INSTALLED NEXT TO EXISTING 1" DOMESTIC WATER METER (NOT FOR IRRIGATION) AND EXISTING 1" IRRIGATION WATER METER (TO BE USED FOR IRRIGATION). EACH SYSTEM REQUIRES 55 GPM @ 75 PSI. IRRIGATION CONTRACTOR SHALL BE RESPONSIBLE TO VERIFY THE SYSTEM REQUIREMENTS AT SITE BEFORE STARTING CONSTRUCTION.
- #1a, #1b, #2a, #2b [Symbol] MANUAL DRAIN VALVE, SCH 80 PVC TRUE UNION BALL VALVE, DETAIL-E.
- #1, #2 [Symbol] WATTS #909-M1-QT-1", 1" REDUCED PRESSURE ASSEMBLY BACKFLOW PREVENTER IN HOT BOX, DETAIL-F.
- #1, #2 [Symbol] WINTERIZATION ASSEMBLY, DETAIL-M.
- #1, #2 [Symbol] EXISTING RAIN BIRD LXME CONTROLLER(S). INSTALLATION CONTRACTOR SHALL ADD (2) 8 STATION EXPANSION MODULE TO EACH CONTROLLER. INSTALLATION CONTRACTOR SHALL ENSURE THAT EACH CONTROLLER HAS A RAIN/FREEZE SENSOR.
- #1, #2 [Symbol] 2" IRRIGATION PRESSURE REDUCING VALVE, WATTS U58-23-HP, WITH HIGH TENSION SPRING, FOR OPERATION BETWEEN 70 AND 100 PSI, DETAIL-J.
- [Symbol] RAIN BIRD 150-PEB-PRS PLASTIC ELECTRIC REMOTE CONTROL VALVE, 1 1/2" SIZE, MOUNTED WITH SCH 80 PVC TRUE UNION BALL VALVE WITH PRESSURE REGULATION DEVICES, DETAIL-A.
- [Symbol] RAIN BIRD 100-PEB-PRS PLASTIC ELECTRIC REMOTE CONTROL VALVE, 1" SIZE, MOUNTED WITH SCH 80 PVC TRUE UNION BALL VALVE WITH PRESSURE REGULATION DEVICES, DETAIL-A.
- [Symbol] RAIN BIRD 1806-SAM, 6" POP-UP LAWN SPRAY SPRINKLER, 12" RADIUS, FULL-2.0 GPM, HALF-1.0 GPM, QUARTER-0.5 GPM, 30 PSI, DETAIL-C.
- [Symbol] RAIN BIRD 1806-SAM, 6" POP-UP LAWN SPRAY SPRINKLER, 15" RADIUS, FULL-4.0 GPM, HALF-2.0 GPM, QUARTER-1.0 GPM, 30 PSI, DETAIL-C.
- [Symbol] RAIN BIRD 1806-SAM, 6" LAWN POP-UP SIDE STRIP SPRAY SPRINKLER, 9' X 18' RADIUS, 1.5 GPM, 30 PSI, DETAIL-C.
- [Symbol] RAIN BIRD 1806-SAM, 6" LAWN SIDE STRIP SPRAY SPRINKLER, 4' X 30' RADIUS, 1.5 GPM, 30 PSI, DETAIL-C.
- [Symbol] RAIN BIRD 1806-SAM, 6" LAWN END STRIP SPRAY SPRINKLER, 4' X 15' RADIUS, 1.0 GPM, 30 PSI, DETAIL-C.
- [Symbol] RAIN BIRD 1812-SAM, 12" HI-POP SHRUB SPRAY SPRINKLER, 15' RADIUS, FULL-4.0 GPM, HALF-2.0 GPM, QUARTER-3.0 GPM, 30 PSI, DETAIL-D.
- [Symbol] RAIN BIRD 1812-SAM, 12" HI-POP SHRUB SPRAY SPRINKLER, 12' RADIUS, FULL-2.0 GPM, 30 PSI, DETAIL-D.
- [Symbol] RAIN BIRD 1812-SAM, 12" HI-POP SHRUB SIDE STRIP SPRAY SPRINKLER, 9' X 18' RADIUS, 1.5 GPM, 30 PSI, DETAIL-D.
- [Symbol] RAIN BIRD 1812-SAM, 12" HI-POP SHRUB SIDE STRIP SPRAY SPRINKLER, 4' X 30' RADIUS, 1.5 GPM, 30 PSI, DETAIL-D.
- [Symbol] RAIN BIRD 1812-SAM, 12" HI-POP SHRUB END STRIP SPRAY SPRINKLER, 4' X 15' RADIUS, 1.0 GPM, 30 PSI, DETAIL-D.
- [Symbol] RAIN BIRD 1806-SAM WITH 1404 BUBBLER NOZZLE AND PA-80 ADAPTER, 6" POP-UP TREE BUBBLER, 1.0 GPM, DETAIL-C.
- [Symbol] HUNTER I-20-06-SS LAWN ROTOR WITH STAINLESS STEEL RISERS, 40' RADIUS, FULL-8.0 GPM, HALF-4.0 GPM, QUARTER-2.0 GPM, 45 PSI, DETAIL-B.
- [Symbol] HUNTER I-20-06-SS LAWN ROTOR WITH STAINLESS STEEL RISERS, 30' RADIUS, FULL-4.0 GPM, HALF-2.0 GPM, QUARTER-1.0 GPM, 45 PSI, DETAIL-B.
- [Symbol] HUNTER INDUSTRIES MP ROTATOR SERIES 3000, MOUNTED ON RAIN BIRD 1806-SAM SPRINKLER IN LAWN, 30' RADIUS, FULL-2.0 GPM, HALF-1.0 GPM, QUARTER-1.0 GPM, 40 PSI, DETAIL-C.
- [Symbol] HUNTER INDUSTRIES MP ROTATOR SERIES 2000, MOUNTED ON RAIN BIRD 1806-SAM SPRINKLER IN LAWN, 20' RADIUS, FULL-2.0 GPM, HALF-1.0 GPM, QUARTER-0.5 GPM, 40 PSI, DETAIL-C.
- [Symbol] HUNTER INDUSTRIES MP ROTATOR SERIES 3000, MOUNTED ON RAIN BIRD 1812-SAM SPRINKLER IN BED AREAS, 30' RADIUS, FULL-4.0 GPM, HALF-2.0 GPM, QUARTER-1.0 GPM, 40 PSI, DETAIL-D.
- [Symbol] HUNTER INDUSTRIES MP ROTATOR SERIES 2000, MOUNTED ON RAIN BIRD 1812-SAM SPRINKLER IN BED AREA, 20' RADIUS, FULL-2.0 GPM, HALF-1.0 GPM, QUARTER-0.5 GPM, 40 PSI, DETAIL-D.
- [Symbol] RAIN BIRD #5 QUICK COUPLING VALVE 1" SIZE. CONTRACTOR TO SUPPLY TWO QCV KEYS AND MATCHING HOSE SWIVELS, DETAIL-K.
- [Symbol] SCH 80 PVC TRUE UNION BALL VALVE, SIZED SAME AS MAINLINE, MOUNTED IN CARSON VALVE BOX, DETAIL-L.
- [Symbol] MAINLINE PIPE: 2" SIZE IF NOT NOTED. CLASS 200 PVC SOLVENT WELD PIPE UTILIZING SCH 40 PVC SOLVENT WELD FITTINGS.
- [Symbol] IRRIGATION SLEEVE: CLASS 200 PVC, SIZE NOTED ON PLAN, DETAIL-H.
- [Symbol] LATERAL LINE PIPE: CLASS 200 PVC SOLVENT WELD PIPE UTILIZING SCH 40 PVC SOLVENT WELD FITTINGS, SIZE NOTED.
- [Symbol] 3" ELECTRICAL CONDUIT SLEEVE.

- NOTES:
- ALL SPRINKLERS WILL BE MOUNTED ON (3) MARLEX STREET ELLS WITH A SCHED. 80 NIPPLE SIZE OF SPRINKLER INLET.
 - CONTRACTOR TO UTILIZE AN AUTOMATIC DRAIN CHECK VALVE DEVICE WHERE LOW HEAD DRAINAGE MAY OCCUR.
 - ALL WIRE WILL BE COLOR CODED DIRECT BURIAL UL/UF WIRE: COMMON (WHITE) #12-1, CONTROL, (RED) #14-1.
 - ALL PIPING AND WIRING UNDER HARDTOPS WILL BE IN CLASS 200 PVC PIPE SLEEVE.
- TYPICAL VALVE INDICATOR
- 28.5 GALLONS PER MIN.
 10 STATION NUMBER
 1" VALVE SIZE


GENERAL NOTES

- ALL MAINLINES TO HAVE A MINIMUM OF 18" OF COVER. (CLASS 200 PVC PIPE).
- ALL LATERAL AND SUB-MAIN PIPE TO HAVE A MINIMUM OF 12" OF COVER. (CLASS 200 PVC PIPE).
- NO ROCKS, BOULDER, OR OTHER EXTRANEUS MATERIALS TO BE USED IN BACKFILLING OF TRENCH.
- ALL PIPE TO BE INSTALLED AS PER MANUFACTURERS' SPECIFICATIONS.
- ALL THREADED JOINTS TO BE COATED WITH TEFLON TAPE OR LIQUID TEFLON.
- ALL LINES TO BE THOROUGHLY FLUSHED BEFORE INSTALLATION OF SPRINKLER HEADS.
- SPRINKLER AND RELATED EQUIPMENT TO BE INSTALLED AS PER DETAILS.
- ALL ELECTRICAL JOINTS TO BE MADE USING WATERPROOF CONNECTIONS AS SHOWN ON DETAILS.
- ALL EQUIPMENT NOT SPECIFIED IN THE LEGEND SHALL BE DETERMINED AND FURNISHED BY THE CONTRACTOR.
- NO ELECTRICAL CONNECTIONS SHALL BE MADE IN THE FIELD EXCEPT AT A VALVE CONTROL BOX OR ANOTHER VALVE BOX SPECIFICALLY FOR CONNECTIONS.
- ANY DISCREPANCY BETWEEN THIS SHEET AND OTHERS IN THIS SET MUST BE REFERRED TO THE IRRIGATION CONSULTANT BY THE CONTRACTOR FOR CLARIFICATION BEFORE PRECEEDING WITH THE WORK.
- ALL 24 VOLT WIRE SHALL BE #12 UF/UL FOR COMMON WIRE, AND #14 UF/UL FOR CONTROL WIRES, DIRECT BURIAL, SOLID COPPER.
- CONTRACTOR TO BE RESPONSIBLE FOR PROPER COVERAGE OF AREAS TO BE WATERED, I.E. ADJUST HEADS WITH INSUFFICIENT COVERAGE DUE TO BLOCKAGE BY EXISTING OR PROPOSED SITE FEATURES.
- CONTRACTOR TO REFER TO LANDSCAPE PLAN TO KEEP SPRINKLER EQUIPMENT AND ACCESSORY MATERIAL FROM INTERFERING WITH PROPER PLANTING, I.E. VERIFY ROOT BALL SIZE FOR PLANTING.
- CONTRACTOR SHALL PROVIDE EXPANSION COILS AT EACH WIRE CONNECTION IN VALVE BOX (WRAP AROUND 3/4" PIPE 12 TIMES).
- CONTRACTOR TO UTILIZE APPROPRIATE AUTOMATIC DRAIN DEVICE WHERE LOW HEAD DRAINAGE MAY OCCUR.
- ALL SPRINKLERS TO BE MOUNTED ON SWING JOINTS - REFER TO DETAILS.
- CONTRACTOR SHALL UTILIZE VALVE I.D. TAGS ON ALL REMOTE CONTROL VALVES.
- 24 VOLT WIRE SHALL BE COLOR CODED: COMMON-WHITE, CONTROL-RED.
- CONTRACTOR SHALL INSTALL MANUFACTURERS' RECOMMENDED GROUNDING EQUIPMENT FOR POWER SUPPLY AND VALVE OUTPUT WITH (2) #8 COPPER GLAD GROUND RODS.
- CONTRACTOR SHALL INSTALL MANUFACTURERS' RECOMMENDATION ON FAULT GROUND AND LIGHTNING PROTECTION.
- CONTROLLER GROUNDING MUST BE AS PER ASIC REQUIREMENTS
- ALL MATERIAL TO BE SUPPLIED BY CONTRACTOR TO OWNER.
- TWO WRENCHES FOR DISASSEMBLING AND ADJUSTING EACH TYPE OF SPRINKLER HEADS AND VALVE SUPPLIED.
- TWO QUICK COUPLER KEYS WITH MATCHING HOSE SWIVELS.
- SYSTEM IS DIAGRAMATIC TO IMPROVE CLARITY. ALL MAINLINE PIPING, ELECTRIC VALVES AND WIRING ARE TO BE INSTALLED IN LANDSCAPE AREAS AND WITHIN PROPERTY BOUNDARIES. CONTRACTOR SHALL REFERENCE THE LANDSCAPE PLAN PRIOR TO THE INSTALLATION OF PIPING TO AVOID CONTACT WITH PLANT MATERIALS EXISTING OR NEW.
- CONTRACTOR TO ADD EXTENSION RISER TO POP-UP HEADS WHEN NEEDED FOR PROPER COVERAGE.
- CONTRACTOR SHALL INSTALL SPRINKLER EQUIPMENT 12" FROM FOUNDATIONS. ALSO INSTALL SPRINKLERS 4" FROM CURBS OR WALKS.
- PRIOR TO BID, CONTRACTOR SHALL VERIFY RIGHT-OF-WAY AND BACKFLOW REQUIREMENTS. NO LATER THAN FIVE DAYS BEFORE BID SUBMITTALS CONTRACTOR SHALL NOTIFY CONSULTANT OF ANY CHANGES FROM PLANS AND SPECIFICATIONS.
- IRRIGATION CONTRACTOR SHALL PROVIDE THE OWNER AND LANDSCAPE ARCHITECT WITH A REPRODUCIBLE CROSS MEASURED AS-BUILT DRAWING OF THE INSTALLED IRRIGATION SYSTEM IN AUTOCAD 2017 FORMAT BEFORE FINAL ACCEPTANCE.
- A 1-YEAR WARRANTY PERIOD SHALL BE PROVIDED FOR SYSTEM AFTER SUBSTANTIAL COMPLETION IS ACCEPTED. START UP AND ADJUSTING OF SYSTEM IN SPRING TIME SHALL BE INCLUDED IN WARRANTY.
- PRIOR TO BID, CONTRACTOR SHALL VERIFY THAT ALL MATERIALS, INSTALLATION PARAMETERS AND OPERATIONS CONFORM TO ALL APPLICABLE CODES AND ORDINANCES. NO LATER THAN FIVE DAYS BEFORE BID SUBMITTALS CONTRACTOR SHALL NOTIFY IRRIGATION CONSULTANT/DESIGNER OF ANY CHANGES REQUIRED DUE TO CURRENT CODE OR ORDINANCE DISCREPANCIES. IF CONTRACTOR DOES NOT COMPLY TO THIS NOTIFICATION, THE CONTRACTOR SHALL BE RESPONSIBLE FOR ALL NECESSARY INSTALLATION CHANGE AND REDESIGN COSTS FOR NON-COMPLIANCE.
- UNLESS OTHERWISE NOTED, THE CONTRACTOR MUST COMPLETE 2 PRESSURE TESTS OF THE IRRIGATION SYSTEM MAINLINE (BOTH TO SHOW NO DROP IN PRESSURE DURING DURATION OF TEST).
 - 2-HOUR PRESSURE TEST AT 1.5 TIMES THE SYSTEM STATIC PRESSURE
 - 24-HOUR PRESSURE TEST AT THE SYSTEM STATIC PRESSURE
- IRRIGATION INSTALLATION CONTRACTOR SHALL PROVIDE OWNER WITH A COLOR-CODED ZONES DIAGRAM PLAN, 8-1/2" X 11" LAMINATED SHEETS(S), TO IDENTIFY CONTROL STATION TO THE CONTROL VALVE NUMBER FOR EACH CONTROLLER. TO BE LOCATED IN ADHESIVE POUCH ATTACHED INSIDE OF CONTROLLER(S).


CONTRACTOR INSTALLATION NOTES:

- CONTRACTOR SHALL LOCATE AND REPAIR IRRIGATION THAT IS NOT IMPACTED BY THE NEW INSTALLATION. ASSUME TO ADD \$2,000.00 TO A LINE ITEM OF YOUR BID FOR EACH PARK AREA.
- CONTRACTOR SHALL TURN OFF AND CAP EXISTING IRRIGATION THAT FORSYTH COUNTY PARKS DESIGNATES AS NOT BEING UTILIZED

NOTE:
 NOTIFY FORSYTH COUNTY INSPECTOR 24 HOURS BEFORE THE BEGINNING PHASE CONSTRUCTION, (770) 781-2165.

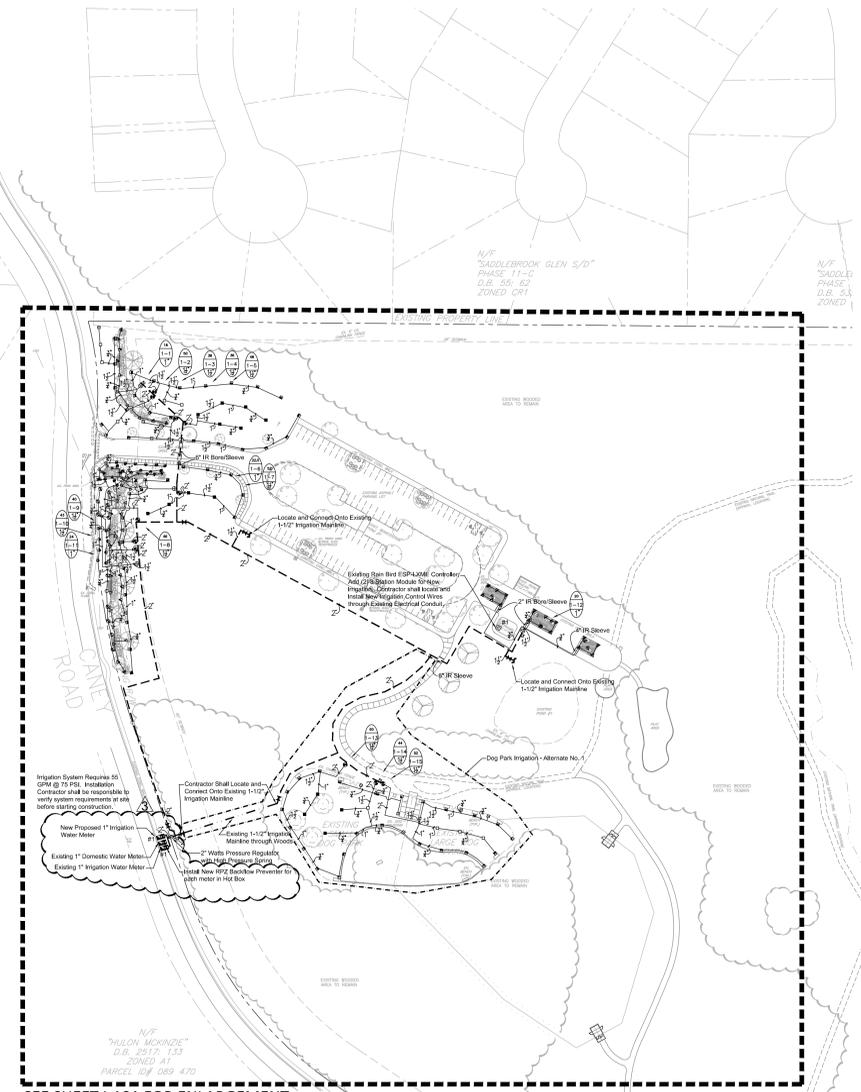

SEE SHEET I-101 FOR ENLARGEMENT

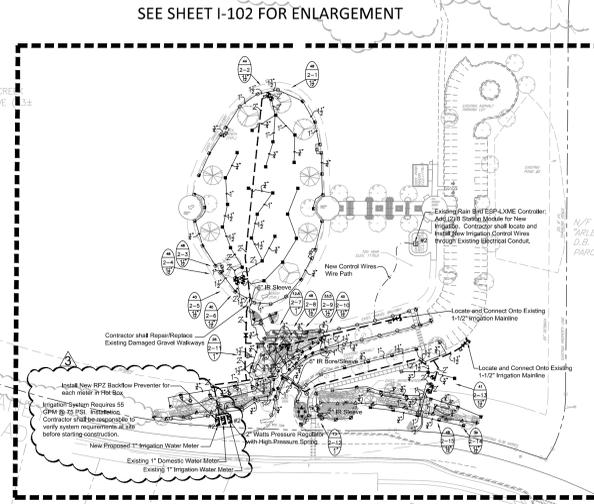

SEE SHEET I-102 FOR ENLARGEMENT

UTILITY NOTE:
 REFER TO UTILITY PLANS FOR MORE SPECIFICS RELATED TO IRRIGATION WATER METER TAPS, COPPER LINE RUNNING FROM TAPS TO PROPOSED METERS AND ACTUAL PROPOSED METER LOCATIONS.

NOTE:
 IRRIGATION SYSTEMS ARE PROHIBITED ON ALL EXISTING AND PROPOSED COUNTRY RIGHT-OF-WAY AND CONSIDERED TO BE A VIOLATION OF THE COUNTY'S ORDINANCE PROHIBITING UNPERMITTED RIGHT-OF-WAY ENCROACHMENTS.

Seals:

PRELIMINARY
 NOT FOR
 CONSTRUCTION

Corp. NC License: F-1320

Caney Creek Preserve
 2755 Caney Road
 Atlanta, Georgia 30005

Project No: 17.000291
 Date: 11.15.19

Revisions:

Per County Comments	02.12.20
Per County Comments	03.05.20
Per County Comments	04.27.20

Sheet Title:
**Irrigation Plan
 Enlargement-
 West**


Sheet No:
1101

IRRIGATION LEGEND

- #1, #2 [Symbol] NEW PROPOSED 1" IRRIGATION WATER METER INSTALLED NEXT TO EXISTING 1" DOMESTIC WATER METER (NOT FOR IRRIGATION) AND EXISTING 1" IRRIGATION WATER METER (TO BE USED FOR IRRIGATION). EACH SYSTEM REQUIRES 55 GPM @ 75 PSI. IRRIGATION CONTRACTOR SHALL BE RESPONSIBLE TO VERIFY THE SYSTEM REQUIREMENTS AT SITE BEFORE STARTING CONSTRUCTION.
- #1a, #1b, #2a, #2b [Symbol] MANUAL DRAIN VALVE. SCH 80 PVC TRUE UNION BALL VALVE. DETAIL-E.
 WATTS #909-M1-QT-1". 1" REDUCED PRESSURE ASSEMBLY BACKFLOW PREVENTER IN HOT BOX. DETAIL-F.
- #1, #2 [Symbol] WINTERIZATION ASSEMBLY. DETAIL-M.
- #1, #2 [Symbol] EXISTING RAIN BIRD LXME CONTROLLER(S). INSTALLATION CONTRACTOR SHALL ADD (2) 8 STATION EXPANSION MODULE TO EACH CONTROLLER. INSTALLATION CONTRACTOR SHALL ENSURE THAT EACH CONTROLLER HAS A RAIN/FREEZE SENSOR.
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- [Symbol] RAIN BIRD 150-PEB-PRS PLASTIC ELECTRIC REMOTE CONTROL VALVE, 1 1/2" SIZE. MOUNTED WITH SCH 80 PVC TRUE UNION BALL VALVE WITH PRESSURE REGULATION DEVICES. DETAIL-A.
- [Symbol] RAIN BIRD 100-PEB-PRS PLASTIC ELECTRIC REMOTE CONTROL VALVE, 1" SIZE. MOUNTED WITH SCH 80 PVC TRUE UNION BALL VALVE WITH PRESSURE REGULATION DEVICES. DETAIL-A.
- [Symbol] RAIN BIRD 1806-SAM, 6" POP-UP LAWN SPRAY SPRINKLER, 12" RADIUS, FULL-2.0 GPM, HALF-1.0 GPM, QUARTER-0.5 GPM, 30 PSI. DETAIL-C.
- [Symbol] RAIN BIRD 1806-SAM, 6" POP-UP LAWN SPRAY SPRINKLER, 15" RADIUS, FULL-4.0 GPM, HALF-2.0 GPM, QUARTER-1.0 GPM, 30 PSI. DETAIL-C.
- [Symbol] RAIN BIRD 1806-SAM, 6" LAWN POP-UP SIDE STRIP SPRAY SPRINKLER, 9' X 18' RADIUS, 1.5 GPM, 30 PSI. DETAIL-C.
- [Symbol] RAIN BIRD 1806-SAM, 6" LAWN SIDE STRIP SPRAY SPRINKLER, 4' X 30' RADIUS, 1.5 GPM, 30 PSI. DETAIL-C.
- [Symbol] RAIN BIRD 1806-SAM, 6" LAWN END STRIP SPRAY SPRINKLER, 4' X 15' RADIUS, 1.0 GPM, 30 PSI. DETAIL-C.
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- [Symbol] RAIN BIRD 1812-SAM, 12" HI-POP SHRUB SPRAY SPRINKLER, 12" RADIUS, FULL-2.0 GPM, 30 PSI. DETAIL-D.
- [Symbol] RAIN BIRD 1812-SAM, 12" HI-POP SHRUB SIDE STRIP SPRAY SPRINKLER, 9' X 18' RADIUS, 1.5 GPM, 30 PSI. DETAIL-D.
- [Symbol] RAIN BIRD 1812-SAM, 12" HI-POP SHRUB SIDE STRIP SPRAY SPRINKLER, 4' X 30' RADIUS, 1.5 GPM, 30 PSI. DETAIL-D.
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- [Symbol] RAIN BIRD 1806-SAM WITH 1404 BUBBLER NOZZLE AND PA-80 ADAPTER, 6" POP-UP TREE BUBBLER, 1.0 GPM. DETAIL-C.
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- [Symbol] HUNTER I-20-06-SS LAWN ROTOR WITH STAINLESS STEEL RISERS, 30" RADIUS, FULL-4.0 GPM, HALF-2.0 GPM, QUARTER-1.0 GPM, 45 PSI. DETAIL-B.
- [Symbol] HUNTER INDUSTRIES MP ROTATOR SERIES 3000, MOUNTED ON RAIN BIRD 1806-SAM SPRINKLER IN LAWN, 30" RADIUS, FULL-4.0 GPM, HALF-2.0 GPM, QUARTER-1.0 GPM, 40 PSI. DETAIL-C.
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- [Symbol] RAIN BIRD #5 QUICK COUPLING VALVE 1" SIZE. CONTRACTOR TO SUPPLY TWO QCV KEYS AND MATCHING HOSE SWIVELS. DETAIL-K.
- [Symbol] SCH 80 PVC TRUE UNION BALL VALVE, SIZED SAME AS MAINLINE, MOUNTED IN CARSON VALVE BOX. DETAIL-L.
- [Symbol] MAINLINE PIPE: 2" SIZE IF NOT NOTED. CLASS 200 PVC SOLVENT WELD PIPE UTILIZING SCH 40 PVC SOLVENT WELD FITTINGS.
- [Symbol] IRRIGATION SLEEVE: CLASS 200 PVC, SIZE NOTED ON PLAN. DETAIL-H.
- [Symbol] LATERAL LINE PIPE: CLASS 200 PVC SOLVENT WELD PIPE UTILIZING SCH 40 PVC SOLVENT WELD FITTINGS, SIZE NOTED.
- [Symbol] 3" ELECTRICAL CONDUIT SLEEVE.


- NOTES:
- ALL SPRINKLERS WILL BE MOUNTED ON (3) MARLEX STREET ELLS WITH A SCHED. 80 NIPPLE SIZE OF SPRINKLER INLET.
 - CONTRACTOR TO UTILIZE A AUTOMATIC DRAIN CHECK VALVE DEVICE WHERE LOW HEAD DRAINAGE MAY OCCUR.
 - ALL WIRE WILL BE COLOR CODED DIRECT BURIAL UL/UF WIRE: COMMON (WHITE) #12-1, CONTROL (RED) #14-1.
 - ALL PIPING AND WIRING UNDER HARDTOPS WILL BE IN CLASS 200 PVC PIPE SLEEVE.

TYPICAL VALVE INDICATOR

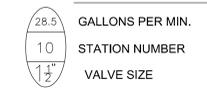

GENERAL NOTES

- ALL MAINLINES TO HAVE A MINIMUM OF 18" OF COVER. (CLASS 200 PVC PIPE).
- ALL LATERAL AND SUB-MAIN PIPE TO HAVE A MINIMUM OF 12" OF COVER. (CLASS 200 PVC PIPE).
- NO ROCKS, BOULDER, OR OTHER EXTRANEIOUS MATERIALS TO BE USED IN BACKFILLING OF TRENCH.
- ALL PIPE TO BE INSTALLED AS PER MANUFACTURERS' SPECIFICATIONS.
- ALL THREADED JOINTS TO BE COATED WITH TEFLON TAPE OR LIQUID TEFLON.
- ALL LINES TO BE THOROUGHLY FLUSHED BEFORE INSTALLATION OF SPRINKLER HEADS.
- SPRINKLER AND RELATED EQUIPMENT TO BE INSTALLED AS PER DETAILS.
- ALL ELECTRICAL JOINTS TO BE MADE USING WATERPROOF CONNECTIONS AS SHOWN ON DETAILS.
- ALL EQUIPMENT NOT SPECIFIED IN THE LEGEND SHALL BE DETERMINED AND FURNISHED BY THE CONTRACTOR.
- NO ELECTRICAL CONNECTIONS SHALL BE MADE IN THE FIELD EXCEPT AT A VALVE CONTROL BOX OR ANOTHER VALVE BOX SPECIFICALLY FOR CONNECTIONS.
- ANY DISCREPANCY BETWEEN THIS SHEET AND OTHERS IN THIS SET MUST BE REFERRED TO THE IRRIGATION CONSULTANT BY THE CONTRACTOR FOR CLARIFICATION BEFORE PROCEEDING WITH THE WORK.
- ALL 24 VOLT WIRE SHALL BE #12 UF/UL FOR COMMON WIRE, AND #14 UF/UL FOR CONTROL WIRES. DIRECT BURIAL. SOLID COPPER.
- CONTRACTOR TO BE RESPONSIBLE FOR PROPER COVERAGE OF AREAS TO BE WATERED. I.E. ADJUST HEADS WITH INSUFFICIENT COVERAGE DUE TO BLOCKAGE BY EXISTING OR PROPOSED SITE FEATURES.
- CONTRACTOR TO REFER TO LANDSCAPE PLAN TO KEEP SPRINKLER EQUIPMENT AND ACCESSORY MATERIAL FROM INTERFERING WITH PROPER PLANTING. I.e. VERIFY ROOT BALL SIZE FOR PLANTING.
- CONTRACTOR SHALL PROVIDE EXPANSION COILS AT EACH WIRE CONNECTION IN VALVE BOX (WRAP AROUND 3/4" PIPE 12 TIMES).
- CONTRACTOR TO UTILIZE APPROPRIATE AUTOMATIC DRAIN DEVICE WHERE LOW HEAD DRAINAGE MAY OCCUR.
- ALL SPRINKLERS TO BE MOUNTED ON SWING JOINTS - REFER TO DETAILS.
- CONTRACTOR SHALL UTILIZE VALVE I.D. TAGS ON ALL REMOTE CONTROL VALVES.
- 24 VOLT WIRE SHALL BE COLOR CODED; COMMON-WHITE, CONTROL-RED.
- CONTRACTOR SHALL INSTALL MANUFACTURERS' RECOMMENDED GROUNDING EQUIPMENT FOR POWER SUPPLY AND VALVE OUTPUT WITH (2) #8" COPPER CLAD GROUND RODS.
- CONTRACTOR SHALL INSTALL MANUFACTURERS' RECOMMENDATION ON FAULT GROUND AND LIGHTNING PROTECTION.
- CONTROLLER GROUNDING MUST BE AS PER ASIC REQUIREMENTS
- ALL MATERIAL TO BE SUPPLIED BY CONTRACTOR TO OWNER.
- TWO WRENCHES FOR DISASSEMBLING AND ADJUSTING EACH TYPE OF SPRINKLER HEADS AND VALVE SUPPLIED.
- TWO KEYS FOR EACH OF THE AUTOMATIC CONTROLLERS.
- TWO QUICK COUPLER KEYS WITH MATCHING HOSE SWIVELS.
- SYSTEM IS DIAGRAMMATIC TO IMPROVE CLARITY. ALL MAINLINE PIPING ELECTRIC VALVES AND WIRING ARE TO BE INSTALLED IN LANDSCAPE AREAS AND WITHIN PROPERTY BOUNDARIES. CONTRACTOR SHALL REFERENCE THE LANDSCAPE PLAN PRIOR TO THE INSTALLATION OF PIPING TO AVOID CONTACT WITH PLANT MATERIALS EXISTING OR NEW.
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- PRIOR TO BID IRRIGATION CONTRACTOR SHALL VERIFY RIGHT-OF-WAY AND BACKFLOW REQUIREMENTS. NO LATER THAN FIVE DAYS BEFORE BID SUBMITTALS CONTRACTOR SHALL NOTIFY CONSULTANT OF ANY CHANGES FROM PLANS AND SPECIFICATIONS.
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 - 2-HOUR PRESSURE TEST AT 1.5 TIMES THE SYSTEM STATIC PRESSURE
 - 24-HOUR PRESSURE TEST AT THE SYSTEM STATIC PRESSURE
- IRRIGATION INSTALLATION CONTRACTOR SHALL PROVIDE OWNER WITH A COLOR-CODED ZONES DIAGRAM PLAN, 8-1/2" X 11" LAMINATED SHEET(S), TO IDENTIFY CONTROL STATION TO THE CONTROL VALVE NUMBER FOR EACH CONTROLLER, TO BE LOCATED IN ADHESIVE POUCH ATTACHED INSIDE OF CONTROLLER(S).

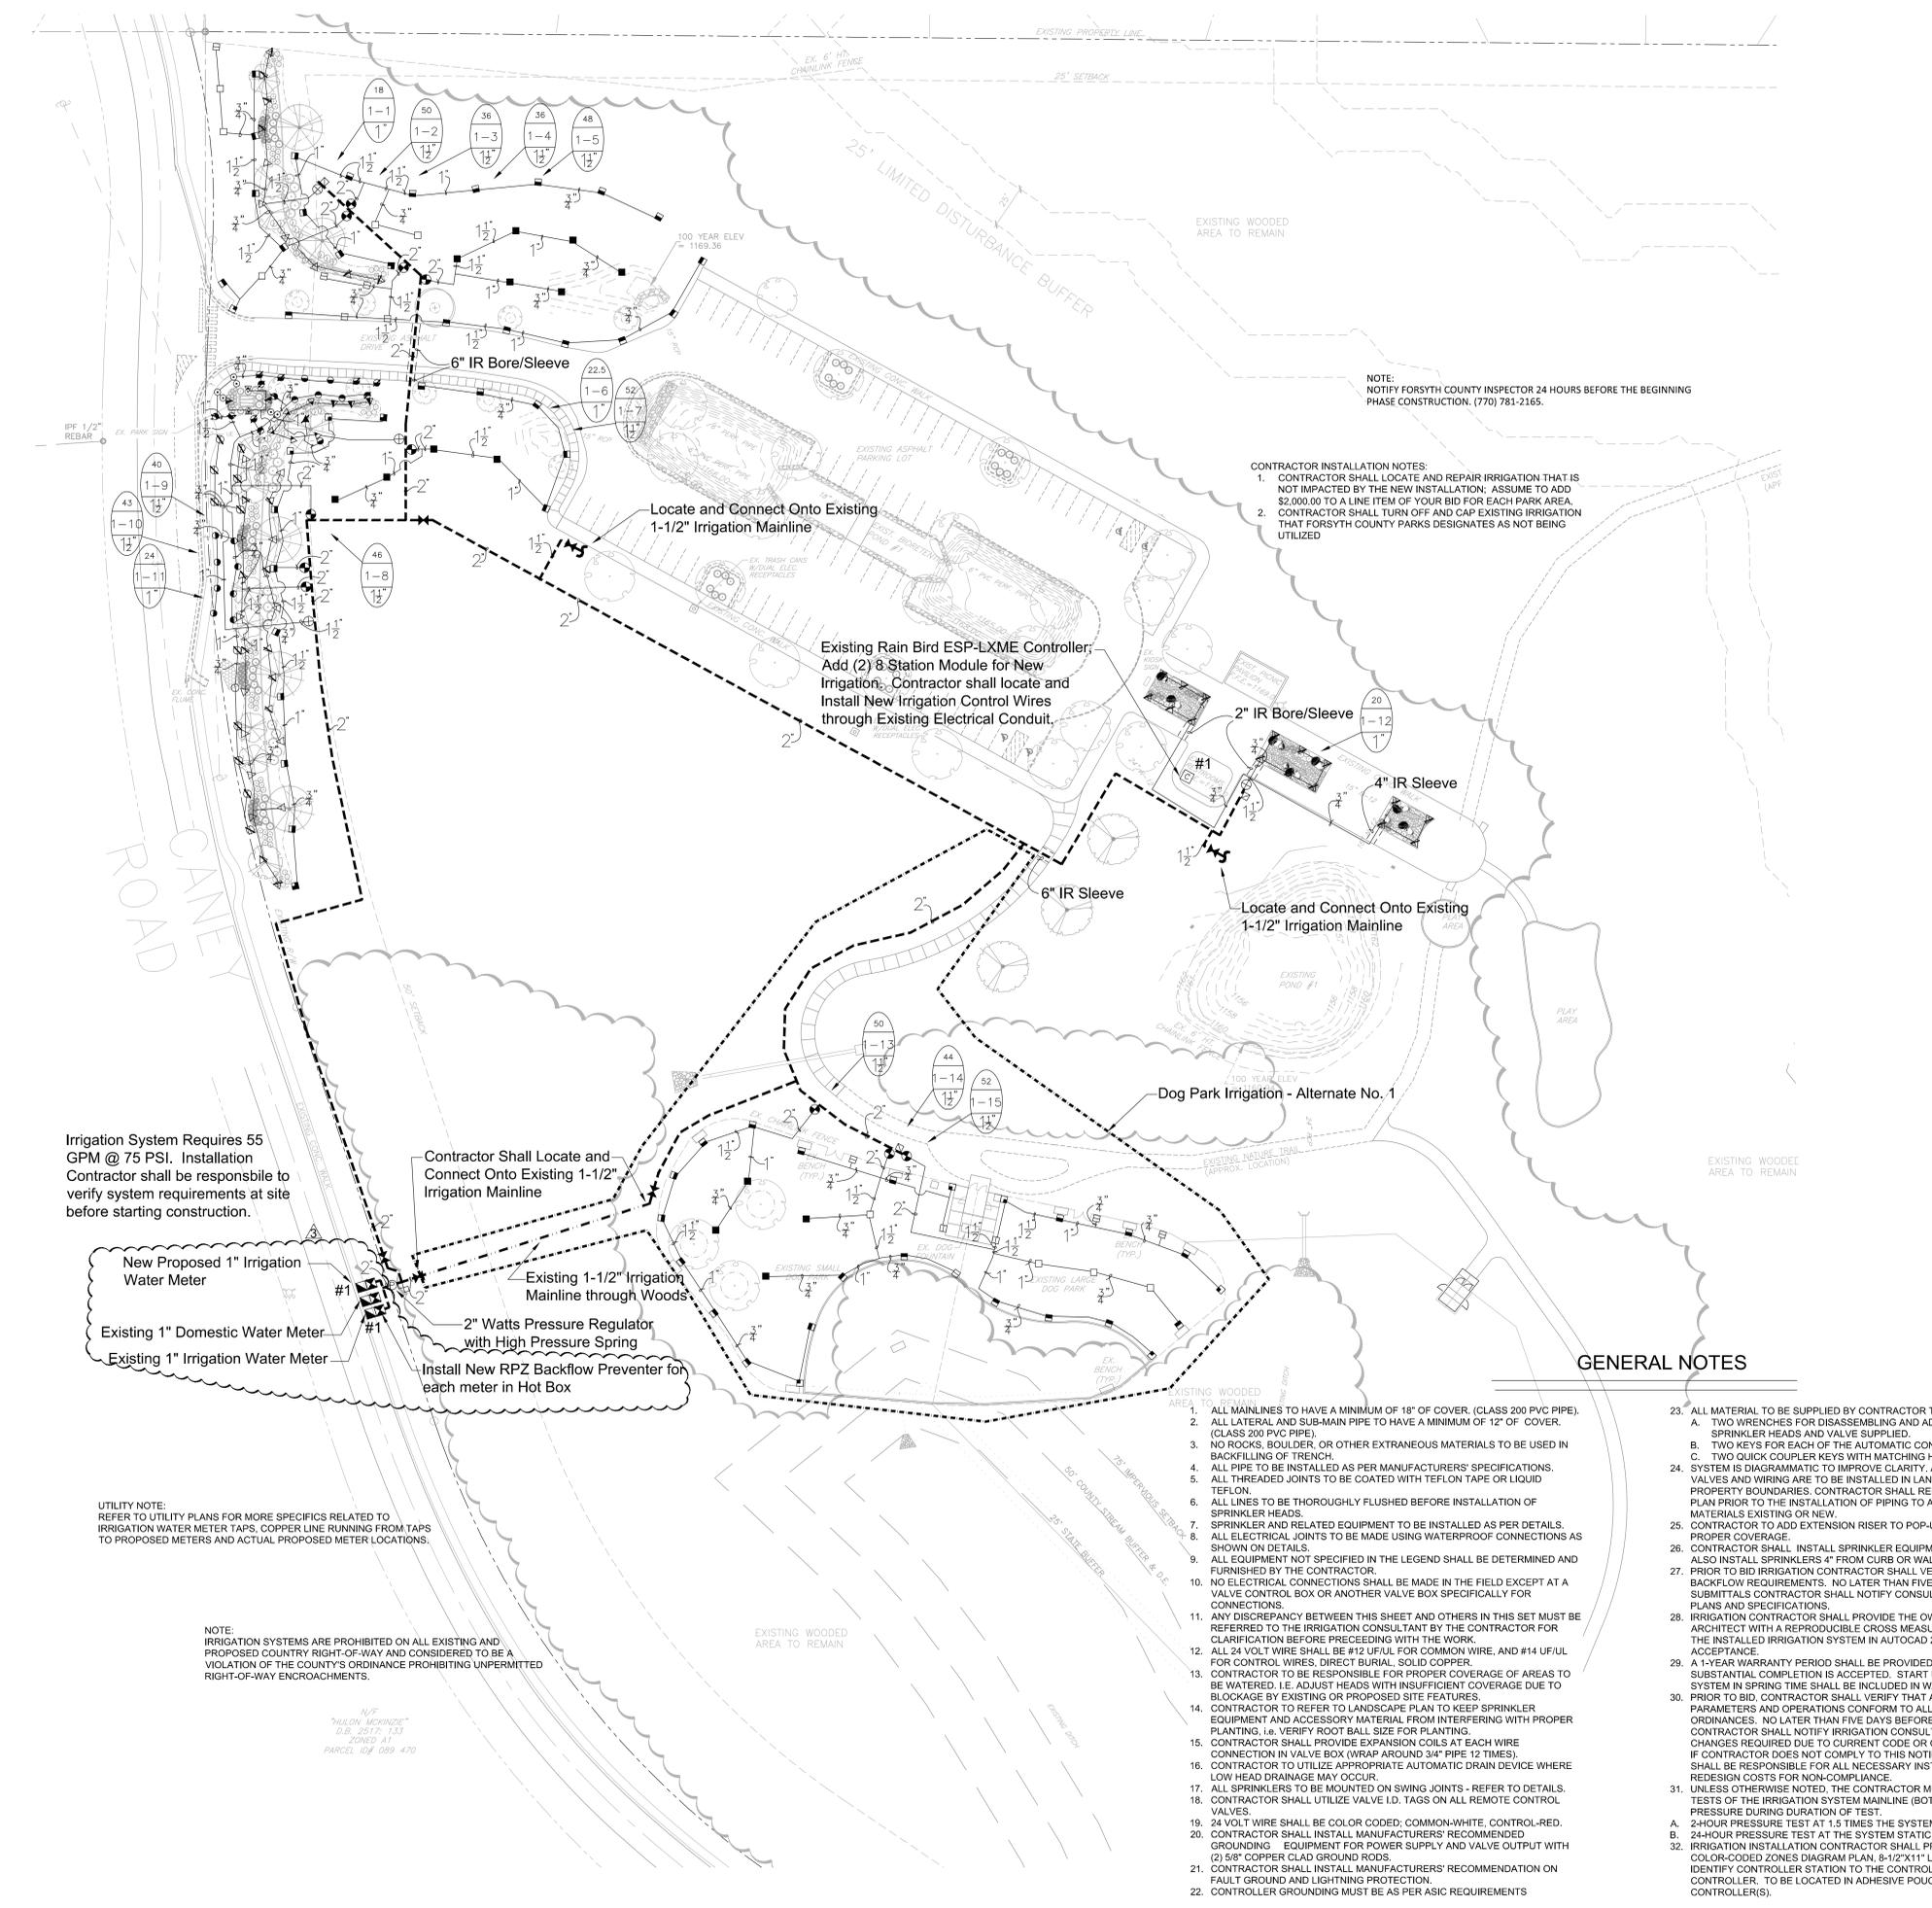

NOTE:
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CONTRACTOR INSTALLATION NOTES:
 1. CONTRACTOR SHALL LOCATE AND REPAIR IRRIGATION THAT IS NOT IMPACTED BY THE NEW INSTALLATION. ASSUME TO ADD \$2,000.00 TO A LINE ITEM OF YOUR BID FOR EACH PARK AREA.
 2. CONTRACTOR SHALL TURN OFF AND CAP EXISTING IRRIGATION THAT FORSYTH COUNTY PARKS DESIGNATES AS NOT BEING UTILIZED

Locate and Connect Onto Existing 1-1/2" Irrigation Mainline

Existing Rain Bird ESP-LXME Controller; Add (2) 8 Station Module for New Irrigation. Contractor shall locate and install New Irrigation Control Wires through Existing Electrical Conduit.

Locate and Connect Onto Existing 1-1/2" Irrigation Mainline

Contractor Shall Locate and Connect Onto Existing 1-1/2" Irrigation Mainline

Existing 1-1/2" Irrigation Mainline through Woods

2" Watts Pressure Regulator with High Pressure Spring

Install New RPZ Backflow Preventer for each meter in Hot Box

Irrigation System Requires 55 GPM @ 75 PSI. Installation Contractor shall be responsible to verify system requirements at site before starting construction.

New Proposed 1" Irrigation Water Meter

Existing 1" Domestic Water Meter

Existing 1" Irrigation Water Meter

UTILITY NOTE:
 REFER TO UTILITY PLANS FOR MORE SPECIFICS RELATED TO IRRIGATION WATER METER TAPS, COPPER LINE RUNNING FROM TAPS TO PROPOSED METERS AND ACTUAL PROPOSED METER LOCATIONS.

NOTE:
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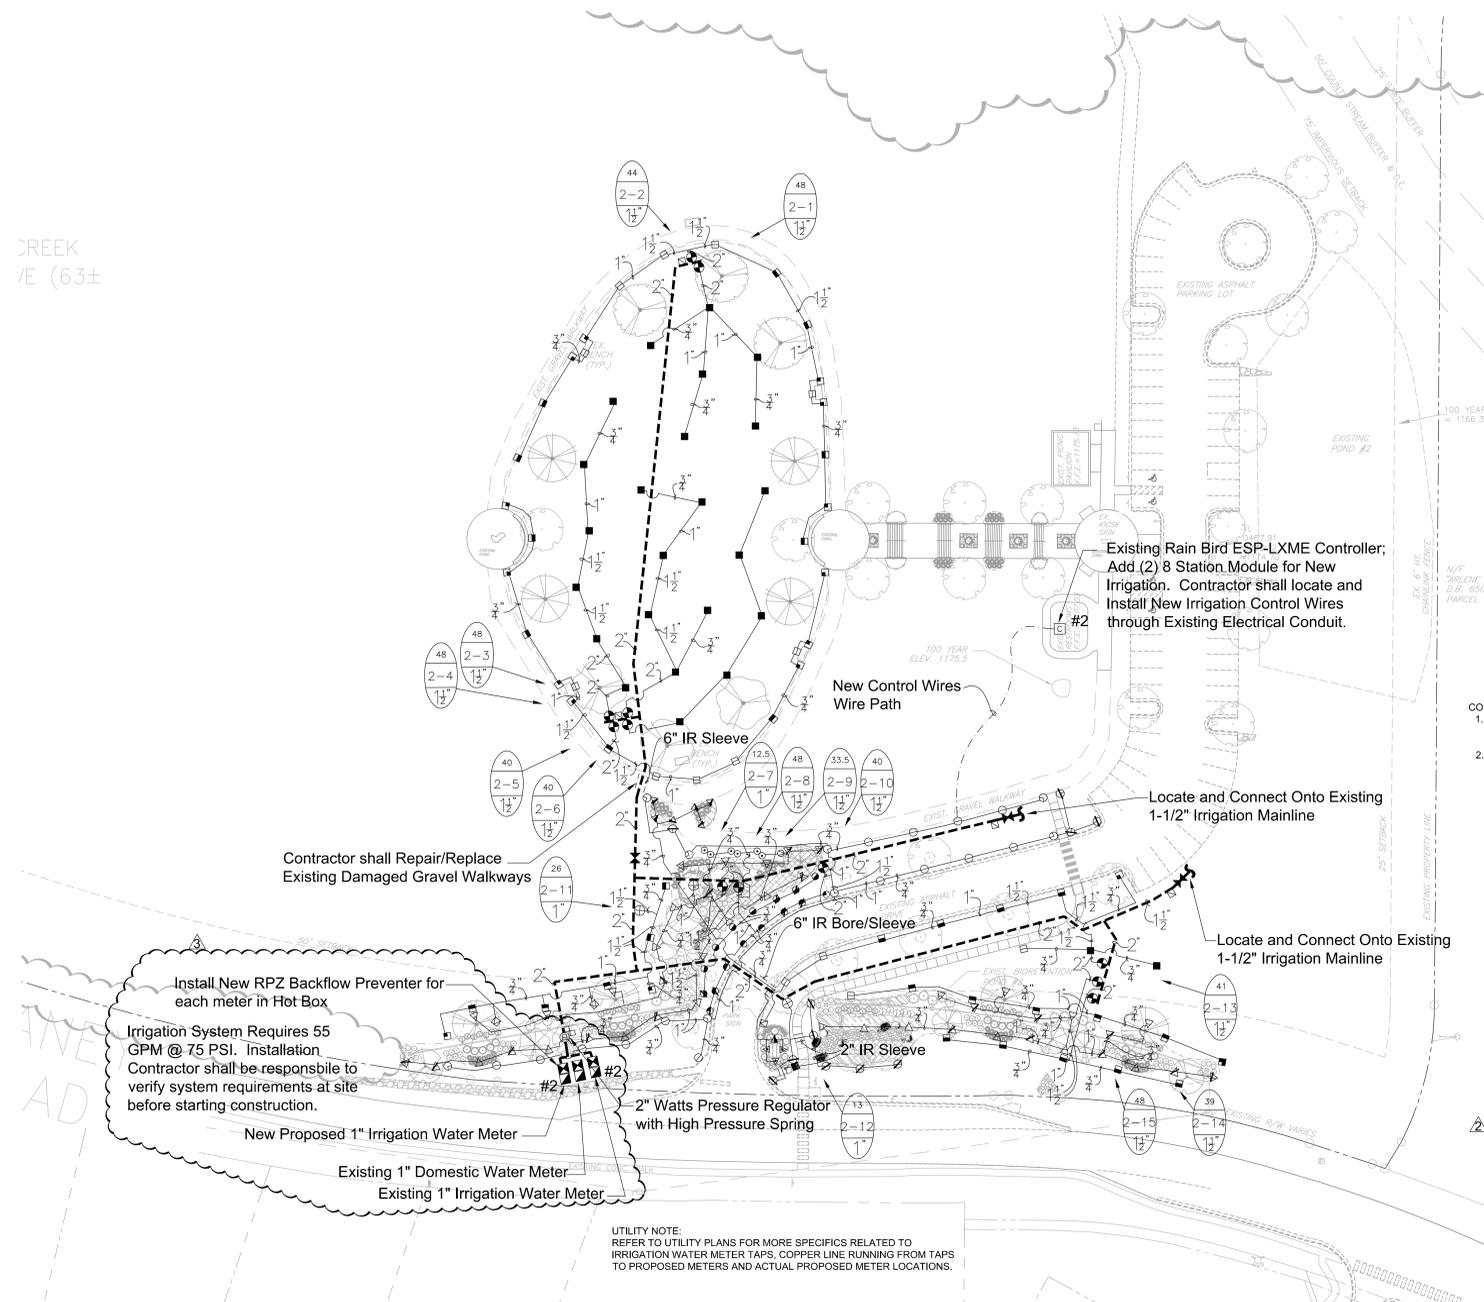
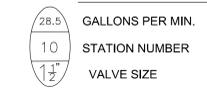
N/F "MULLEN MCKENZIE" DIVISION 1139 PARCEL 109 089 470

IRRIGATION LEGEND

- #1, #2 [Symbol] NEW PROPOSED 1" IRRIGATION WATER METER INSTALLED NEXT TO EXISTING 1" DOMESTIC WATER METER (NOT FOR IRRIGATION) AND EXISTING 1" IRRIGATION WATER METER (TO BE USED FOR IRRIGATION). EACH SYSTEM REQUIRES 55 GPM @ 75 PSI. IRRIGATION CONTRACTOR SHALL BE RESPONSIBLE TO VERIFY THE SYSTEM REQUIREMENTS AT SITE BEFORE STARTING CONSTRUCTION.
- #1a, #1b, #2a, #2b [Symbol] MANUAL DRAIN VALVE. SCH 80 PVC TRUE UNION BALL VALVE. DETAIL-E.
- #1, #2 [Symbol] WATTS #909-MT-QT-1", 1" REDUCED PRESSURE ASSEMBLY BACKFLOW PREVENTER IN HOT BOX. DETAIL-F.
- #1, #2 [Symbol] WINTERIZATION ASSEMBLY. DETAIL-M.
- #1, #2 [Symbol] EXISTING RAIN BIRD LXME CONTROLLER(S). INSTALLATION CONTRACTOR SHALL ADD (2) 8 STATION EXPANSION MODULE TO EACH CONTROLLER. INSTALLATION CONTRACTOR SHALL ENSURE THAT EACH CONTROLLER HAS A RAIN/FREEZE SENSOR.
- #1, #2 [Symbol] 2" IRRIGATION PRESSURE REDUCING VALVE, WATTS USB-Z3-HP, WITH HIGH TENSION SPRING, FOR OPERATION BETWEEN 70 AND 100 PSI. DETAIL-J.
- [Symbol] RAIN BIRD 150-PEB-PRS PLASTIC ELECTRIC REMOTE CONTROL VALVE, 1 1/2" SIZE. MOUNTED WITH SCH 80 PVC TRUE UNION BALL VALVE WITH PRESSURE REGULATION DEVICES. DETAIL-A.
- [Symbol] RAIN BIRD 100-PEB-PRS PLASTIC ELECTRIC REMOTE CONTROL VALVE, 1" SIZE. MOUNTED WITH SCH 80 PVC TRUE UNION BALL VALVE WITH PRESSURE REGULATION DEVICES. DETAIL-A.
- [Symbol] RAIN BIRD 1806-SAM, 6" POP-UP LAWN SPRAY SPRINKLER, 12' RADIUS, FULL-2.0 GPM, HALF-1.0 GPM, QUARTER-0.5 GPM, 30 PSI. DETAIL-C.
- [Symbol] RAIN BIRD 1806-SAM, 6" POP-UP LAWN SPRAY SPRINKLER, 15' RADIUS, FULL-4.0 GPM, HALF-2.0 GPM, QUARTER-1.0 GPM, 30 PSI. DETAIL-C.
- [Symbol] RAIN BIRD 1806-SAM, 6" LAWN POP-UP SIDE STRIP SPRAY SPRINKLER, 9' X 18' RADIUS, 1.5 GPM, 30 PSI. DETAIL-C.
- [Symbol] RAIN BIRD 1806-SAM, 6" LAWN SIDE STRIP SPRAY SPRINKLER, 4' X 30' RADIUS, 1.5 GPM, 30 PSI. DETAIL-C.
- [Symbol] RAIN BIRD 1806-SAM, 6" LAWN END STRIP SPRAY SPRINKLER, 4' X 15' RADIUS, 1.0 GPM, 30 PSI. DETAIL-C.
- [Symbol] RAIN BIRD 1812-SAM, 12" HI-POP SHRUB SPRAY SPRINKLER, 15' RADIUS, FULL-4.0 GPM, HALF-2.0 GPM, QUARTER-1.0 GPM, 30 PSI. DETAIL-D.
- [Symbol] RAIN BIRD 1812-SAM, 12" HI-POP SHRUB SPRAY SPRINKLER, 12' RADIUS, FULL-2.0 GPM, 30 PSI. DETAIL-D.
- [Symbol] RAIN BIRD 1812-SAM, 12" HI-POP SHRUB SIDE STRIP SPRAY SPRINKLER, 9' X 18' RADIUS, 1.5 GPM, 30 PSI. DETAIL-D.
- [Symbol] RAIN BIRD 1812-SAM, 12" HI-POP SHRUB SIDE STRIP SPRAY SPRINKLER, 4' X 30' RADIUS, 1.5 GPM, 30 PSI. DETAIL-D.
- [Symbol] RAIN BIRD 1812-SAM, 12" HI-POP SHRUB END STRIP SPRAY SPRINKLER, 4' X 15' RADIUS, 1.0 GPM, 30 PSI. DETAIL-D.
- [Symbol] RAIN BIRD 1806-SAM WITH 1404 BUBBLER NOZZLE AND PA-80 ADAPTER. 6" POP-UP TREE BUBBLER, 1.0 GPM. DETAIL-C.
- [Symbol] HUNTER I-20-06-SS LAWN ROTOR WITH STAINLESS STEEL RISERS, 40' RADIUS, FULL-8.0 GPM, HALF-4.0 GPM, QUARTER-2.0 GPM, 45 PSI. DETAIL-B.
- [Symbol] HUNTER I-20-06-SS LAWN ROTOR WITH STAINLESS STEEL RISERS, 30' RADIUS, FULL-4.0 GPM, HALF-2.0 GPM, QUARTER-1.0 GPM, 45 PSI. DETAIL-B.
- [Symbol] HUNTER INDUSTRIES MP ROTATOR SERIES 3000, MOUNTED ON RAIN BIRD 1806-SAM SPRINKLER IN LAWN, 30' RADIUS, FULL-4.0 GPM, HALF-2.0 GPM, QUARTER-1.0 GPM, 40 PSI. DETAIL-C.
- [Symbol] HUNTER INDUSTRIES MP ROTATOR SERIES 2000, MOUNTED ON RAIN BIRD 1806-SAM SPRINKLER IN LAWN, 20' RADIUS, FULL-2.0 GPM, HALF-1.0 GPM, QUARTER-0.5 GPM, 40 PSI. DETAIL-C.
- [Symbol] HUNTER INDUSTRIES MP ROTATOR SERIES 3000, MOUNTED ON RAIN BIRD 1812-SAM SPRINKLER IN BED AREAS, 30' RADIUS, FULL-4.0 GPM, HALF-2.0 GPM, QUARTER-1.0 GPM, 40 PSI. DETAIL-D.
- [Symbol] HUNTER INDUSTRIES MP ROTATOR SERIES 2000, MOUNTED ON RAIN BIRD 1812-SAM SPRINKLER IN BED AREA, 20' RADIUS, FULL-2.0 GPM, HALF-1.0 GPM, QUARTER-0.5 GPM, 40 PSI. DETAIL-D.
- [Symbol] RAIN BIRD #5 QUICK COUPLING VALVE 1" SIZE. CONTRACTOR TO SUPPLY TWO QCV KEYS AND MATCHING HOSE SWIVELS. DETAIL-K.
- [Symbol] SCH 80 PVC TRUE UNION BALL VALVE, SIZED SAME AS MAINLINE, MOUNTED IN CARSON VALVE BOX. DETAIL-L.
- MAINLINE PIPE: 2" SIZE IF NOT NOTED. CLASS 200 PVC SOLVENT WELD PIPE UTILIZING SCH 40 PVC SOLVENT WELD FITTINGS.
- IRRIGATION SLEEVE: CLASS 200 PVC, SIZE NOTED ON PLAN. DETAIL-H.
- LATERAL LINE PIPE: CLASS 200 PVC SOLVENT WELD PIPE UTILIZING SCH 40 PVC SOLVENT WELD FITTINGS, SIZE NOTED.
- 3" ELECTRICAL CONDUIT SLEEVE.

- NOTES:
- ALL SPRINKLERS WILL BE MOUNTED ON (3) MARLEX STREET ELLS WITH A SCHED. 80 NIPPLE SIZE OF SPRINKLER INLET.
 - CONTRACTOR TO UTILIZE A AUTOMATIC DRAIN CHECK VALVE DEVICE WHERE LOW HEAD DRAINAGE MAY OCCUR.
 - ALL WIRE WILL BE COLOR CODED DIRECT BURIAL ULULF WIRE: COMMON (WHITE) #12-1, CONTROL (RED) #14-1.
 - ALL PIPING AND WIRING UNDER HARDTOPS WILL BE IN CLASS 200 PVC PIPE SLEEVE.

TYPICAL VALVE INDICATOR



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 2. CONTRACTOR SHALL TURN OFF AND CAP EXISTING IRRIGATION THAT FORSYTH COUNTY PARKS DESIGNATES AS NOT BEING UTILIZED.

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GENERAL NOTES

- ALL MAINLINES TO HAVE A MINIMUM OF 18" OF COVER. (CLASS 200 PVC PIPE).
- ALL LATERAL AND SUB-MAIN PIPE TO HAVE A MINIMUM OF 12" OF COVER. (CLASS 200 PVC PIPE).
- NO ROCKS, BOULDER, OR OTHER EXTRANEOUS MATERIALS TO BE USED IN BACKFILLING OF TRENCH.
- ALL PIPE TO BE INSTALLED AS PER MANUFACTURERS' SPECIFICATIONS.
- ALL THREADED JOINTS TO BE COATED WITH TEFLON TAPE OR LIQUID TEFLON.
- ALL LINES TO BE THOROUGHLY FLUSHED BEFORE INSTALLATION OF SPRINKLER HEADS.
- SPRINKLER AND RELATED EQUIPMENT TO BE INSTALLED AS PER DETAILS.
- ALL ELECTRICAL JOINTS TO BE MADE USING WATERPROOF CONNECTIONS AS SHOWN ON DETAILS.
- ALL EQUIPMENT NOT SPECIFIED IN THE LEGEND SHALL BE DETERMINED AND FURNISHED BY THE CONTRACTOR.
- NO ELECTRICAL CONNECTIONS SHALL BE MADE IN THE FIELD EXCEPT AT A VALVE CONTROL BOX OR ANOTHER VALVE BOX SPECIFICALLY FOR CONNECTIONS.
- ANY DISCREPANCY BETWEEN THIS SHEET AND OTHERS IN THIS SET MUST BE REFERRED TO THE IRRIGATION CONSULTANT BY THE CONTRACTOR FOR CLARIFICATION BEFORE PRECEEDING WITH THE WORK.
- ALL 24 VOLT WIRE SHALL BE #12 UFIL FOR COMMON WIRE, AND #14 UFIL FOR CONTROL WIRES, DIRECT BURIAL, SOLID COPPER.
- CONTRACTOR TO BE RESPONSIBLE FOR PROPER COVERAGE OF AREAS TO BE WATERED. I.E. ADJUST HEADS WITH INSUFFICIENT COVERAGE DUE TO BLOCKAGE BY EXISTING OR PROPOSED SITE FEATURES.
- CONTRACTOR TO REFER TO LANDSCAPE PLAN TO KEEP SPRINKLER EQUIPMENT AND ACCESSORY MATERIAL FROM INTERFERING WITH PROPER PLANTING. I.E. VERIFY ROOT BALL SIZE FOR PLANTING.
- CONTRACTOR SHALL PROVIDE EXPANSION COILS AT EACH WIRE CONNECTION IN VALVE BOX (WRAP AROUND 3/4" PIPE 12 TIMES).
- CONTRACTOR TO UTILIZE APPROPRIATE AUTOMATIC DRAIN DEVICE WHERE LOW HEAD DRAINAGE MAY OCCUR.
- ALL SPRINKLERS TO BE MOUNTED ON SWING JOINTS - REFER TO DETAILS.
- CONTRACTOR SHALL UTILIZE VALVE I.D. TAGS ON ALL REMOTE CONTROL VALVES.
- 24 VOLT WIRE SHALL BE COLOR CODED: COMMON-WHITE, CONTROL-RED.
- CONTRACTOR SHALL INSTALL MANUFACTURERS' RECOMMENDED GROUNDING EQUIPMENT FOR POWER SUPPLY AND VALVE OUTPUT WITH (2) 5/8" COPPER CLAD GROUND RODS.
- CONTRACTOR SHALL INSTALL MANUFACTURERS' RECOMMENDATION ON FAULT GROUND AND LIGHTNING PROTECTION.
- CONTRACTOR GROUNDING MUST BE AS PER ASIC REQUIREMENTS
- ALL MATERIAL TO BE SUPPLIED BY CONTRACTOR TO OWNER:
 A. TWO WRENCHES FOR DISASSEMBLING AND ADJUSTING EACH TYPE OF SPRINKLER HEADS AND VALVE SUPPLIED.
 B. TWO KEYS FOR EACH OF THE AUTOMATIC CONTROLLERS.
 C. TWO QUICK COUPLER KEYS WITH MATCHING HOSE SWIVELS.
- SYSTEM IS DIAGRAMMATIC TO IMPROVE CLARITY. ALL MAINLINE PIPING ELECTRIC VALVES AND WIRING ARE TO BE INSTALLED IN LANDSCAPE AREAS AND WITHIN PROPERTY BOUNDARIES. CONTRACTOR SHALL REFERENCE THE LANDSCAPE PLAN PRIOR TO THE INSTALLATION OF PIPING TO AVOID CONTACT WITH PLANT MATERIALS EXISTING OR NEW.
- CONTRACTOR TO ADD EXTENSION RISER TO POP-UP HEADS WHEN NEEDED FOR PROPER COVERAGE.
- CONTRACTOR SHALL INSTALL SPRINKLER EQUIPMENT 12" FROM FOUNDATIONS. ALSO INSTALL SPRINKLERS 4" FROM CURB OR WALKS.
- PRIOR TO BID IRRIGATION CONTRACTOR SHALL VERIFY RIGHT-OF-WAY AND PROPERTY BOUNDARIES. NO LATER THAN FIVE DAYS BEFORE BID SUBMITTALS CONTRACTOR SHALL NOTIFY CONSULTANT OF ANY CHANGES FROM PLANS AND SPECIFICATIONS.
- IRRIGATION CONTRACTOR SHALL PROVIDE THE OWNER AND LANDSCAPE ARCHITECT WITH A REPRODUCIBLE GROSS MEASURED AS-BUILT DRAWING OF THE INSTALLED IRRIGATION SYSTEM IN AUTOCAD 2017 FORMAT BEFORE FINAL ACCEPTANCE.
- A 1-YEAR WARRANTY PERIOD SHALL BE PROVIDED FOR SYSTEM AFTER SUBSTANTIAL COMPLETION IS ACCEPTED. START UP AND ADJUSTING OF SYSTEM IN SPRING TIME SHALL BE INCLUDED IN WARRANTY.
- PRIOR TO BID, CONTRACTOR SHALL VERIFY THAT ALL MATERIALS, INSTALLATION PARAMETERS AND OPERATIONS CONFORM TO ALL APPLICABLE CODES AND ORDINANCES. NO LATER THAN FIVE DAYS BEFORE BID SUBMITTALS CONTRACTOR SHALL NOTIFY IRRIGATION CONSULTANT/DESIGNER OF ANY CHANGES REQUIRED DUE TO CURRENT CODE OR ORDINANCE DISCREPANCIES. IF CONTRACTOR DOES NOT COMPLY TO THIS NOTIFICATION, THE CONTRACTOR SHALL BE RESPONSIBLE FOR ALL NECESSARY INSTALLATION CHANGE AND REDESIGN COSTS FOR NON-COMPLIANCE.
- UNLESS OTHERWISE NOTED, THE CONTRACTOR MUST COMPLETE 2 PRESSURE TESTS OF THE IRRIGATION SYSTEM MAINLINE (BOTH TO SHOW NO DROP IN PRESSURE DURING DURATION OF TEST.
 A. 2-HOUR PRESSURE TEST AT 1.5 TIMES THE SYSTEM STATIC PRESSURE
 B. 24-HOUR PRESSURE TEST AT THE SYSTEM STATIC PRESSURE
- IRRIGATION INSTALLATION CONTRACTOR SHALL PROVIDE OWNER WITH A COLOR-CODED ZONES DIAGRAM PLAN, 8-1/2"x11" LAMINATED SHEET(S), TO IDENTIFY CONTROLLER STATION TO THE CONTROL VALVE NUMBER FOR EACH CONTROLLER. TO BE LOCATED IN ADHESIVE POUCH ATTACHED INSIDE OF CONTROLLER(S).

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CREEK
 /E (63±)

