
### FORSYTH COUNTY INSPECTORS/RECYCLE RENOVATION

### PERMIT SET

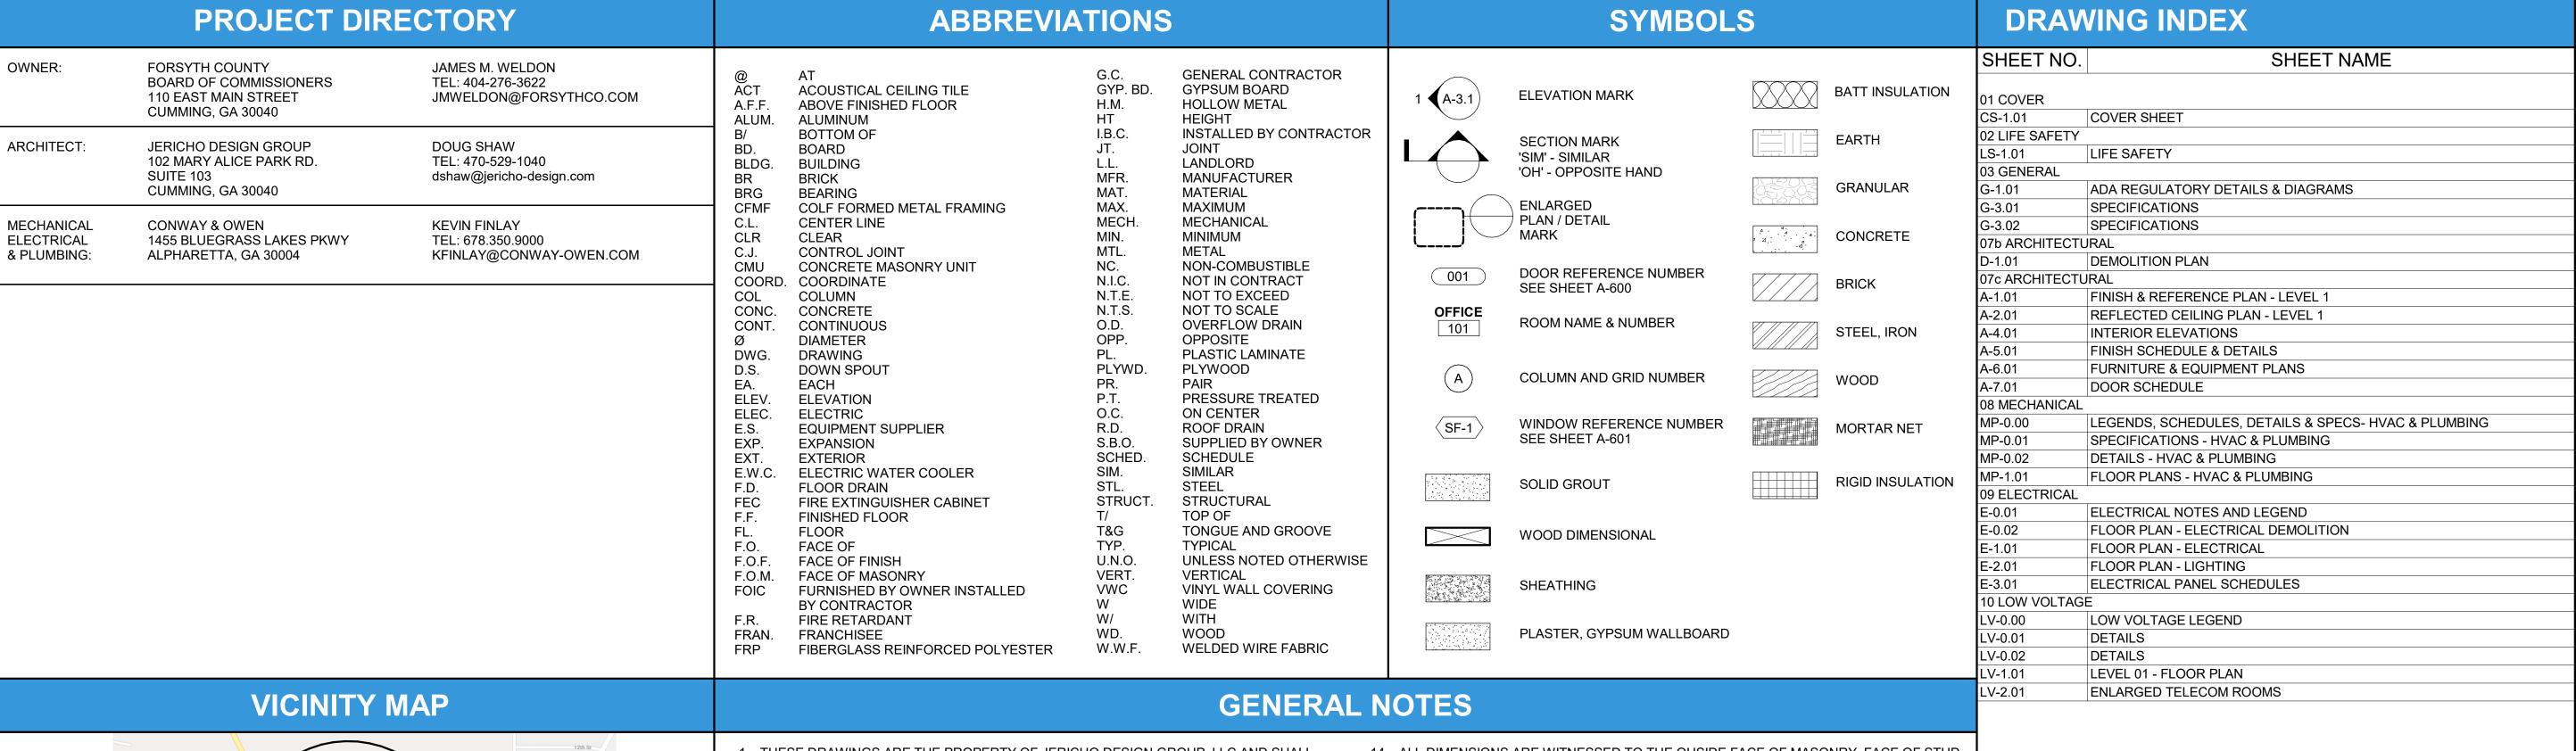

102 Mary Alice Park Road, Suite 103 Cumming, GA 30040

PRINT RECORD			
No.	DATE	DESCRIPTION	
	04/02/2020	PERMIT SET	

Drawn By Checked By

Date Job No.

**Sheet Title** 

**COVER SHEET** 

Sheet No.

Otwell Middle School NORTH

**KEY PLAN** 

 THESE DRAWINGS ARE THE PROPERTY OF JERICHO DESIGN GROUP, LLC AND SHALL NOT BE REPRODUCED OR COPIED (PHYSICALLY AND/OR DIGITALLY) IN PART OF WHOLE. THEY ARE TO BE USED FOR THIS PROJECT ONLY AND ARE NOT TO BE USED ON ANY OTHER

2. DRAWINGS AND SPECIFICATIONS ARE INTENDED TO AGREE AND BE MUTUALLY EXPLANATORY. THEY SHALL BE ACCEPTED/USED AS A WHOLE; NOT SEPARATELY. SHOULD ANY ITEMS BE OMITTED FROM THE DRAWINGS AND BE HEREIN SPECIFIED. OR VICE VERSA. IT SHALL BE EXECUTED THE SAME AS IF SHOWN AND COMBINED IN BOTH. IT IS THE RESPONSIBILITY OF THE CONTRACTOR TO SUPPLY ENTIRE SET TO EACH

3. THE CONTRACTOR IS TO NOTIFY ARCHITECT OF ANY DISCREPANCIES AFTER FULL REVIEW OF CONTRACT DOCUMENTS TO INCLUDE BUT NOT LIMITED TO ERRORS, OMISSIONS, INCONSISTENCIES, DISCREPANCIES, AND CONFLICTS WITH THE DRAWINGS/SPECIFICATIONS OR AS RELATED TO FIELD CONDITIONS. CONTRACTOR TO CONTACT ARCHITECT IMMEDIATELY TO DISCUSS A RESOLUTION.

4. DO NOT SCALE THE DRAWINGS UNDER ANY CONDITION. WORK PERFORMED SHALL BE IN ACCORDANCE TO ALL FEDERAL, STATE AND LOCAL BUILDING CODE REQUIREMENTS PER INDUSTRY STANDARDS. ALL REQUIRED PERMITS AND FEES ASSOCIATED ARE TO BE THE RESPONSIBILITY OF THE CONTRACTOR NECESSARY FOR START AND COMPLETION OF THE PROJECT. COPIES OF INSPECTIONS AND PERMITS SHALL BE FURNISHED TO OWNER AT REQUEST AND/OR AT PROJECT CLOSEOUT. 6. CONTRACTOR TO TAKE PRECAUTIONS IN PROTECTING THE WORK DURING CONSTRUCTION. ANY DAMAGE TO BE RESTORED TO ORIGINAL CONSTRUCTION BY THE CONTRACTOR. PATCH AND REPAIR ALL ITEMS DAMAGED OR ALTERED DURING CONSTRUCTION BY THE CONTRACTOR. ALL PATCHES SHALL BLEND WITH ADJACENT MATERIAL, COLOR, FINISH, AND TEXTURE. ALL EXISTING WORK FURNISHINGS, EQUIPMENT OR MATERIAL TO REMAIN THAT ARE DAMAGED BY THE CONTRACTOR'S OPERATION SHALL

BE REPAIRED BY THE CONTRACTOR AT NO ADDITIONAL COST TO THE OWNER. 7. REQUESTS FOR SUBSTITUTIONS MUST BE SUBMITTED IN WRITING TO THE ARCHITECT FOR CONSIDERATION ONLY IF IMPACT TO SCHEDULE, COST CHANGE OR QUALITY OF PRODUCT. ACCEPTANCE BY ARCHITECT DOES NOT IDENTIFY PRODUCT TO BE OF BETTER QUALITY THAN SPECIFIED PRODUCT.

8. SEAL ALL EXTERIOR PENETRATIONS AND VOIDS ON EXTERIOR BUILDING ENVELOPE. 9. FIELD VERIFY ALL EXISTING CONDITIONS PRIOR TO COMMENCEMENT OF ANY CONSTRUCTION ACTIVITIES. NOTIFY THE ARCHITECT OF ANY DISCREPANCIES BETWEEN FIELD CONDTITION/S AND CONTRACT DOCUMENTS PRIOR TO ANY CONSTRUCTION ACTIVITY IN AREA OF CONCERN.

10. THE LOCATION OF THE EXISTING UTILITIES & STRUCTURES SHOWN HEREIN ARE APPROXIMATE. IT SHALL BE THE RESPONSIBILITY OF THE CONTRACTOR TO VERIFY THE EXISTENCE & ACTUAL LOCATIONS OF ALL, SHOWN OR NOT SHOWN. ANY DAMAGES RESULTING BY CONTRACTORS' ACTIVITIES SHALL BE REPAIRED AT THE EXPENSE OF THE

11. THE CONTRACTOR SHALL PROVIDE ADEQUATE BRACING & SHORING FOR ALL WORK DURING THE CONSTRUCTION PERIOD.

12. PROVIDE SEPARATION BETWEEN ALL DISSIMILAR METALS INCLUDING SCREWS, NAILS & OTHER FASTENING DEVICES TO AVOID GALVANIC CORROSION. 13. PROVIDE EXPANSION AND CONTROL JOINTS IN ALL WORK AS PER PRODUCT MANUFACTURER'S STANDARDS, OR SPECIFICATIONS, UNLESS NOTED OTHERWISE.

14. ALL DIMENSIONS ARE WITNESSED TO THE OUSIDE FACE OF MASONRY, FACE OF STUD, CENTER OF COLUMN. TOP OF STRUCTURAL CONCERETE SLAB OR ROUGH WINDOW

OPENING UNLESS NOTED OTHERWISE 15. NOTES APPEAR ON VARIOUS SHEETS FOR DIFFERENT SYSTEMS AND MATERIALS. SHEETS ARE TO BE REVIEWED AND NOTES ON INDIVIDUAL SHEETS SHALL BE APPLIED TO RELATED DRAWINGS AND DETAILS.

16. INTERIOR PARTITION MOVEMENT CONTROL - VERTICAL CONTROL JOINTS FOR ANY WALL LENGTH ARE TO OCCUR AT NOT MORE THAN 30'-0" O.C. IN THE HORIZONTAL

DIRECTION, UNLESS NOTED OTHERWISE. 17. THE CONTRACTOR IS RESPONSIBLE FOR THE COORDINATION OF ALL PARTS OF THE WORK SO THAT NO WORK SHALL BE LEFT IN AN UNFINISHED OR INCOMPLETE CONDITION. 18. THE PROJECT AND ALL INTERIOR SPACES SHALL BE COMPLETELY OPERATIONAL UPON TURNOVER OF SPACE, THESE ARE TO INCLUDE SYSTEMS NOT LIMITED TO ARCHITECTURAL, INTERIORS, STRUCTURAL, CIVIL, MECHANICAL, ELECTRICAL, PLUMBING,

AND FIRE PROTECTION SYSTEMS. 19. IT IS THE CONTRACTOR'S RESPONSIBILITY TO COORDINATE LOCATIONS AND/OR ELEVATIONS OF FLOOR DRAINS, REGISTERS, GRILLES, LOUVERS, DUCTS, UNIT HEATERS, PANELS, ETC. WITH STRUCTURAL MECHANICAL AND ELECTRICAL CONTRACTORS. 20. BOLTING OF WOOD TO STRUCTURAL MEMBERS SHALL BE WITH A MINIMUM OF 1/2" BOLTS X 4'-0" O.C. UNLESS NOTED OTHERWISE ON CONSTRUCTION DOCUMENTS AND/OR

21. CONTRACTOR SHALL COMPLY WITH STATE BUILDING CODES IN FIRESTOPPING ALL FLOOR PENETRATIONS.

22. METAL STUDS AND HANGER WIRE ARE NOT TO BE ATTACHED DIRECTLY TO FLOOR/CEILING MTL DECKING. ATTACH TO STRUCTURAL STEEL, BAR JOIST, MISCELLANEOUS STEEL OR CONCRETE STRUCTURE ONLY. IF THE TOP TRACK OF THE METAL STUDS AND HANGER WIRE MUST BE CONNECTED TO METAL DECK, SEE STRUCTURAL NOTES FOR ATTACHMENT CRITERIA.

23. GENERAL: ALL WOOD FRAMING/BLOCKING IN TYPE II CONSTRUCTION SHALL BE FIRE RETARDANT TREATED WOOD IN ACCORDANCE WITH 2012 IBC SECTION 603. 24. IF EVIDENCE SUGGESTS THE PRESENCE OF MOLD ON, BEHIND OR WITHIN SURFACES OR MATERIALS (I.E., INCLUDING, BUT NOT LIMITED TO EXISTING GYPSUM BOARD, EXISTING FLOOR FINISHES AND/OR EXISTING CEILING TILE), IT IS THE RESPONSIBILITY OF THE CONTRACTOR TO IDENTIFY AREA, REMOVE PORTION OF MATERIAL WITH MOLD AND PATCH/REPAIR TO LIKE NEW CONDITION.

25. ANY ALTERATION OR ANY INSTALLATION OF EQUIPMENT SHALL MEET AS NEARLY AS PRACTICABLE THE REQUIREMENTS FOR NEW CONSTRUCTION IN ACCORDANCE WITH NFPA

26. ALL DEMOLITION WORK SHALL COMPLY WITH THE REQUIREMENT OF NFPA 241, STANDARD FOR SAFEGUARDING CONSTRUCTION, ALTERATION, AND DEMOLITION OPERATIONS, 2012 EDITION.

### **ALTERNATE ADD SCHEDULE**

SCHEDULE OF ALTERNATE ADDTIONS

LTERNATE DEDUCT #1 - PRICE TO SUBSTITUTE NEW MILLWORK UPPER CABINETS WITH STOCK CABINETS 36"HX36W PAINTED PT-2

ALTERNATE ADD #1 - PRICE TO REMOVE EXISTING BREAKROOM COUNTERTOP AND CABINETS AND REPLACE WITH NEW PER ELEVATION

ALTERNATE ADD #2 - PRICE TO REMOVE EXISTING CARPET AND REPLACE WITH LVP-1

ALTERNATE ADD #3 - PRICE TO REMOVE EXISTING CEILING TILES AND LIGHTING AND REPLACE WITH NEW 2X2 ACT-1 AND NEW 2X2 LED LIGHTS

### LIFE SAFETY PLAN LEGEND

□ NON-RATED PARTITION

### **EXTINGUISHER LOCATION PER NFPA 10**

FIRE EXTINGUISHER IN RECESSED CABINET

### ● FE BRACKET MOUNTED FIRE EXTINGUISHER

**CAPACITY PER LSC 7.3.3.1** 

STAIRS = 0.3"/PERSON DOORS = 0.2"/PERSON 32"W DOOR = 30" CLR. = 150 CAPACITY 36"W DOOR = 34" CLR. = 170 CAPACITY

42"W DOOR = 40" CLR. = 200 CAPACITY 48"W DOOR = 46" CLR. = 230 CAPACITY 68"W DOOR = 64" CLR. = 320 CAPACITY 72"W DOOR = 68" CLR. = 340 CAPACITY

**DOORS PER IBC 715.4** 

### **SEPARATION PER IBC CHAPTER 5**

OCCUPANCY PER LSC 7.3.1.2 PER GEORGIA AMENDMENTS TO THE IBC AREA SF / OCCUPANT LOAD FACTOR = OCCUPANCY COUNT (REFER TO PLANS FOR ROOM OCCUPANCY CALCULATIONS)

### **EXIT SIGNS PER IBC 1011**

EXIT SIGNAGE (SHADING INDICATES FACE OF SIGN: ARROW SHOWN INDICATES DIRECTION)

### **ALLOWABLE DISTANCE PER LSC 12.2.6**

TRAVEL DISTANCE LIMIT - MAX. 200 FT. SPRINKLERED

COMMON PATH LIMIT - MAX. 75 FT. SPRINKLERED

DEAD END LIMIT - MAX.25 FT. SPRINKLERED

PATH OF EGRESS WITHIN BUILDING

TRAVEL DISTANCE & COMMON PATH (SEE NOTES ON PLANS)

NUMBER OF EXITS PER IBC 1015 & LSC 7.4.1.2

(00) ACTUAL EGRESS COUNT

(00) EGRESS CAPACITY OF EXIT

102 Mary Alice Park Road, Suite 103 Cumming, GA 30040



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No.	DATE	DESCRIPTION	
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Job No.

**Sheet Title** 

**LIFE SAFETY** 


Sheet No.


RELEASED FOR CONSTRUCTION

### **GENERAL PARTITION NOTES**

- 1. STUD DESIGN CRITERIA: ALL INTERIOR, NON-LOAD BEARING METAL STUDS SHALL BE 20 GAUGE (MIN.) UNLESS OTHERWISE NOTED. PROVIDE 5 PSF MIN. APPLIED LATERAL LOAD, L/240 MAX. DEFLECTION.
- 2. ALL FIRE RATED PARTITIONS MUST EXTEND AND SEAL TO STRUCTURE ABOVE
- 3. INSTALLATION OF GYPSUM BOARD, BACKER BOARD AND BASE BOARD SHALL CONFORM TO REQUIREMENTS FOR FIRE RATINGS AND ACOUSTICAL RATINGS
- 4. PROVIDE WATER RESISTANT TYPE GYPSUM BOARD AT AREAS THAT ARE NOTED IN ROOM FINISH SCHEDULE TO RECEIVE CERAMIC OR PORCELAIN TILE FINISH INCLUDING RESTROOMS.
- 5. PROVIDE 5/8" GYPSUM BOARD UNLESS OTHERWISE NOTED.
- 6. PROVIDE 5/8" TYPE X GYPSUM BOARD AT FIRE RATED PARTITIONS. 7. METAL STUD GAUGE (IF NOTED) AND UL TEST NUMBERS WILL VARY DEPENDING ON THE MANUFACTURER OF COMPONENTS
- 8. PENETRATIONS IN RATED PARTITIONS AND CONNECTIONS OF THE PARTITIONS TO OTHER PORTIONS OF THE WORK SHALL BE IN ACCORDANCE WITH MANUFACTURER'S RECOMMENDED DETAILS AND IN COMPLIANCE WITH APPLICABLE TESTING
- AGENCY REQUIREMENTS. 9. INSTALL BLOCKING OR BACKER MATERIAL FOR ATTACHMENT / MOUNTING OF WALL HUNG ITEMS, ACCESSORIES, FIXTURES, FURNITURE OR EQUIPMENT DESCRIBED IN THE DOCUMENTS. PROVIDE BLOCKING TO MATCH THE OVERALL HEIGHT AND WIDT
- OF ALL WALL MOUNTED MONITORS AND TVS. 10. WHEN INSTALLING GYPSUM BOARD, CONTRACTOR SHALL COMPLY WITH REQUIREMENTS OF THE MOST CURRENT EDITION
- OF THE GYPSUM ASSOCIATION "GA-600" FIRE RESISTANCE DESIGN MANUAL AND THE MOST CURRENT EDITION OF THE UL FIRE RESISTANCE DIRECTORY.
- 11. PARTITIONS THAT ARE REQUIRED TO EXTEND TO THE DECK ABOVE SHALL HAVE THE GYPSUM BOARD CUT TO FIT WITHIN A 1/4" MAXIMUM TOLERANCE TO THE SHAPE OF THE DECK ABOVE. GYPSUM BOARD SHALL BE CONTINUOUSLY SEALED FOR THE
- FULL DEPTH OF THE GYPSUM BOARD WITH FLEXIBLE SEALANT. 12. GYPSUM BOARD SHALL BE CUT SO THAT THE CLEARANCE BETWEEN METALLIC ELECTRICAL OUTLET BOXES AND THE
- GYPSUM BOARD DOES NOT EXCEED 1/8". 13. THE BOTTOM OF THE GYPSUM BOARD AT INTERIOR PARTITIONS SHALL BE 1/4" MINIMUM AND 1/2" MAXIMUM ABOVE THE CONCRETE FLOOR SLAB AND SHALL BE SEALED FOR THE FULL DEPTH OF THE GYPSUM BOARD WITH FLEXIBLE SEALANT.
- 14. REFER TO THE LIFE SAFETY FLOOR PLANS FOR EXTENT OF FIRE WALL RATINGS. 15. ALL ELEMENTS OF ACOUSTIC RATED PARTITIONS SHALL EXTEND TO ROOF STRUCTURE OR FLOOR DECK ABOVE.
- 16. PARTITION TYPES DESCRIBE GENERAL REQUIREMENTS FOR PARTITIONS. REFER TO THE MANUFACTURER'S SPECIFICATIONS AND REQUIREMENTS OF APPLICABLE TESTING AGENCIES FOR SPECIFICS OF PARTITION CONSTRUCTION. 17. WHERE A CLEAR DIMENSION OR OPENING IS REQUIRED OR NOTED, MEASURE DIMENSION TO FACE OF PARTITION FINISH.
- 19. ALL FIRE AND/OR SMOKE BARRIERS OR WALLS SHALL BE EFFECTIVELY AND PERMANENTLY IDENTIFIED WITH SIGNS OR STENCILING ABOVE A DECORATIVE CEILING AND OR IN CONCEALED SPACES WITH LETTERS A MINIMUM OF TWO (2) INCHES HIGH ON A CONTRASTING BACKGROUND SPACED A MAXIMUM OF TWELVE (12) FEET ON CENTER WITH A MINIMUM OF ONE PER WALL OR BARRIER IN ACCORDANCE WITH MODIFICATIONS OF THE 2006 STANDARD FIRE PREVENTION CODE, 120-3-3, CHAPTER 5 OF THE RULES AND REGULATIONS OF THE FIRE SAFETY COMMISSIONER. THE HOURLY RATING SHALL BE INCLUDED ON ALL

RATED BARRIERS AND WALLS. SUGGESTED WORDING '(--) HOUR FIRE AND SMOKE BARRIER - PROTECT ALL OPENINGS'.

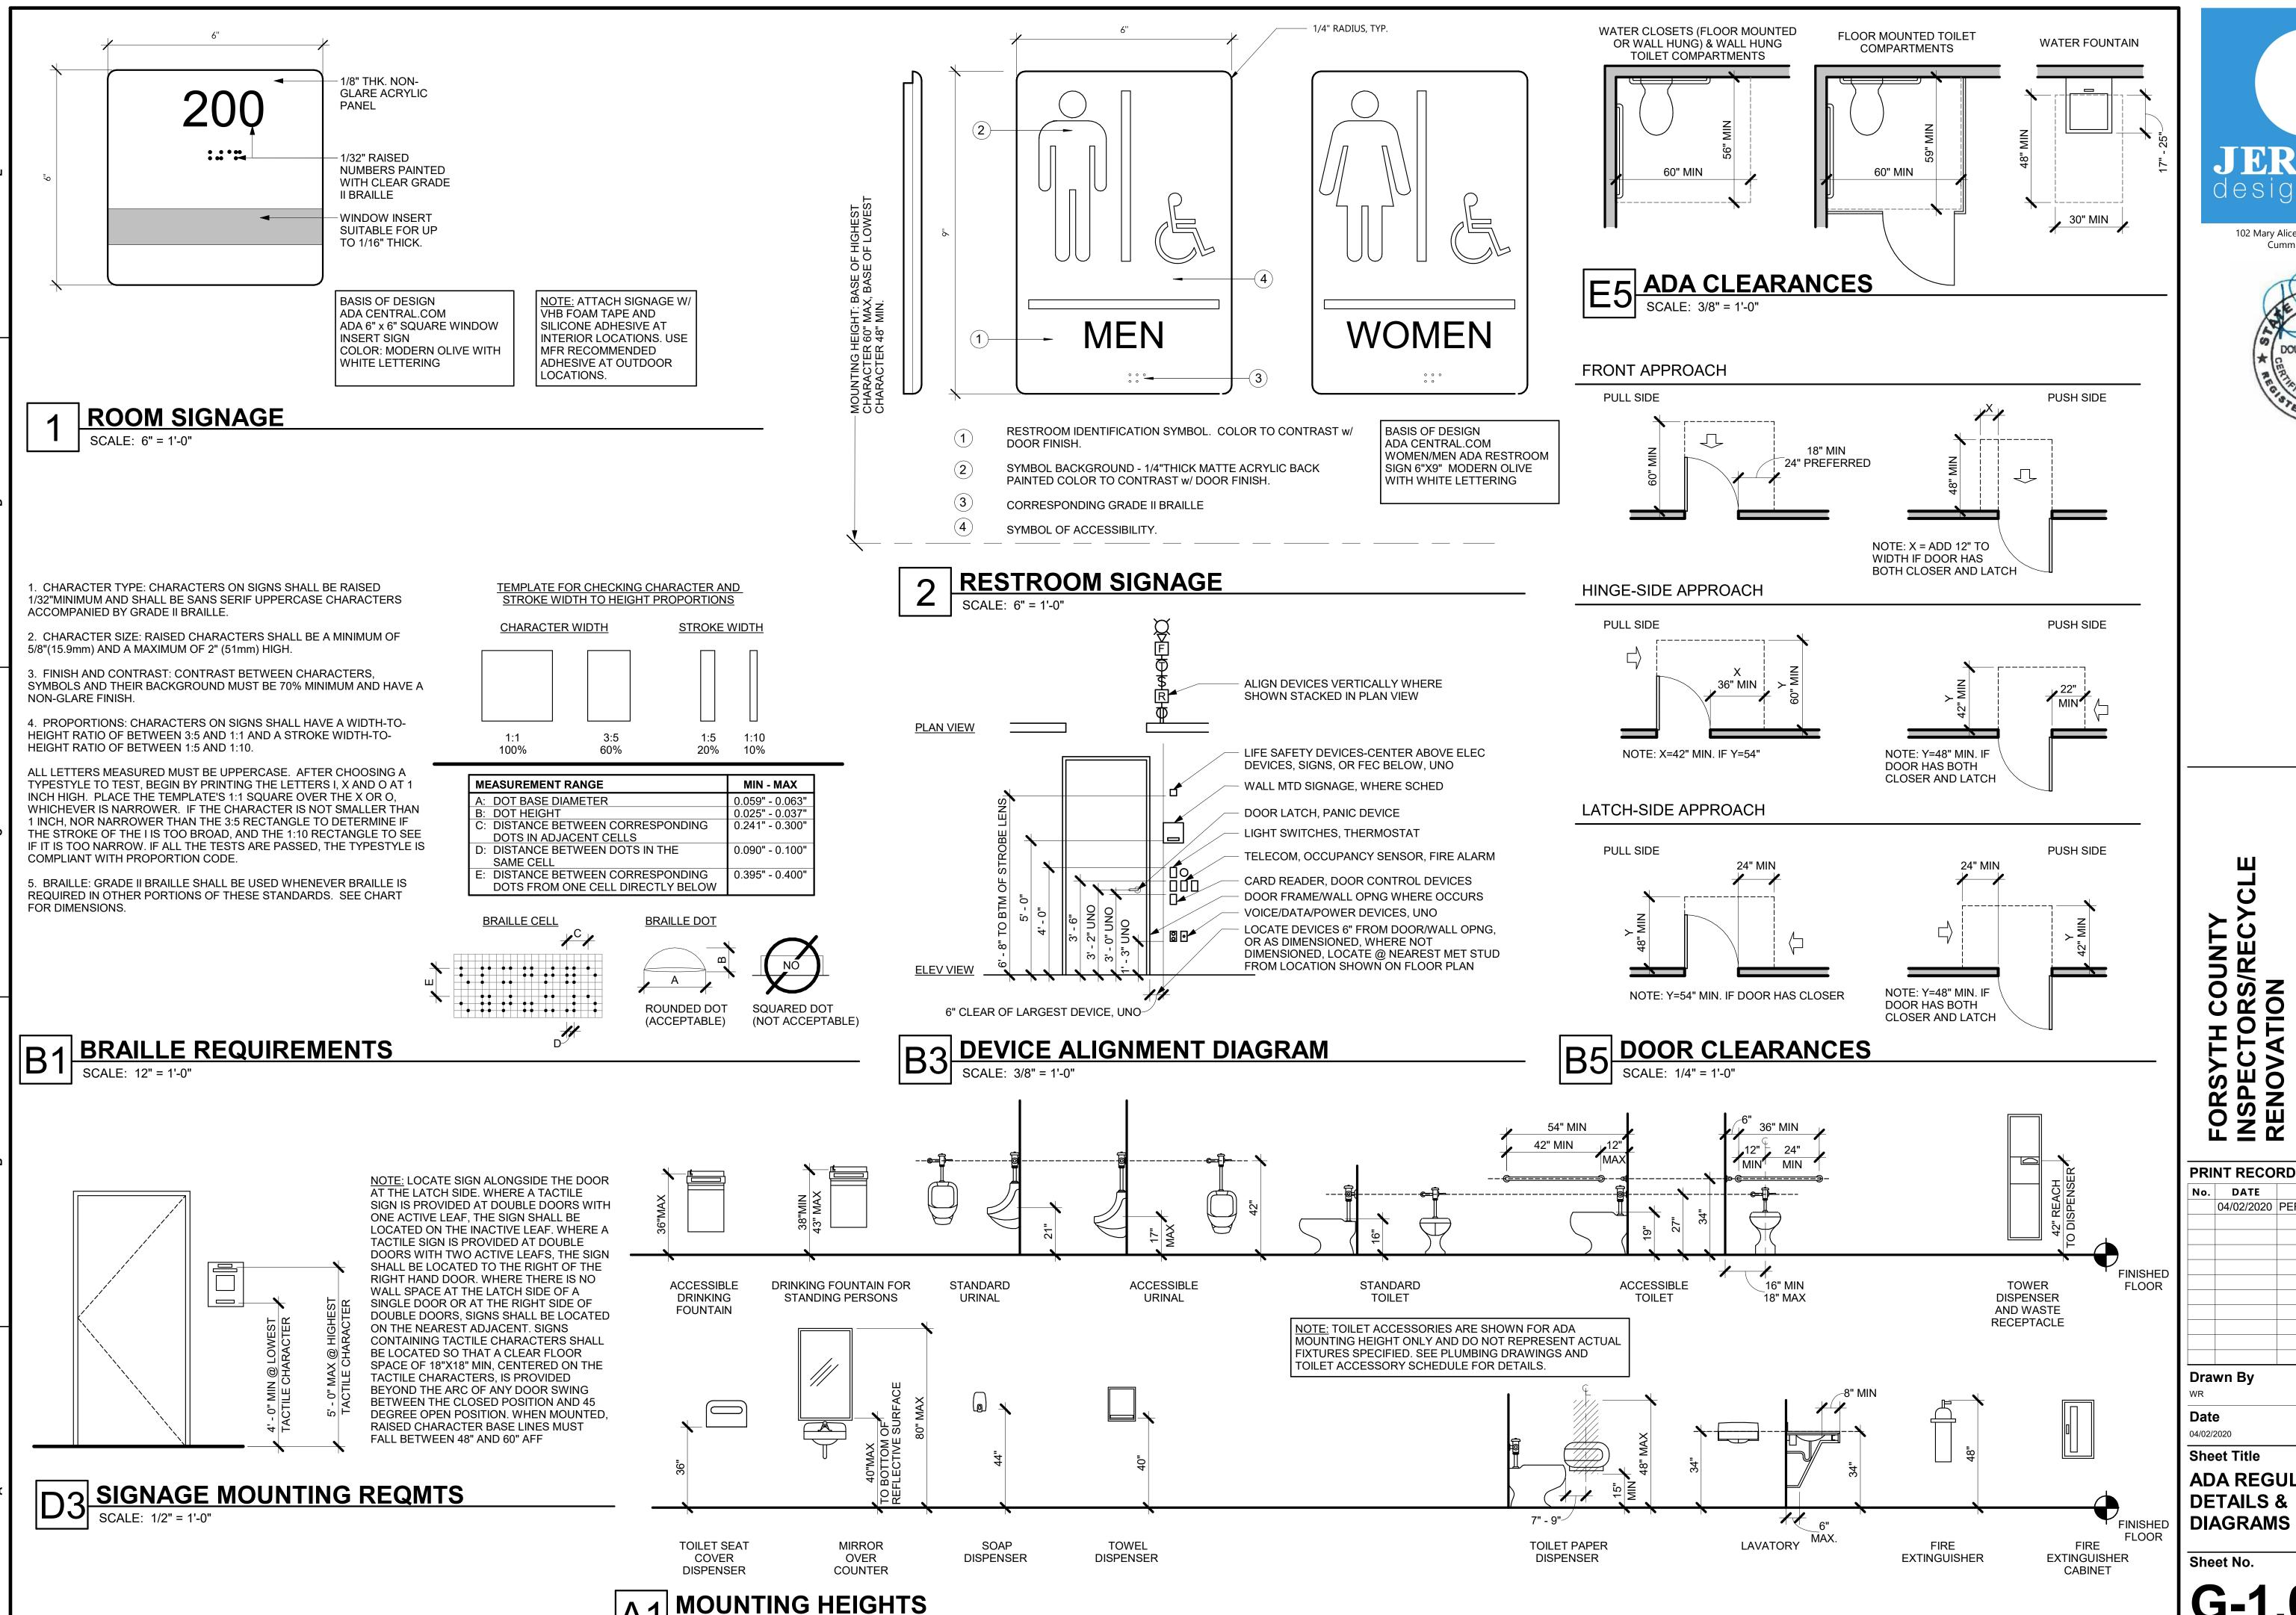

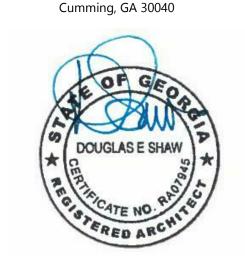

102 Mary Alice Park Road, Suite 103

## FORSYTH COUNTY INSPECTORS/RECYC

**PRINT RECORD** No. DATE **DESCRIPTION** 04/02/2020 PERMIT SET **Checked By** Drawn By JDG Job No. Date 04/02/2020

**Sheet Title ADA REGULATORY** 

Sheet No.

### 01 20 00 PRICE AND PAYMENT PROCEDURES

A. Applications for Payment shall utilize AIA G702, "Application and Certificate for Payment" including required continuation sheets. Approved Schedule of Values shall be used in the same format and values.

### B. Submit three copies of each application.

C. When Architect or Owner's Representative requests substantiating information, submit data justifying

D. Submit to the Architect or Owner's Representative for review and approval a Schedule of Values, at least ten consecutive business days prior to submitting first Application for Payment, utilizing AIA Document G703, "Continuation Sheet".

E. Use Project Specification headings as basis for format for listing costs of work under Divisions 02 - 49. Additional breakdown of work in certain sections may also be provided or required if needed or requested by the Architect or Owner's Representative.

### 01 30 00 ADMINISTRATIVE REQUIREMENTS

A. Contractor shall schedule and administer pre-construction meeting, periodic progress meetings, and specially called meetings throughout the work progress.

B. In order to provide for a regular review and evaluation of the Work and a systematic discussion of problems, the Owner's representative, Architect (if included in CA scope) and General Contractor shall meet at a mutually agreed schedule during the construction period. Representatives of contractor, subcontractors, and suppliers shall attend on an as needed basis. Contractor shall prepare agenda for meetings, make physical arrangements, preside, record minutes, and distribute copies of minutes within three days to those in attendance, those affected by decisions, the Owner's Representative, and the Architect, if he is involved during the construction.

C. Owner and Architect may attend meetings to ascertain work is expedited consistent with Contract Documents and construction schedules.

D. The Contractor's relations with his subcontractors and materials suppliers and discussions relative thereto, are the Contractor's responsibility and will not be part of the project meeting content.

E. To the maximum extent practicable, meetings will be held at the job site.

F. Contractor shall apply Contractor's stamp, signed or initialed in blue ink, certifying that review, approval, verification of products required, field dimensions, adjacent construction work, and coordination of information is in accordance with the requirements of the work and contract documents

G. Submit sufficient quantities of project data and shop drawings for Architect or Owner's Representative to retain two copies and for one copy to be retained by Contractor and turned over to the Owner at the completion of the Project.

H. Submit sufficient quantities of samples for Architect or Owner's Representative to retain one copy. Review of submittals is only for conformance with design concept of Project and information in Contract Documents.

I. Maintain an orderly file of submittals bearing the Architect's or Owner's Representative's review stamp for the Project duration at Project site and deliver to Owner as part of Project closeout documents.

J. Maintain at the site for the Owner, one record copy of drawings and specifications, addenda, change orders, construction change directives, approved shop drawings, product data, and samples, field test reports, and RFI documents.

K. Store in Contractor's field office in file cabinets or racks for storage of documents. Using record ments for construction purposes is prohibited. Label each document "PROJECT RECORD" in large printed and legible letters.

L. If applicable, on drawings legibly mark to record actual construction including depth of foundations, vertical and horizontal locations of underground utilities, field changes of dimension or detail, and any other changes including change orders.

M. It is the responsibility of the General Contractor to maintain the "as built" set of contract documents. These will serve as the as-built record recording all field built conditions and made part of the closeout

### 01 32 16 CONSTRUCTION PROGRESS SCHEDULE

A. Promptly after award of Contract, Contractor shall prepare and submit to Architect or Owner's Representative estimated construction progress schedules for construction activities.

B. A formal "Notice to Proceed" will be issued to mark commencement of project.

C. Progress schedules shall include complete sequence of activity, dates for beginning and completion of each element; show accumulated percentage of each item's completion and total percentage of work

D. Submit initial schedule with 15 days of Contract award. Submit revisions as needed to show major changes in scope or other identifiable changes.

E. Contractor shall submit samples, shop drawings, and product data to Architect or Owner's Representative as required by the specification sections below.

### 01 40 00 TESTING LABORATORY SERVICES

A. If required for the project, the Owner shall employ and pay for services of independent testing laboratory acceptable to Architect or Owner's Representative to perform specified services and testing.

### 01 43 30 SPECIAL INSPECTIONS

A. If required for the project, the Owner will retain the services of a qualified licensed Architect or Engineer to serve as 'Special Inspector(s)' to perform inspections pursuant to the Statement of Special Inspections scheduled on the drawings. Approved Special Inspector(s) shall provide testing and verification reports to Owner, architect, building official, and structural engineer of record which indicate the inspected work was done in conformance with approved construction documents.

### 01 50 00 TEMPORARY FACILITIES, CONTROLS, AND UTILITIES

A. Temporary construction office - provide all temporary facilities as required to build this project with sufficient space for Contractor's personnel, telephone/fax, and office space complete with desk and layout board.

B. Temporary storage facilities - if required, provide with weathertight, secure storage sheds or trailers, type and size required for storage. Locate where directed by Owner. Owner is not responsible for securing the temporary storage facility and any theft or loss that may occur.

C. Electrical service – Terms to be discussed prior to execution of contact between Owner and General Contractor. Electrical for construction purposes may be obtained from Owner's present facility, coordinate with Owner's Representative. Provide temporary lighting for construction purposes as required by OSHA or local code.

D. Telephone/Wi-Fi/Fax - provide telephone, telephone message service, Wi-Fi and fax service to the temporary construction office.

E. Temporary heat and ventilation - Maintain spaces in range of 600 F to 800 F, unless product manufacturer for a particular product calls for more stringent requirements. Interior renovation within an existing building, maintain spaces in range of 60o F to 80o F, unless product manufacturer for a particular product calls for more stringent requirements.

F. Water service - Terms to be discussed prior to execution of contact between Owner and General Contractor. Water for construction purposes may be obtained from Owner's present facility, coordinate with Owner's Representative.

G. Sanitary toilet facilities - Provide and maintain temporary toilet facilities and enclosures for construction personnel. Using permanent new or existing facilities in the building is prohibited by construction personnel.

H. Project sign - order and erect or position sign as requested by Owner's Representative, or as indicated in the Construction Documents. Coordinate location with Owner's Representative.

### 01 60 00 PRODUCT REQUIREMENTS

A. Provide new products unless specifically required or permitted by Contract Documents.

### 01 70 00 EXECUTION AND CLOSEOUT REQUIREMENTS

A. Clean-up during construction - execute cleaning procedures to ensure building interior, project site, and adjacent properties are maintained free from construction debris and rubbish. Maintain site, both exterior and interior, in clean and orderly condition. Provide covered, on-site containers for waste

B. Final cleaning - clean finish surfaces in accord with manufacturer's product data and requirements specified in sections not more than 48 hours prior to Date of Substantial Completion. Remove dust, debris, oils, stains, fingerprints, manufacturer's product labels and temporary labels from exposed interior and exterior finish surfaces, include washing and polishing interior and exterior glazing materials, vacuum carpeted and soft surfaces. Broom clean paved surfaces. Protect, maintain and clean inside of all HVAC supply and return ductwork free from dust and debris, and install new clean set of HVAC system filters not more the 48 hours prior to Date of Substantial Completion. Clean plumbing fixtures. Replace spent lamps and bulbs and clean lighting fixtures to "like-new" condition.

C. Submit operation and maintenance manuals - submit at issuance of Date of Substantial Completion or 15 days prior to final inspection whichever date is earlier. Submit in duplicate, in 8 1 /2" x 11-inch format in D size ring binders with plastic Covers including an electronic version of all documents in PDF format on a CD. Internally divide with permanent page dividers logically organized. Include:

1. Part 1 - Directory: list names, addresses, telephone numbers of Architect, Contractor, subcontractors, major equipment suppliers, and local service for major equipment.

2. Part 2 - Operation and Maintenance Instructions: arrange by system further subdivided by specification section and include significant design criteria, equipment list, component parts list, operating instructions and maintenance instructions.

3. Part 3 - Project Documents and Certificates: include shop drawings and product data, air balance reports, certificates, and photocopies of warranties and bonds.

D. Certificates from governing code authorities/AHJ indicating construction has been inspected as required by laws or ordinances and building is approved for occupancy.

E. Warranties - Provide executed warranty in writing, indicate Date of Substantial Completion and warranty expiration date. Warranty period begins on Date of Substantial Completion and continues for one year unless otherwise indicated in individual specification sections or otherwise provided by individual manufacturers' warranties.

F. Record Documents - Provide set of Record Documents with final Application for Payment. This includes a scanned copy of the as-built set of contract documents identifying, including but not limited to, all Bulletins, RFI's Change Orders and field conditions.

G. Tools, equipment, spare parts, extra material, attic stock and related items as required in specification sections at final Application for Payment

H. Fire extinguishers - Verify extinguishers are charged and ready for use, provide attached tag indicating date tested and by whom.

I. Keys - Construction keying shall be voided or change out cylinders that utilize construction keying. Deliver at Date of Substantial Completion to Owner's Representative keys with each tagged indicating lock which key operates. The Owner shall provide the General Contractor with Keying schedule unless directed otherwise by the Owner.

J. Maintenance training – provide a training class for each of the primary systems. Training class shall include Owner and/or Owner's designated representative. General Contractor shall video tape training class for archiving and reference by the Owner and/or Owner's designated representative.

FOR THE FOLLOWING MATERIAL SPECIFICATIONS. REFERENCE AND COMPLY WITH THE MANUFACTURER'S PRODUCT LITERATURE. SPECIFICATIONS. AND WRITTEN INSTRUCTIONS ON INSTALLATION UNLESS OTHERWISE NOTED.

### 02 41 00 BUILDING DEMOLITION

A. Comply with the most recent applicable codes for demolition of structures, safety of adjacent structures, noise control, and dust control. Obtain required permits, notify affected utility companies and comply with their requirements, conform to regulatory procedures when hazardous or contaminated materials are discovered, and do not close or obstruct roadways without permits.

B. Suspend operations immediately if hazardous or contaminated materials such as asbestos or polychlorinated biphenyl), not previously rendered harmless, are encountered, contact Architect and Owner in writing. Do not resume operations until directed, hazardous or contaminated materials have been rendered harmless, and conditions are agreed to by Owner and Contractor in writing.

C. Provide and maintain temporary barriers and security procedures as required to protect property and people and to meet the requirements of the General Conditions. Protect existing landscaping, appurtenances and structures that are not to be demolished. Prevent movement or settlement of adjacent structures. Provide bracing and shoring. Mark location of all utilities prior to proceeding with scope of work.

D. Minimize interference with adjacent structures and public or private access. Maintain protected egress and access at all times. Obtain written permission from adjacent property Owners when demolition equipment will traverse or infringe upon their property. Suspend operations immediately if adjacent structures appear to be in danger, contact Architect and authority having jurisdiction, do not resume operations until directed. Provide hoses and water connection to sprinkle demolition area with water to minimize dust. It is the sole responsibility of the General Contractor to confine duct and odors to construction area and quickly remediate any breeches in containment.

### 06 10 00 ROUGH CARPENTRY

A. Lumber shall be #2 Southern Pine or Western Lumber. Miscellaneous furring and nailers shall be utility grade Southern Pine. Nailers and blocking associated with roofing and flashing systems shall be preservative and fire-retardant treated. Exterior plywood shall be CC-EXT-APA, Group I. Interior plywood shall be A-D, INT-APA, Group 1. Fire-retardant-treated wood.

B. Provide concealed blocking, nailers, and supports for securing applied fixtures and fittings; specific items to be indicated on the drawings.

C. Provide concealed blocking, nailers, and supports for securing base cabinets and wall mounted cabinets to partitions. Reference drawings for locations of base and wall mounted cabinets.

D. Provide concealed blocking, nailers, and supports for securing video/t.v./monitors to partitions. Reference drawings for locations of wall mounted video/t.v./monitor locations.

E. Backboards at phone equipment shall be 3 /4" fire treated plywood, painted face and all exposed edges. Sand, prime and ease all edges prior to painting.

F. Nailing schedule shall be in accord with current edition of International Building Code.

G. Install rough carpentry work cut square on bearings, closely fitted, accurately set to required lines and levels and secured in place. Brush apply preservative treatment to cut ends of treated lumber. Coordinate location of blocking and nailers with locations of finishing materials, fixtures, specialty items and trim. Install plywood with face grain perpendicular to supports. Terminate panels over supports, allowing 1/8" between end joints and 1/4" between edge joints for expansion and contraction.

A. Coordinate and install millwork provided by Tenant, and as indicated on drawings.

B. Installer must have a minimum of five years' experience in the same field and be able to demonstrate successful projects that meet the specified AWI grade.

C. Source Quality Control: Obtain materials for each type, including veneer doors, from a single manufacturer or source so as to ensure matching of quality, color, grain, and finish.

D. Quality standards for the following types of architectural woodwork, "Premium Grade" except as modified, as follows:

- Standing trim, running trim, and rails: AWI Section 300, Custom Grade.
- 2. Architectural cabinets, laminate clad: AWI Sections 400 for Flush Overlay and 400B, Premium
- 3. Architectural cabinet tops: AWI Sections 400 for High Pressure Decorative Laminate tops and
- 400C, Custom Grade
- 4. Shelving: AWI Section 600, Custom Grade. 5. Paneling: AWI Section 700.
- 6. Miscellaneous ornamental items: AWI Section 700.

Stile and rail doors: AWI Section 1400. 8. Factory Finishing: AWI Section 1500.

E. Wood Treatment: Where fire-retardant treated woodwork is indicated, use approved fire-retardant treatment that will not adversely affect the desired finish and appearance.

F. Project Conditions: Stabilize humidity and temperature at normal operating Conditions at least seven (7) calendar days prior to installation and thereafter.

G. Installation: Meet AWI standards for quality standards and premium construction for tolerances. Scribe and cut work to fit adjoining work, refinish cut surfaces and repair damaged finish at cuts. Anchor casework to anchors or blocking built-in or directly attached to substrate. Secure to grounds, stripping, and blocking with countersunk concealed fasteners and blind nailing as required for a complete

H. Lumber (Verify all species selections with drawings):

1. Exposed and semi-exposed painted millwork and trim: Custom Grade Poplar or Custom Grade White

2. Interior standing and running trim: Custom Grade Poplar or Custom Grade White Pine, kiln dried. Install in single, unjointed lengths for openings and runs less than 16'-0". Stagger joints in adjacent members. Cope at returns, miter at corners.

### I. Hardware

- 1. Door and drawer pulls to be 4" matt nickel stainless steel.
- 2. Concealed hinges to be Grade 2 (Institutional duty), 170 degrees opening 3. Door and drawer locks: provide elbow catches on un-keyed leaf of pair of doors. If electronic
- push button, provide battery operated with low battery indicator. 4. Drawer Slides to be full extensions slides; 100lb per slide per standard drawer, 150lb per slide
- per standard file drawer and 250lb per lateral file drawer. 5. Shelf standards to be same color as cabinet interior.

J. Countertops shall have 1-1/2" radiused corners as indicated on drawings, U.N.O.

### 07 21 00 THERMAL INSULATION

A. Batt insulation shall be fiberglass batts width equal to framing spacing, kraft face, ASTM C665, Type II, Class C, 1.0 perm rating, R-13 in walls.

B. Rigid extruded polystyrene insulation shall be extruded, closed cell, CFC-12 free, polystyrene boards meeting ASTM C578, Type IV for use in perimeter and other applications, thickness 2" or as scheduled

C. Safing Insulation – shall be unfaced, semi-rigid, 4 pcf minimum. Install in cavities of all floor-to-floor penetrations; include spaces around piping and duct penetrations. Foam safing may be used in lieu of

D. Sound insulation - refer to Section 09 21 16 Gypsum Board Assemblies.

E. Provide continuous 1 /4" foam tape filler where walls meet window mullions. Provide double foam tape fill at demising wall between tenants, intersecting partitions and demising walls.

### 07 84 00 FIRE STOPPING

Fire stopping shall be single component self-adhering, flexible, water-tight, non-sag, elastomeric silicon or endothermic latex compound. Provide firestopping as required to maintain ratings at all penetrations through rated walls, partitions, floors and floor-ceiling assemblies. Fire-stopping to comply with Underwriters Lavatory testing numbers where apply.

### 07 90 05 SEALANTS AND CAULKS

and interior door and window frames perimeter.

shrinkage factor not exceeding 15%.

Exterior joints and all other openings in the building shall be caulked, gasketed, weather-stripped, or sealed in an approved manner (ref. Georgia State Energy Code, Section 502.4). Seal all sound partitions with acoustical sealant at base, head, perimeter and all openings.

A. Silicone sanitary sealant, SSS-1, one-part silicone rubber, mildew and stain resistant, ASTM C920, Type S, Grade NS, Class 25. Use at plumbing fixture perimeters mounted on walls and top and edges of backsplashes at countertops.

B. Two-part non-sag polyurethane sealant, PSV2-1, two-part polyurethane based sealant with separate prepackaged color agent to achieve colors, ASTM C920, Type M, Grade NS, Class 25. Use at exterior

C. Caulking compound for setting thresholds and for other interior caulking shall be an oleo-resinous, gun grade, non-staining plastic compound meeting Federal Specification TT-T-598. Material shall have

D. Acrylic-latex caulk, ALC-1, flexible paintable, non-staining, non-bleeding acrylic emulsion, ASTM C834. Use at interior non-working cosmetic joints between similar and dissimilar adjacent materials.

E. Butyl caulk, BC-1, one part butyl rubber caulk, ASTM C1085, black. Use continuous double bead at sill or threshold of exterior swinging doors.

F. Backer rod, compressible rod stock closed cell foam, open cell foam, soft cell foam, or neoprene foam, type recommended by sealant manufacturer for material compatibility and conditions encountered.

### **08 11 00 WOOD FRAMES**

A. Exterior steel doors and frames to be Building Standard.

B. Verify existing casing style size on site. WM356 Woodgrain Millwork 11/16 IN x 2- 1/4 in WM356 primed finger jointed pine casing door - 84 inch sides which is enough material to finish both sides of a

C. Frame construction shall be factory primed, pressed steel, frames for doors and other indicated openings. Exterior door frames shall be 16-gauge, face welded, seamless with joints filled and weatherstripping per Section 08710. Interior frames shall be knock down "KD" type frames, and 16-gauge. All frames shall have labels for labeled openings as required, with standard rubber, neoprene, or silicone

D. Provide manufacturer's standard frame anchors for attachment to studs at 2'0" o.c. max or fraction

E. Door construction for exterior units shall be Grade II, Heavy Duty, seamless composite construction, 16-gauge material, with 20 PSI compressive strength foamed-in-place polyurethane core.

F. Submit manufacturer's product data and shop drawings indicating door and frame elevations, sections, materials, gauges, finishes, fabrication and erection details, location of finish hardware by dimension, and details of openings and louvers.

G. Provide metal drip at exterior door frames which have no alternative cover.

08 14 16 FLUSH WOOD DOORS A. Industry standards are those of the National Wood Window and Door Association (NWWDA) and the Architectural Woodwork Institute (AWI). Fire-rated wood doors shall bear label of testing and approval by independent testing agency, having been tested in accord with UBC 7-2-1997 or UL 10-C for ratings

B. Wood doors shall be solid, particle board core, 1-3/4" thickness, meeting NWMA I.S.-1. minimum fiveply, 1-3/4" thickness. Core shall have min. 28 pcf density. Premium Grade, with "Plain-Sawn" White Oak" face veneers and edges; veneers book matched across door face; full length. Plastic laminate veneer doors shall consist of .050" high pressure decorative laminate. Conform to NEMA Standard LD-3-1980, Grade GP 50. Fire rated doors shall be rated as shown on the drawings, with factory installed labels. Fire rated doors shall have reinforced edges to accept full mortise hinges.

C. Execution: install doors in respective frames using specified hardware. Doors shall operate without binding or sticking at frames or floor. Maintain NWWDA and NFPA No. 80 standard tolerances.

D. Submit shop drawings indicating door species, finish, sizes, construction, and hardware locations.

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### C UNTY /REC STH ( PE O

PRINT RECORD No. DATE **DESCRIPTION** 04/02/2020 PERMIT SET Drawn By Checked By Date Job No.

Sheet No.

**Sheet Title** 

**SPECIFICATIONS** 

A. If applicable - building exterior or suite entry door, door hardware to be Building Standard.

B. Interior door hinges, interior locksets and latchsets to be Building Standard or as directed by Owner, Hospital push/pull latches to be ABH Manufacturing or equal, interior door closers to be Building Standard, overhead door stop to be Glynn-Johnson, wall stops to be Burnes or equal.

C. Flush bolts, door silencers, kick plates, armor plates and panic exit device to be Building Standard or as directed by Owner.

D. Obtain each type of hardware from a single manufacturer. Hardware supplier shall be a recognized architectural door hardware supplier that employs an experienced architectural hardware consultant (AHC) who is available to Owner, Architect, and Contractor for consultation. Submit proposed hardware schedule developed by AHC organized into hardware sets for each door or opening to Owner's Representative for review and approval prior to ordering hardware.

E. Material and finishes: Coordinators - 600 (USP), Other items 630 (US32D) or 626 (US26D) if not commercially available. Architect to select finial color.

F. Warranty door hardware for one-year period and door closers for ten-year period.

G. Hinges, provide full mortise hinges, heavy duty ball bearing butts with non-rising stainless-steel pins, exterior doors non-removable pins, 4 1/2" by 4 1/2" unless otherwise required for proper operation, 3 hinges per door leaf minimum, Continuous hinge to be placed on doors 3'-6" wide and over door leafs. Aluminum hinge at all non-rated doors, stainless steel hinge at rated doors. Acceptable manufacturers are Hager Hinge Company, Lawrence Brothers, Stanley Works and Marker Products, 100/300 series.

H. Lock cylinders and keying, supplier will meet with Owner to finalize keying requirements. Master key the locks to Owner's current or new system. Cylinders shall be manufacturer's standard 6-pin tumbler cylinders, constructed from brass/bronze, stainless steel or nickel silver. Furnish 2 change keys for each lock and 6 master keys.

I. Locksets, latchsets, and specialty locks shall be Building Standard (unless directed by the Owner), heavy-duty commercial cylindrical type, 2 3/4" backset. Lever to be Building Standard (unless directed by the Owner). Furnish locksets and latchsets with sufficient strike lip to protect door trim.

J. Surface mounted door closers shall be Building Standard. Provide closers as shown on door schedule. Powder coat finish to match adjacent door hardware.

K. Stops and Holders: overhead door stop shall be Glynn-Johnson series 90 and/or 100, wall stop to be Burnes 565 and floor stop to be 535. Where practical use wall stops unless noted otherwise on drawings. Other acceptable manufacturers are Rockwood Manufacturing and H.B. Ives. Provide stops at all doors.

J. Flush bolts shall have a 3/4" throw, complete with dust-proof bottom and top strike plate to be Building Standard (unless directed by the Owner).

K. Kickplates shall be Rockwood Manufacturing, K1050 series. kickplates shall not more than 1-1/2" less than door width on stop side and not more than 1/2" less than door width on pull side. Armor plates to be shall be Rockwood Manufacturing, K1050A-6 series.

L. Thresholds shall be National Guard Products Inc., #425, extruded smooth mill finish. Other acceptable manufacturers are Reese and Zero Weatherstripping Company. Provide at all exterior doors.

L. Weatherstripping shall be National Guard Products Inc., #133 SA door seals and #200SA door bottom seals. Other acceptable manufacturers are Reese and Zero Weatherstripping Company. Provide at all hollow metal exterior doors.

### 09 21 16 GYPSUM BOARD ASSEMBLIES

All gypsum board systems shall be in accordance with recommendations and instructions published by U.S. Gypsum Company's "Gypsum Construction Handbook", latest edition.

A. Non-loadbearing metal framing materials: Metal framing shall be cold-rolled, galvanized steel studs and runners, stud gauge as required by manufacturer's product data for heights and conditions of use; maximum deflection of I/240; sizes indicated.

B. Gypsum board: Exterior gypsum sheathing shall be moisture and fire-resistant type, thickness as indicated, with square edges. Standard gypsum board shall be 5/8" thickness, tapered edges. Fire retardant gypsum board shall be Type 'X', 5/8" thickness, tapered edges. Provide Dens-Shield DS012 gypsum board (or equal) at all non-tile wet walls. Provide Dens-Shield DS001 gypsum board (or equal) at all wet walls to receive ceramic tile. Minimize butt end joints, especially in highly visible locations. Use screws for attachment of all gypsum board.

C. Acoustic ceilings: 6" x 20 GA metal joists, or as otherwise indicated on drawings at 16" o.c. with denim batt acoustic insulation. Sheath with 1/2" sound board with applied mass loaded vinyl sound barrier adhered with Green glue. Provide 3/4" gypsum wall board metal clips @ 16" on center, horizontal, screwed to mass loaded vinyl. Overlay with 5/8" gypsum wall board applied to clips, tape and spackle all joints. Finish with batt insulation and acoustical ceiling tile system as indicated on drawings.

D. Acoustic partitions: 3 5/8" x 20 GA metal studs at 16" o.c. with denim batt acoustic insulation. Sheath with 1/2" sound board with applied mass loaded vinyl sound barrier adhered with Green glue. Provide 3/4" gypsum wall board metal clips @ 16" on center, horizontal, screwed to mass loaded vinyl. Overlay with 5/8" gypsum wall board applied to clips, provide level 5 finish.

E. Joint tape, perforated type recommended for board type use. Joint compound, ready mixed tape embedment and topping compounds, type recommended for board type use.

F. Sound Attenuation Blankets: for partition and ceiling cavities, sound blankets shall be unfaced mineral-fiber blanket insulation manufacturered from slag wool or rock wool with thermosetting resins to comply with ASTM C665. Blankets shall have a minimum density of 2.5 pcf, 1-1/2" thickness.

G. Tape fill, and sand exposed joints, edges, and corners to produce smooth surface ready to receive finishes. Feather coats of joint compound so that camber is maximum 1/32 inch. Surfacing material to be U.S. Gypsum Company, Sheetrock First Coat.

H. Accessories include corner reinforcement, Unimast Inc. SHEETROCK No. 800. Metal jamb, ceiling and casing "U" and "J" shaped trim providing edge protection and neat finished edges, Unimast Inc. SHEETROCK Trim No. 801 series. Resilient channel, Unimast Inc. RC-1 Resilient Channel, 25 gauge galvanized steel.

I. Provide aluminum wall mullion end caps to match the color of existing window mullions where partitions terminate at window mullions.

J. Install framing at indicated spacing, plumb and rigid in accord with ASTM C754. Apply wallboard and fasten at intervals recommended by wallboard manufacturer. Apply embedding, filing and finishing coats of joint compound to all joints, with joint tape in the embedding coat. Install sound attenuation blankets where indicated. Partitions receiving sound attenuation blankets shall have acoustical sealant around perimeter of partition and penetrations on both sides of partition.

### 09 51 00 ACOUSTICAL CEILINGS

A. Install acoustical tile ceilings in compliance with ASTM C636. Secure hanger wires to structure above with double saddle ties and limit to no more than 1/360 of span of members. Support free edges of ceiling tile with edge angles attached to suspension system.

### B. Standards

Acoustical ceiling panels shall be USG or Armstrong Ceilings, Non-directional fissured design, size 24" by 24", 5/8" thickness, tegular edges, color white; unless otherwise scheduled on drawings.

C. Exposed ceiling suspension grid system shall be in heavy duty, 24" by 24" or 24" x 48" module as indicated on drawings, cold-rolled steel, electro-galvanized, double web, 15/16" flange width, 1-1/2" height main tees, with low gloss, white paint. Edge molding minimum 0.020" thickness steel with 3/4" flange width, hemmed edge.

D. If applicable, Provide foam or neoprene spacers in space between top of partition and ceiling at ceiling height sound walls.

E. Install acoustical tile and panel systems as indicated on drawings. Direct hang suspension systems from structure; hanger wires spaced at 4'-0" o.c. maximum, with additional hangers at ends of each suspension member. Space main tees at 4'-0" o.c. maximum, with cross tees spaced as required to form grids. Install wall moldings at vertical surfaces. Replace soiled or damaged panels. Provide additional support at unrestrained conditions and where structure spacing requires indirect hanging.

### 09 65 00 RESILIENT FLOORING

A. Do not start work until work of other trades, including painting, has been substantially completed. Flooring shall be installed prior to the installation of millwork or casework.

B. Resilient tile flooring materials shall be installed with adhesives, as recommended by the tile manufacturer, and in a manner to produce a smooth and even finished surface with tile in tight jointed accurately aligned manner. All in accordance with manufacturer's directions.

C. Lay tile square with room axis, unless noted otherwise on the drawings. Lay edge tiles of same style as field with width varying to maintain full size tiles in field. Edge tiles shall not be smaller than half the width of the field tile.

D. Just prior to final completion, apply wax as recommended by the manufacturer. Machine buff floors

E. Extra Materials: Furnish not less than one box for each 40 boxes for each type, color, pattern and size installed. I less than 40 boxes installed, supply one box of each.

F. Where rubber base is specified, only roll type is acceptable.

### 09 66 00 RESILIENT SHEET FLOORING

A. Do not start work until work of other trades, including painting, has been substantially completed Flooring shall be installed prior to the installation of millwork or casework.

B. Resilient sheet flooring materials shall be installed with adhesives, as recommended by the tile manufacturer, and in a manner to produce a smooth and even finished surface with tight, heat-welded joints, in an accurately aligned manner per the manufacturer's directions.

C. Edging strips shall be installed at exposed edges of resilient sheet flooring and at doors where thresholds are not called out for in drawings.

D. Resilient base to be installed in compliance with manufacturer's recommendations.

E. Flash cove base to be 6" high with top edge strip and made from a minimum of 12-inch-wide strips. Use premanufactured cove strip at base of cove. Cap top of formed cove base with the specified cove

F. Just prior to final completion, apply wax as recommended by the manufacturer.

G. Extra Materials: Furnish not less than 5 lineal yards or 2% of total project material, whichever is greater

H. Where rubber base is specified, only roll type is acceptable.

### 68 00 CARPET SQUARES

Submit 3 samples, minimum 12"x12" of all specified carpet finishes and manufacturer's product literature.

A. Carpet shall be as specified on drawings. Installation method to be direct-glued per manufacturer recommendations

B. Fill cracks in concrete slab 1/16" wide or wider and depressions 1/8" deep or deeper with crack filler. Remove or level ridges or high spots. Lay carpet with pattern or direction running in same direction. T-seams in doorways are prohibited.

C. Carpet to carpet transitions at doors shall occur directly under door in the Closed position.

D. Provide rubber/vinyl transition strips at all carpet to hard floor finish conditions unless otherwise noted. Color to match adjacent rubber /vinyl base or, at wood base conditions, as selected by Architect from manufacturer's standard selections.

E. Extra Materials: Furnish extra materials described below that match products installed and that are packaged with protective covering for storage and identified with labels describing contents.

F. Carpet: Full width rolls equal to 5 percent of amount installed for each type indicated, but not less than 10 sq. yd.

G. Where rubber base is specified, only roll type is acceptable.

### 09 90 00 PAINTING

See drawings for information. For purpose of establishing a quality standard, Sherwin-Williams Company (BOD) are herein specified.

A. Tint prime coats to 1/3 shade of top coat.

B. The number of coats specified are the minimum required. First coat to be primer, second and third coat to be finish coat. The surface of all materials that are to be painted shall be completely hidden. Coverage shall be complete and meet manufacturer's standards for finish.

C. Doors and frames shall be sprayed, not rolled or brushed.

D. Paint materials shall be applied in accordance with the manufacturer's directions on the container label. Materials shall be evenly spread and smoothly flowed-on without runs, sags, dry spray or other film defects.

E. Extra Materials: Supply for each finish coating material, color and finish specified, one gallon of coating material, marked with color and finish identification.

### 10 28 00 TOILET AND BATH ACCESSORIES

A. Products specified are Building Standard. Use ANSI Type 304 stainless steel for all parts except mounting kits for grab bars unless directed otherwise by Owner.

B. Toilet and bath accessories schedule: as indicated on drawings.

C. Submit catalog cuts and data sheets indicating size, material and finish, complete parts list, and installation procedures for each accessory.

### 10 44 00 FIRE PROTECTION SPECIALTIES

A. Extinguishers shall be multi-purpose dry chemical extinguisher, ten lbs., UL rating 4A-60B:C, with bracket supporting extinguisher top and bottom, holding extinguisher off finished wall surface if not located in cabinet.

B. Fire extinguisher cabinets shall be semi-recessed, sized to fit extinguishers, minimum 18-gauge steel cabinet, door and trim material, prefinished white painted. Door shall be duo vertical panel, with tempered glass, with full length piano hinge, roller catch, and pull, and lettering FIRE EXTINGUISHER in red pressure sensitive vinyl lettering running vertical.

C. Locate at 48" AFF, one per every 75 linear feet of travel distance, one per every 3,000 SF, or per Fire Marshal's direction. Reference drawings for locations.

D. All extinguishers in finished areas shall be set in cabinets.

**DIVISIONS 21, 22, & 23 MECHANICAL AND ELECTRICAL**A. See engineering drawings for specifications.



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### ORSYTH COUNTY ISPECTORS/RECYCL ENOVATION

PRI	NT RECO	RD
No.	DATE	DESCRIPTION
	04/02/2020	PERMIT SET
<b>Dra</b> v	wn By	Checked By JDG

Job No.

**SPECIFICATIONS** 

Sheet No.

Date

04/02/2020


**Sheet Title** 

G-3.02

THEIR ENTIRETY. PATCH & REPAIR SURFACES FOR NEW FINISHES.

NOTE: REFERENCE MECHANICAL, ELECTRICAL & PLUMBING DRAWINGS & SPECS FOR ADDITIONAL DEMOLITION NOTES.

TO RECEIVE NEW FINISHES

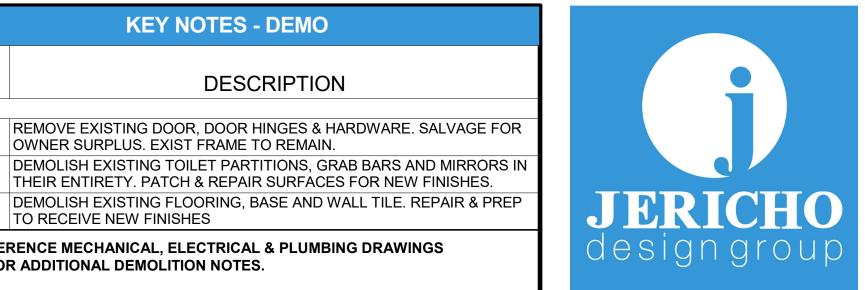

102 Mary Alice Park Road, Suite 103 Cumming, GA 30040



## FORSYTH COUNTY INSPECTORS/RECYCLE RENOVATION

PRI	INSPECTORS/	FORSYTH COUNTY	426 CANTON HWY CUMMING, GA 30040
No.	DATE	DESCR	IPTION
		PERMIT SET	
<b>Dra</b> v	wn By	Ch	necked By

Job No. Date 04/02/2020

Sheet Title

DEMOLITION PLAN


Sheet No.


D-1.01

RELEASED FOR CONSTRUCTION



A1 DEMOLITION PLAN
SCALE: 1/8" = 1'-0"

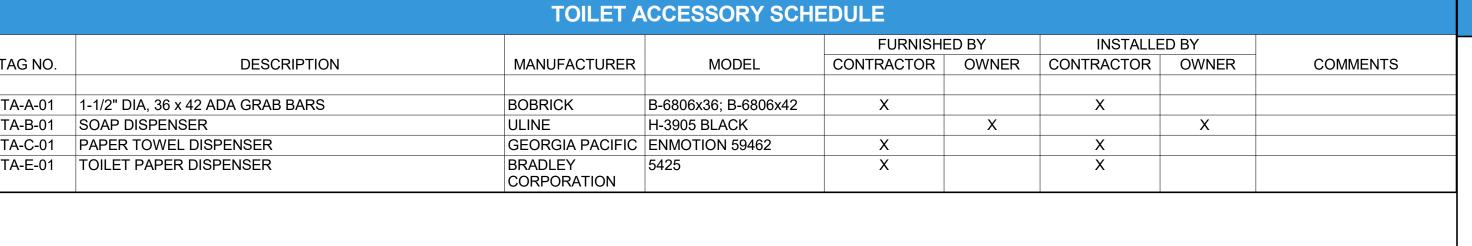

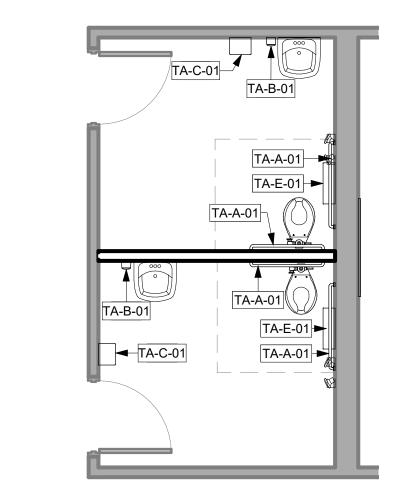


2 RR 102/103

TA-A-01

TA-A-01

RR 119/120 SCALE: 1/4" = 1'-0"

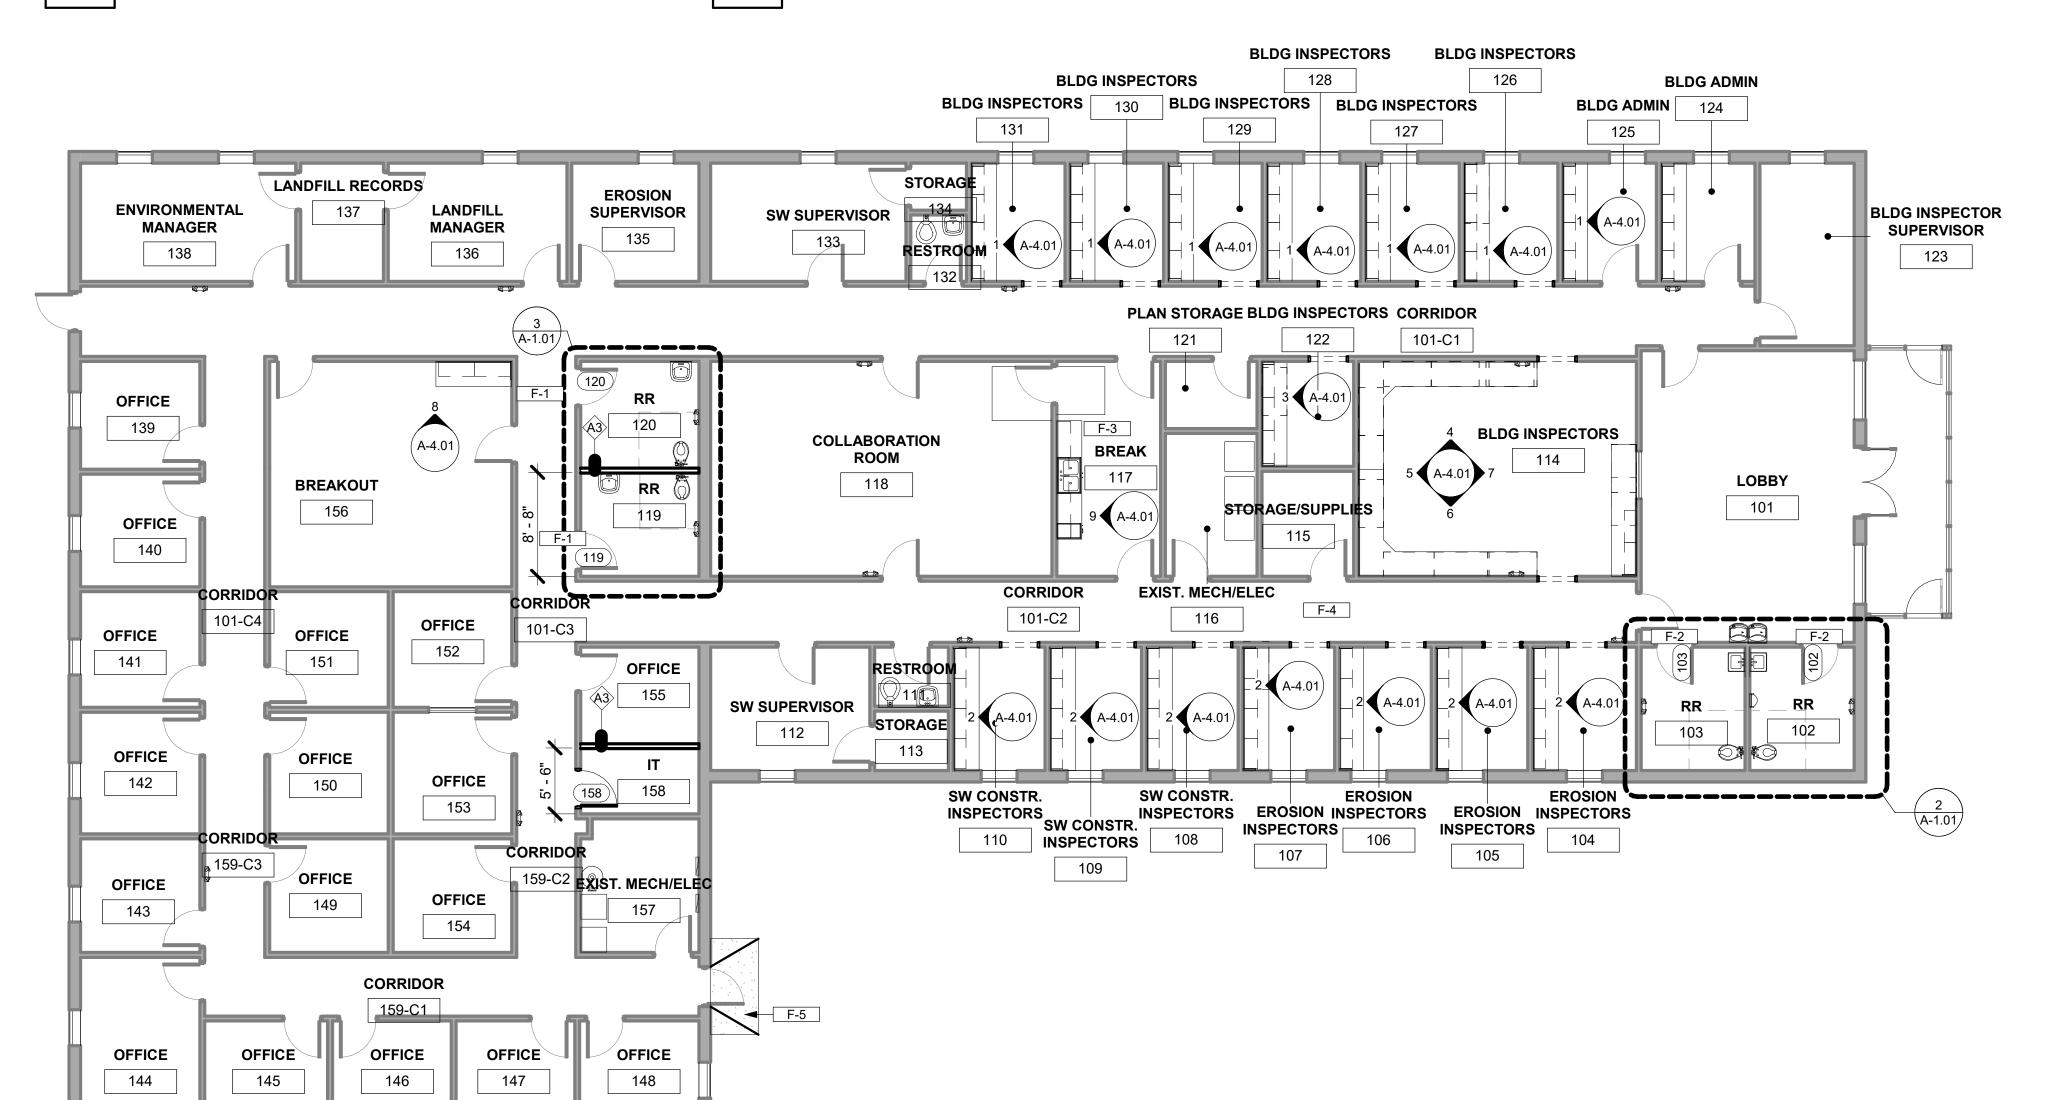

FINISH & REFERENCE FLOOR PLAN



	KEY NOTES - FINISH PLAN
KEY	
NOTE #	DESCRIPTION
F-1	TRANSITION CPT TO LVP
F-2	TRANSITION TILE TO LVP
F-3	ALTERNATE ADD #1
F-4	PAINT ALL WALLS UNDER EXISTING CHAIR RAILS PT-3
F-5	4" THICK BROOM FINISH CONCRETE PAD SLOPE AWAY FROM BUILDING AND/OR

	ROOM	M FINISH	SCHEDUL	E
Number	Name	Base Finish	Wall Finish	Floor Finish
Number	Name	Dase i illisii	vvali i illisii	1 1001 1 1111311
101	LOBBY	EXISTING	PT-1	EXISTING
101-C1	CORRIDOR	EXISTING	PT-1	EXISTING
101-C2	CORRIDOR	EXISTING	PT-1	EXISTING
101-C3	CORRIDOR	EXISTING	PT-1	EXISTING
101-C4	CORRIDOR	EXISTING	PT-1	EXISTING
102	RR	RB-1	PT-1	LVP-1
103	RR	RB-1	PT-1	LVP-1
104	EROSION INSPECTORS	EXISTING	PT-1	EXISTING
105	EROSION INSPECTORS	EXISTING	PT-1	EXISTING
106	EROSION INSPECTORS	EXISTING	PT-1	EXISTING
107	EROSION INSPECTORS	EXISTING	PT-1	EXISTING
108	SW CONSTR. INSPECTORS	EXISTING	PT-1	EXISTING
109	SW CONSTR. INSPECTORS	EXISTING	PT-1	EXISTING
110	SW CONSTR. INSPECTORS	EXISTING	PT-1	EXISTING
111	RESTROOM	EXISTING	PT-1	EXISTING
112	SW SUPERVISOR	EXISTING	PT-1	EXISTING
113	STORAGE	EXISTING	PT-1	EXISTING
114	BLDG INSPECTORS	EXISTING	PT-1	EXISTING
11 <del>4</del> 115	STORAGE/SUPPLIES	EXISTING	PT-1	EXISTING
115 116	EXIST. MECH/ELEC	EXISTING	PT-1	EXISTING
				EXISTING
117	BREAK	EXISTING	PT-1	
118	COLLABORATION ROOM	EXISTING	PT-1	EXISTING
119	RR	RB-1	PT-1	LVP-1
120	RR	RB-1	PT-1	LVP-1
121	PLAN STORAGE	EXISTING	PT-1	EXISTING
122	BLDG INSPECTORS	EXISTING	PT-1	EXISTING
123	BLDG INSPECTOR	EXISTING	PT-1	EXISTING
404	SUPERVISOR	EVICTING	DT 4	EVICTING
124	BLDG ADMIN	EXISTING	PT-1	EXISTING
125	BLDG ADMIN	EXISTING	PT-1	EXISTING
126	BLDG INSPECTORS	EXISTING	PT-1	EXISTING
127	BLDG INSPECTORS	EXISTING	PT-1	EXISTING
128	BLDG INSPECTORS	EXISTING	PT-1	EXISTING
129	BLDG INSPECTORS	EXISTING	PT-1	EXISTING
130	BLDG INSPECTORS	EXISTING	PT-1	EXISTING
131	BLDG INSPECTORS	EXISTING	PT-1	EXISTING
132	RESTROOM	EXISTING	PT-1	EXISTING
133	SW SUPERVISOR	EXISTING	PT-1	EXISTING
134	STORAGE	EXISTING	PT-1	EXISTING
135	EROSION SUPERVISOR	EXISTING	PT-1	EXISTING
136	LANDFILL MANAGER	EXISTING	PT-1	EXISTING
137	LANDFILL RECORDS	EXISTING	PT-1	EXISTING
138	ENVIRONMENTAL	EXISTING	PT-1	EXISTING
	MANAGER			
139	OFFICE	EXISTING	PT-1	EXISTING
140	OFFICE	EXISTING	PT-1	EXISTING
141	OFFICE	EXISTING	PT-1	EXISTING
142	OFFICE	EXISTING	PT-1	EXISTING
143	OFFICE	EXISTING	PT-1	EXISTING
144	OFFICE	EXISTING	PT-1	EXISTING
145	OFFICE	EXISTING	PT-1	EXISTING
146	OFFICE	EXISTING	PT-1	EXISTING
147	OFFICE	EXISTING	PT-1	EXISTING
148	OFFICE	EXISTING	PT-1	EXISTING
149	OFFICE	EXISTING	PT-1	EXISTING
150	OFFICE	EXISTING	PT-1	EXISTING
151	OFFICE	EXISTING	PT-1	EXISTING
152	OFFICE	EXISTING	PT-1	EXISTING
153	OFFICE	EXISTING	PT-1	EXISTING
154	OFFICE	EXISTING	PT-1	EXISTING
155	OFFICE	EXISTING	PT-1	EXISTING
156	BREAKOUT	EXISTING	PT-1	EXISTING
157	EXIST. MECH/ELEC	EXISTING	PT-1	EXISTING
158	IT	EXISTING	PT-1	EXISTING
159-C1	CORRIDOR	EXISTING	PT-1	EXISTING
159-C2	CORRIDOR	EXISTING	PT-1	EXISTING
159-C3	CORRIDOR	EXISTING	PT-1	EXISTING



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## FORSYTH COUNTY INSPECTORS/RECYCLE RENOVATION

No.	DATE	DESCRIPTION
	04/02/2020	PERMIT SET
Dra	wn By	Checked By
WR	_	JDG
Dat	е	Job No.

FINISH & **REFERENCE PLAN -**LEVEL 1

Sheet No.

A-1.01

REFLECTED CEILING PLAN

SCALE: 1/8" = 1'-0"

RCP LEGEND 2X2 LAY-IN LIGHT EXIT SIGN W/ EMERGENCY LIGHT KITS 2X4 LAY-IN LIGHT **ACCESS PANEL** (X' - X") CEILING TAG SUPPLY RETURN GYPSUM BOARD CEILING EXIT SIGNAGE (SHADING LINEAR DIFFUSER INDICATES FACE OF SIGN; ARROW SHOWN LAY-IN CEILING GRID INDICATES DIRECTION) **EMERGENCY LIGHT** 

ACOUSTICAL CEILING TILE MFR: ARMSTRONG, BASIS OF DESIGN CORTEGA ANGLED TEGULAR MODEL NO: 704 EDGE: ANGLED TEGULAR SIZE: 2' X 2' X 3/4" COLOR: WHITE GRID: 15/16" PRELUDE

ALTERNATE ADD #3


WHITE

COLOR:

### RCP GENERAL NOTES

- CONSTRUCTION PROFESSIONAL SHALL FIELD VERIFY ALL FIXTURE LOCATIONS. ANY CONFLICT WITH FIELD CONDITIONS. DRAWINGS AND/OR OTHER TRADES SHALL BE REPORTED TO THE ARCITECT IMMEDIATELY UPON DISCOVERY FOR CLARIFICATION PRIOR TO PROCEEDING WITH ASSOCIATED WORK.
- 2. PROVIDE AND INSTALL CEILING TILE, MAIN TEES, CROSS TEES, WALL MOULDINGS AND OTHER ACCESSORIES NECESSARY TO COMPLETE THE SCOPE OF WORK.
- 3. ALL ADJACENT LIGHT SWITCHES SHALL BE GANGED WITH A SINGLE FACE PLATE.
- 4. UNLESS APPROVED BY THE ARCHITECT, ALL THERMOSTATS SHALL BE LOCATED DIRECTLY ADJACENT TO THE LIGHT SWITCH IN THE ROOM IN WHICH IT OCCURS.
- 5. CENTER ALL SPRINNKLER HEADS IN CEILING TILES WHERE POSSIBLE. ALL SPRINKLER HEADS IN GYPSUM BOARD TO BE RECESSED & CONCEALED.
- 6. CENTER ALL LIGHT FIXTURES IN SPACE, U.N.O. ALL RECESSED LIGHT FIXTURES SHALL BE CENTERED IN CEILING TILES WHERE POSSIBLE, U.N.O.
- 7. CONSTRUCTION PROFESSIONAL WILL ENSURE THAT LENSES IN LIGHTING FIXTURES ARE CLEAN AND FREE OF DUST, DIRT AND SMUDGES. PLASTIC AND LABELS SHALL BE REMOVED FROM ALL LIGHT FIXTURES AT PROJECT COMPLETION.
- 8. NO SUBSTITUTES WILL BE ACCEPTED FOR ANY LIGHT FIXTURES UNLESS APPROVED BY ARCHITECT IN WRITING.

	RCP KEY NOTES
NOTE VALUE	DESCRIPTION
R-1	EXISTING 2X4 LIGHTING AND ACT CEILING TO REMAIN IN THIS AREA
R-2	ALTERNATE ADD #3
R-3	NEW CANOPY; SEE DETAIL THIS SHEET
R-4	MATCH EXISTING CEILING HEIGHT

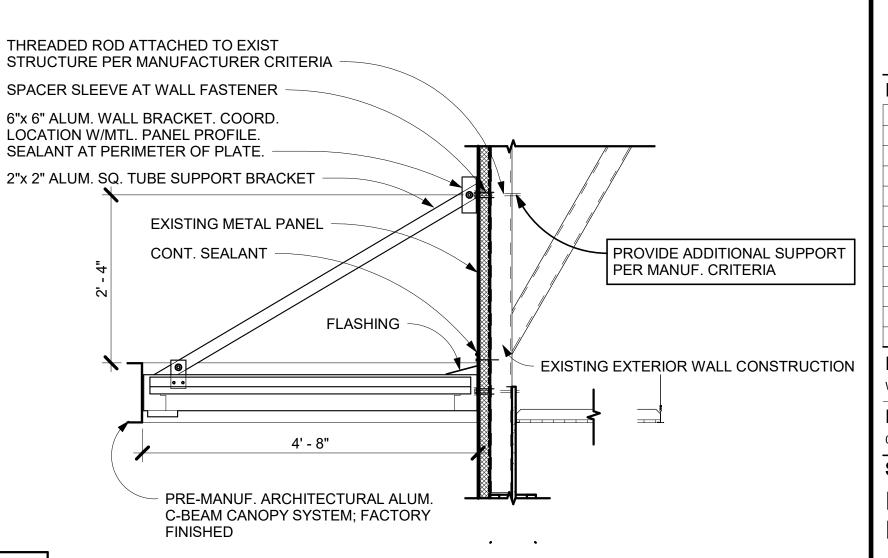

**AWNING DETAIL** 

RCP SHOWN ON THIS DOCUMENT IS FOR GRAPHIC ILLUSTRATION ONLY AND SHALL NOT BE USED AS AN ACCURATE REPRESENTATION OF MECHANICAL, ELECTRICAL AND PLUMBING SCOPE OF WORK. REFERENCE MECHANICAL, ELECTRICAL AND PLUMBING DRAWINGS AND SPECIFICATIONS FOR SCOPE OF WORK.


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REFLECTED CEILING PLAN - LEVEL 1

Sheet No.



2

REPRESENTATIVE. THIS INCLUDES VERTICAL AND HORIZONTAL MOUNTING HEIGHTS OF ALL DEVICES, COORDINATION WITH ARCHITECTURAL, MECHANICAL, ELECTRICAL AND PLUMBING. THE ARCHITECT SHALL RECEIVE SHOP DRAWINGS SHOWING FINALIZED SELECTION OF EQUIPMENT AND SPECIFICA MODEL NUMBERS REVIEWED BY DESIGN TEAM/ENGINEERS PRIOR TO Sheet No. PROCEEDING WITH SCOPE OF WORK.

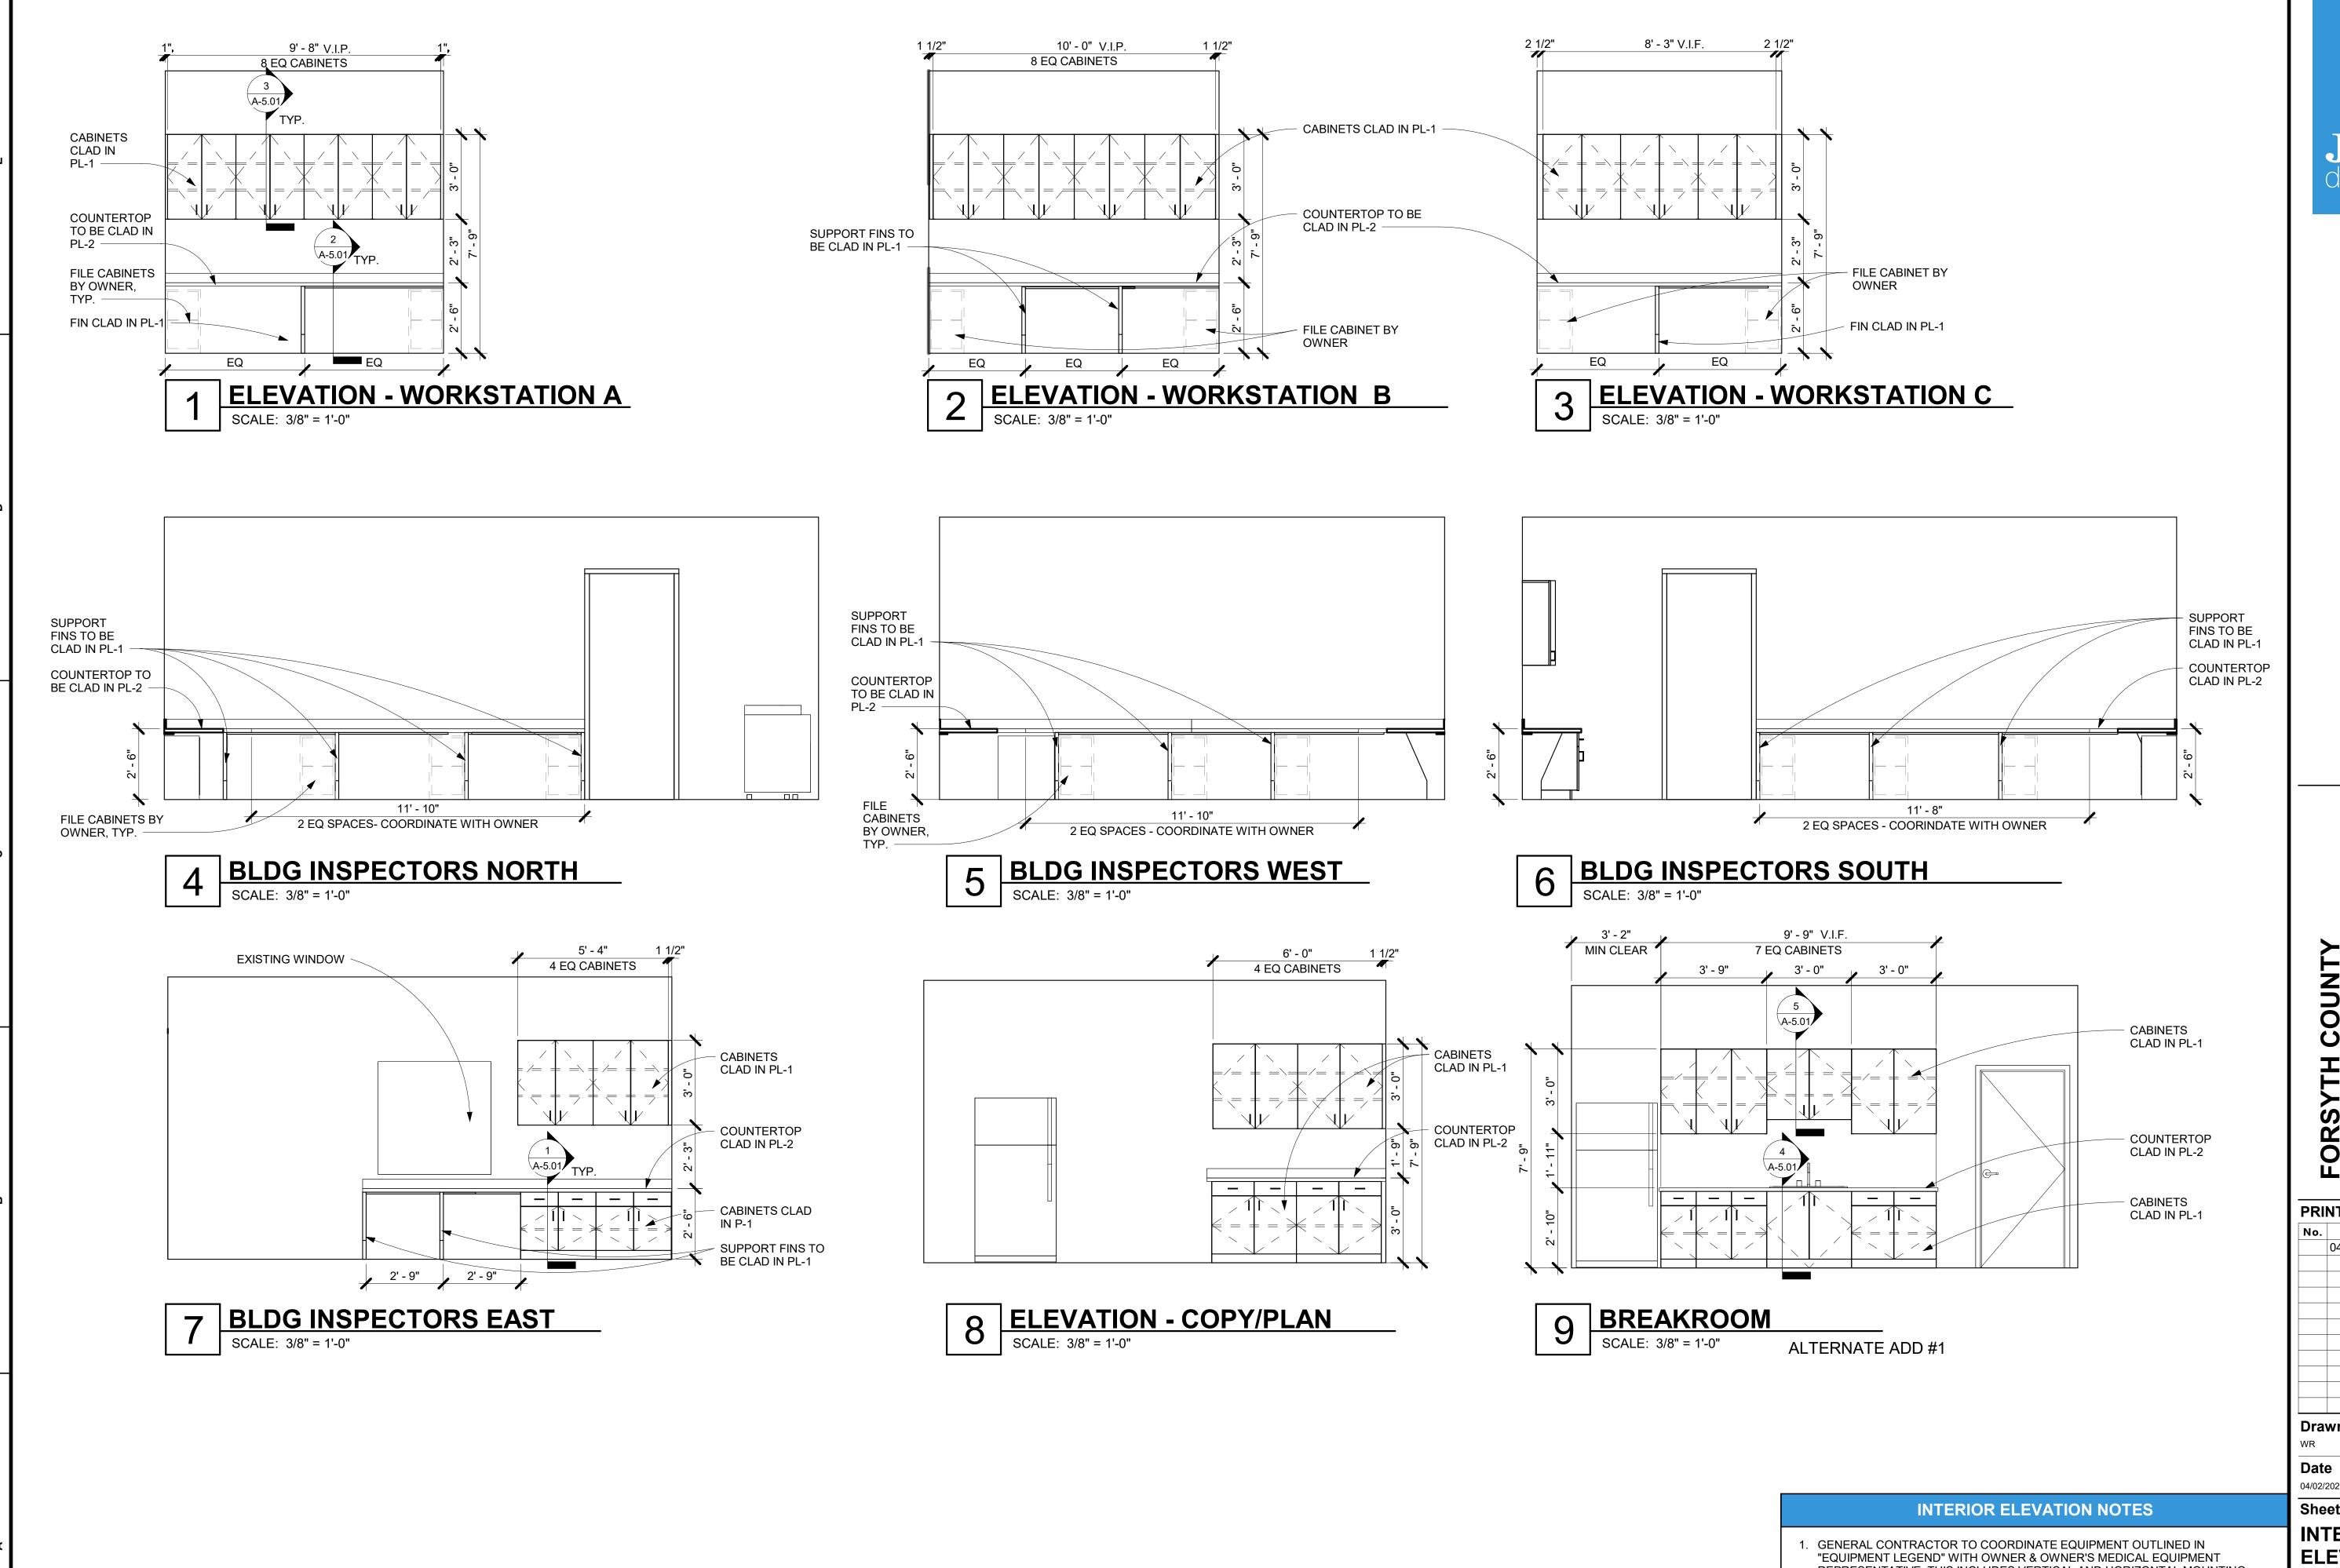- 2. ELECTRICAL OUTLETS ARE ONLY SHOWN FOR COORDINATION WITH EQUIPMENT, SEE ELECTRICAL DRAWINGS FOR MORE INFORMATION..
- 3. LOW VOLTAGE BY OWNE'S REPRESENTATIVE. 4. FURNITURE SHOWN IS TO BE PROVIDED BY OWNER U.N.O. GENERAL CONTRACTOR TO COORDINATE WITH OWNER ON DELIVERY SCHEDULE.

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## FORSYTH COUNTY INSPECTORS/RECYCLE RENOVATION


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**INTERIOR ELEVATIONS** 



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FORSYTH COUNTY INSPECTORS/RECY RENOVATION

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FINISH SCHEDULE & **DETAILS** 

Sheet No.

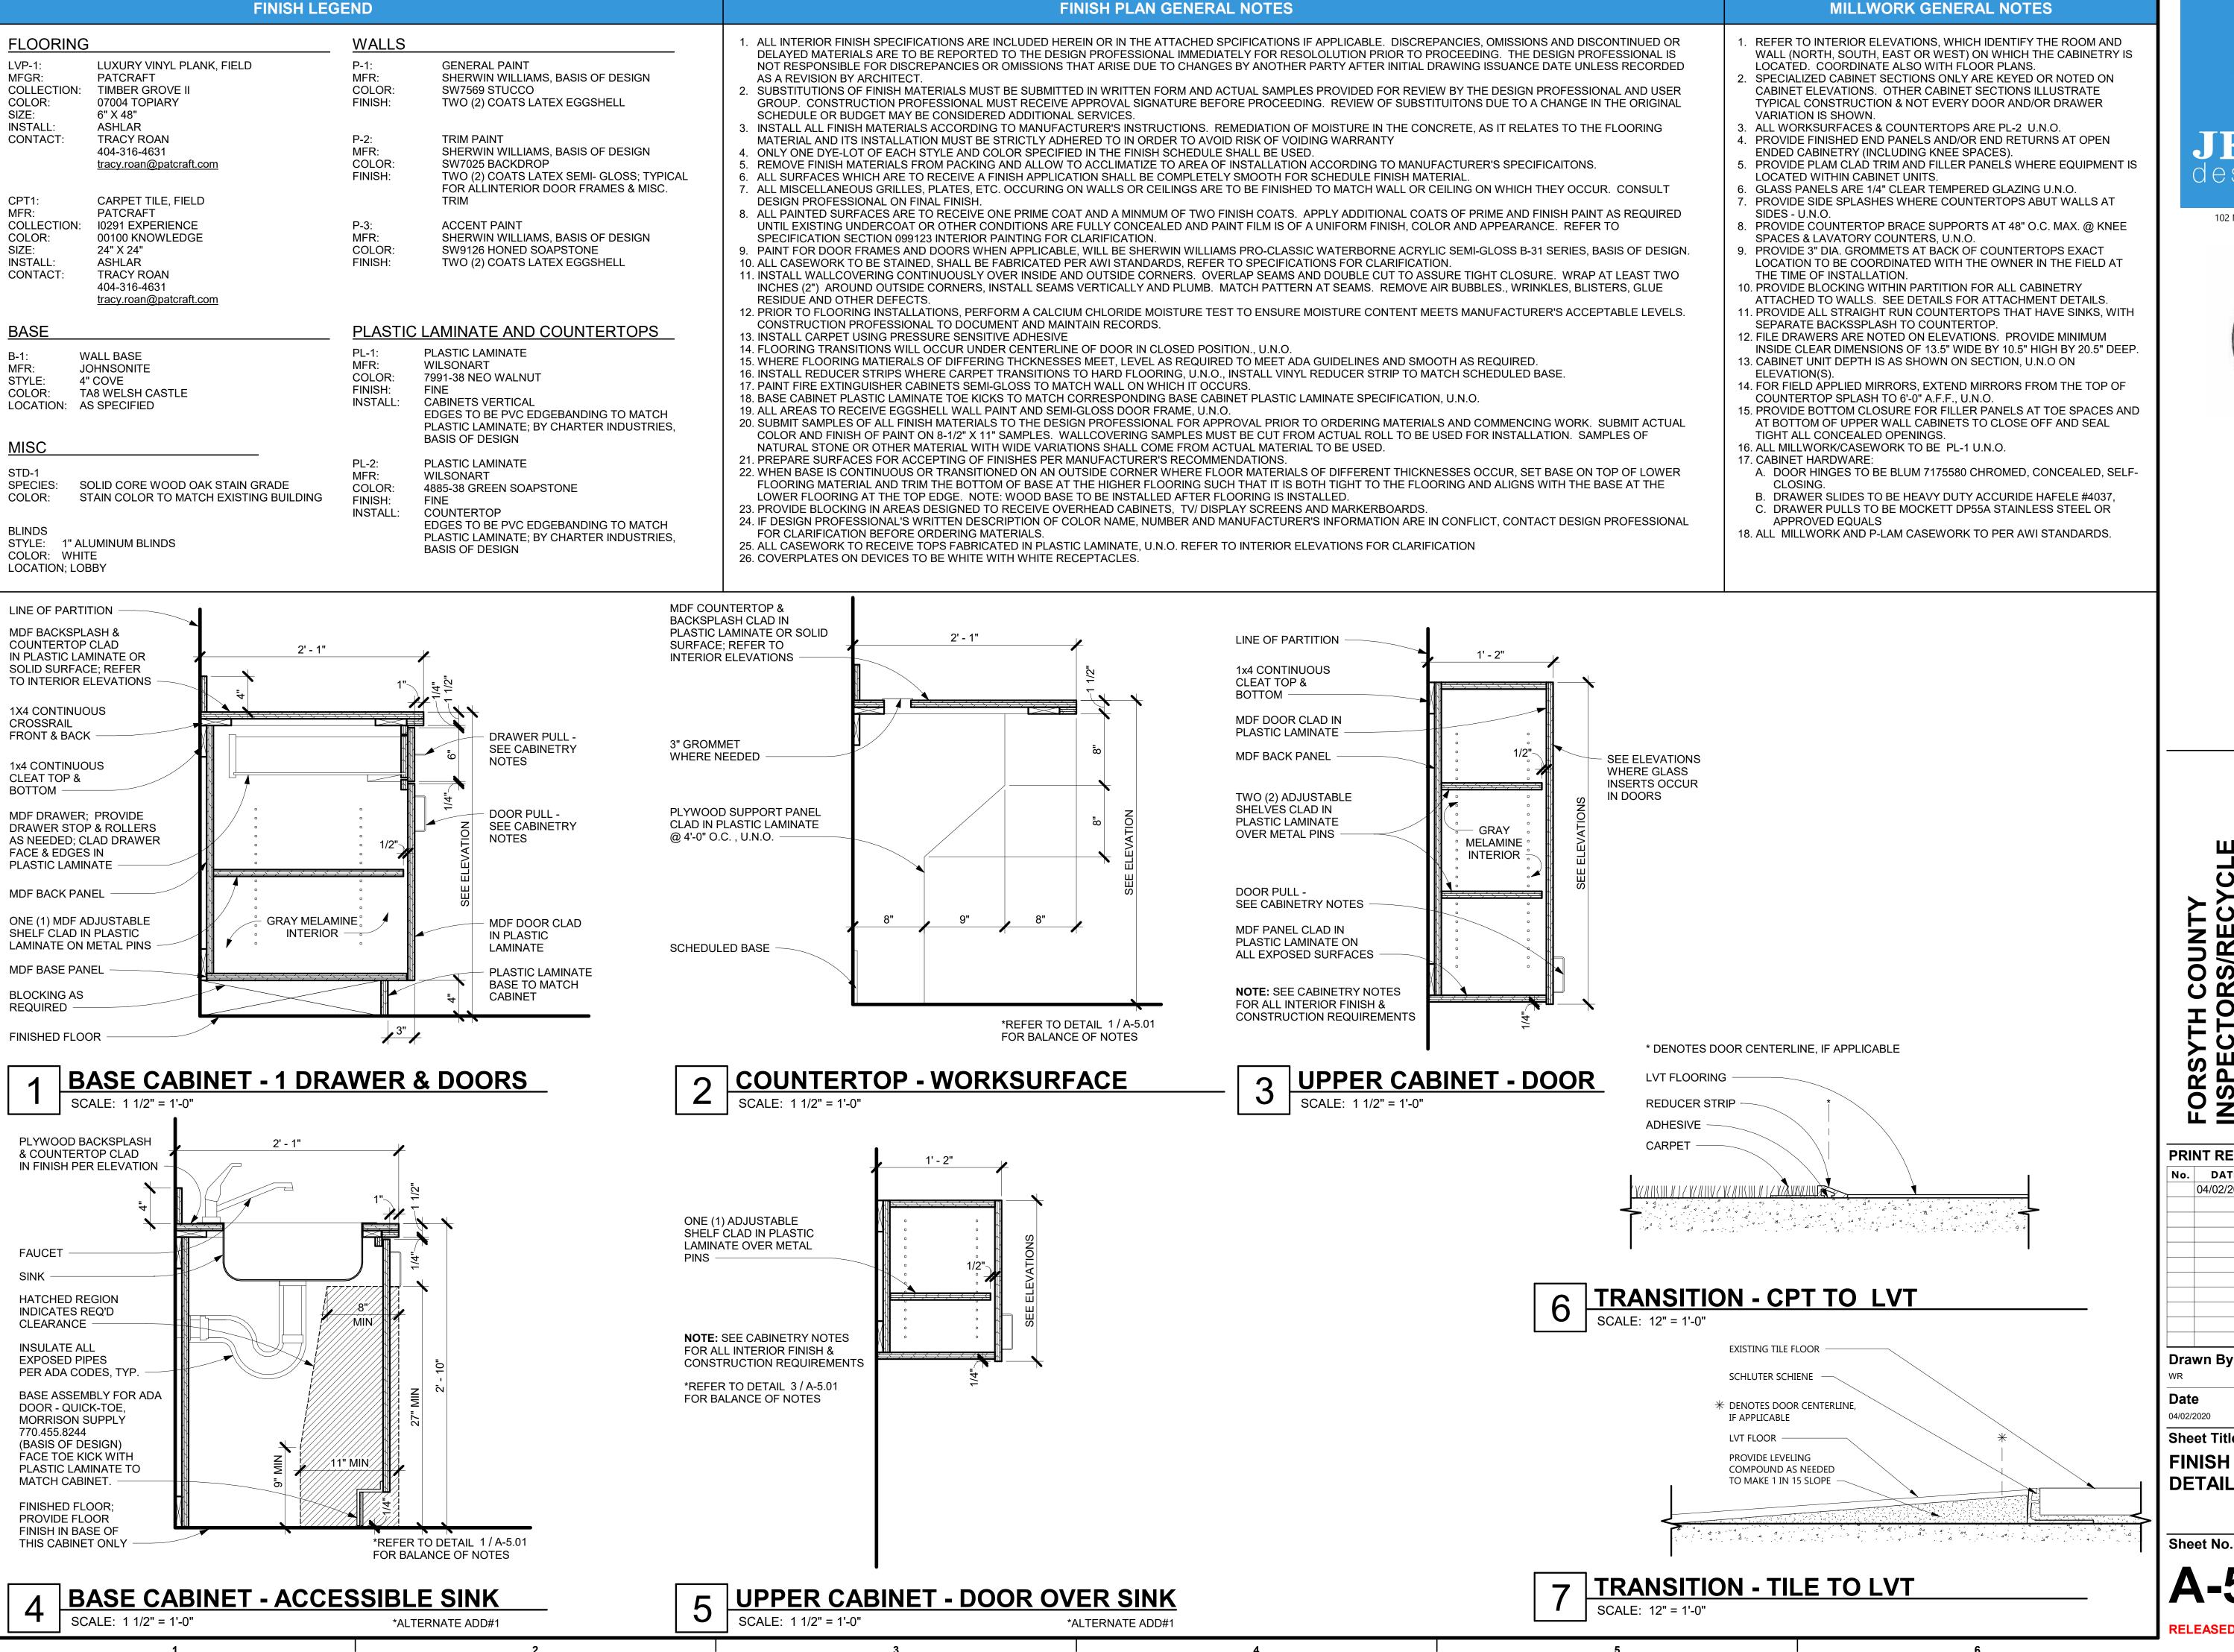



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Job No.

**Sheet Title** 

**FURNITURE, FIXTURE & EQUIPMENT GENERAL NOTES** 

. GENERAL CONTRACTOR TO COORDINATE SCHEDULED ITEMS WITH

OWNER AND OWNER'S EQUIPMENT REPRESENTATIVE. THIS INCLUDES VERTICAL AND HORIZONTAL MOUNTING HEIGHTS OF ALL DEVICES,

COORDINATION WITH ARCHITECTURAL, MECHANICAL, ELECTRICAL AND

REPRESENTATIVE ON DELIVERY SCHEDULE AND INSTALLATION FOR ALL

2 LOW VOLTAGE BY OWNER'S EQUIPMENT REPRESENTATIVE, U.N.O.

4. GENERAL CONTRACTOR TO COORDINATE WITH OWNER/OWNER

3. FURNITURE & EQUIPMENT IS BE PROVIDED BY OWNER.

**FURNITURE & EQUIPMENT PLANS** 

Sheet No.

A-6.01

**RELEASED FOR CONSTRUCTION** 

LANDFILL RECORDS LANDFILL **MANAGER** BLDG INSPECTOR SUPERVISOR 123 CORRIDOR 101-C1 **OFFICE** TV SCREEN LDG INSPECTORS REFRIG. COPIER 139 COLLABORATION 118 **BREAKOUT** 101 119 STORAGE/SUPPLIES OFFICE 156 115 140 CORRIDOR EXIST. MECH/ELEC 101-C2 116 101-C3 OFFICE OFFICE CORRIDOR 141\_\_\_ 152 101-C4 SW SUPERVISOR 155 102 113 OFFICE OFFICE 142 150 SW CONSTR. SW CONSTR. 153 158 INSPECTORS INSPECTORS SW CONSTR. INSPECTORS INSPECTORS INSPECTORS INSPECTORS 107 **INSPECTORS** INSPECTORS 107 104 105 159-C3 108 EXIST. MECH/ELEC **OFFICE** OFFICE 157 154 143 149 CORRIDOR 159-C1 144 OFFICE 148 145 146 147 FURNITURE/EQUIPMENT PLAN

SCALE: 1/8" = 1'-0"

**BLDG INSPECTORS** 

**BLDG INSPECTORS** 

BLDG INSPECTORS

128

BLDG INSPECTORS

127

BLDG INSPECTORS

129

**BLDG INSPECTORS** 

126

BLDG ADMIN

125

**ENVIRONMENTAL** 

MANAGER

138

**EROSION** 

**SUPERVISOR** 

135

**SW SUPERVISOR** 

•

• •

RESTROOM DOOR

3. ALL RESTROOM DOORS TO RECEIVE INT-REST

CORRIDOR DOOR (WOOD OR HM)

1. ALL EXISTING DOORS TO RECEIVE ROOM SIGNAGE PER SPECIFICATIONS

JANITORS CLOSET, TEL DATA

2. ALL DOORS TO RECEIVE NEW PASSAGE LEVER HANDSETS

STORAGE DOOR

INT-ST

NT-COR

INT-ST-LK

NOTES:

SINGLE DOOR F	
DOUBLE DOOR F2	

PORCELAIN.

**GENERAL NOTES** 

\* REFER TO ADA REGULATORY DIAGRAMS FOR MORE INFORMATION

1. SEE GENERAL SPECIFICATIONS FOR DOOR AND FRAME FINISHES.

AND HARDWARE SPECIFICATIONS, NOTIFY THE ARCHITECT OF

THEN TO TYPICAL DOOR DETAILS FOR APPROPRIATE DETAIL.

DISCREPANCIES TO RECEIVE DIRECTION ON HOW TO PROCEED.

5. REFER TO THE PARTITION TYPE OR APPLICABLE WALL SECTION AND

7. ALL EXTERIOR DOORS TO BE WEATHER STRIPPED AND HAVE CLOSERS.

FLOORING TRANSITIONS: WOOD-PORCELAIN, WOOD-CARPET, CARPET-

9. PROVIDE BRASS STOP BAR TRANSITION STRIPS AT THE FOLLOWING

WITH 2010 ADA STANDARDS FOR ACCESSIBLE DESIGN.

6. ALL EXTERIOR HOLLOW METAL DOORS TO BE INSULATED.

4. TIE MAGNETIC LOCK INTO FIRE ALARM.

8. ALL FIRE RATED DOORS TO HAVE CLOSERS

2. ALL DOOR HARDWARE SHALL BE HANDICAP ACCESSIBLE, COMPLYING

3. WHERE DISCREPANCIES OCCUR BETWEEN THE DOOR SCHEDULE NOTES

DOOR ELEVATIONS

SCALE: 1/4"=1'-0"

DOOR MATERIAL TYPE

ALUM - ALUMINUM

**HM - HOLLOW METAL** 

PLAM - PLASTIC LAM CLAD

SCWD - SOLID CORE WOOD

FRAME MATERIAL TYPE

ALUM - ALUMINUM

STL - STEEL

WD - WOOD

HM - HOLLOW METAL

**ABBREVIATIONS LEGEND** 

FINISH TYPE

STD - STAIN

PTD - PAINT

PF - PREFINISHED

**GLAZING TYPE** 

T - CLEAR TEMPERED GLASS


TT - TINTED & TEMPERED GLASS

IT - INSULATED TEMPERED GLASS


FRAME ELEVATIONS

F1

SCALE: 1/4"=1'-0"

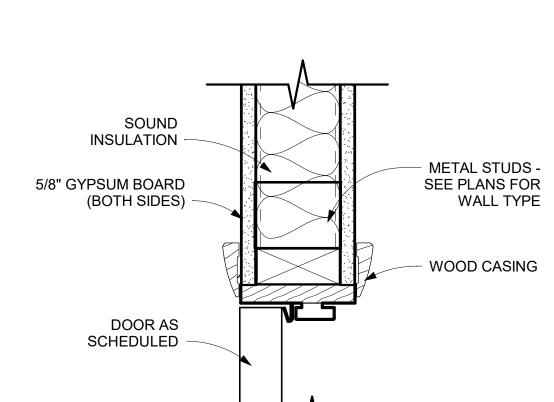

**WD HEADER DETAIL** SCALE: 3" = 1'-0"

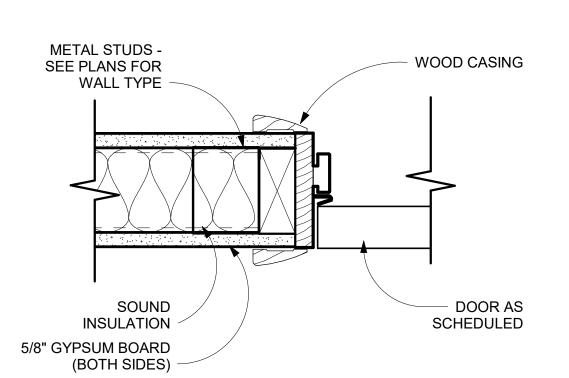

**WD JAMB DETAIL** SCALE: 3" = 1'-0"

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A-7.01

DOOR SCHEDULE

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SOUND
INSULATION —
5/8" GYPSUM BOARD (BOTH SIDES)
(BOTTI SIDES)

		CAPACITY	APACITY (BTU/HR) INDOOR FAN DATA		OUTDOOR UNIT ELECTRICAL DATA						
ID TAG SERVICE	SUPPLY	COOLING	HEATING	VOLT./PH	MCA	VOLT./PH	MCA	MOCP	BA9IS OF DESIGN	NOTES	
D99-1/CU-1	IT ROOM	425	12,000			_	208/1	13	15	MITSUBISHI: PKA/PUY	1234

4: PROVIDE WITH EXTERNAL (120V) CONDENSATE PUMP.

						F,	AN SCH	EDUL			
TAG	LOCATION	CAPACITY (CFM)	ESP (IN WG)	MOTOR (W)	DRIVE	<b>νοL</b> Τ/Φ	MAX FAN RPM	MAX SONES	TYPE OF FAN	BASIS OF DESIGN	NOTES
EF-1	BATHROOM	10	0.25	13	DIRECT	120/1	862	0.4	CEILING EXHAUST FAN	GREENHECK: SP	1 2 3
EF-2	BATHROOM	140	0.25	23	DIRECT	120/1	696	1.2	CEILING EXHAUST FAN	GREENHECK: 9P	1 2 3

1: DISCONNECT PROVIDED BY ELECTRICAL CONTRACTOR.
2: PROVIDE WITH BACKDRAFT DAMPER.
3: INTERLOCK WITH LIGHT SWITICH

			ROOF HOC	D SCHED		
TAG	CAPACITY (CFM)	SERVICE	MAX PRESS. DROP (IN W.C.)	THROAT SIZE	BASIS OF DESIGN	NOTES
RH-1	210	RELIEF	0.04	8"Ф	GREENHECK: GRSR	1 2

LEGEND - MECHANICAL/ELECTRICAL						
<u>ABBR</u>	SYMBOL	<u>DESCRIPTION</u>				
А		AMP6				
FLA		FULL LOAD AMPS				
ΗZ		HERTZ				
KVA		KILOVOLT AMPS				
KW		KILOWATT				
MCA		MINIMUM CIRCUIT AMPACITY				
MOCP		MAXIMUM OVERCURRENT PROTECTION				
PH	Ф	PHASE				
Y		VOLT/VOLTAGE				
W		WATTS				

	LE	GEND - MECHANICAL/PLUMBING
SYMBOLS	ABBRV.	<u>DESCRIPTION</u>
<u>P-1</u>		PLUMBING FIXTURE DESIGNATION
•		CONNECT TO EXISTING
lacksquare		LIMITS OF DEMOLITION
1		REFER TO KEYNOTES
У		DUCTWORK - NEW
		DUCT - RETURN OR EXHAUST UP
	EA	EXHAUST AIR
	×	EXISTING
Z TYPE		CEILING RETURN AIR REGISTER / GRILLE OR EXHAUST REGISTER / GRILLE
CW		COLD WATER
HW		HOT WATER
ADA		AMERICANS WITH DISABILITIES ACT
ESP		ExTERNAL STATIC PRESSURE
IN		INCHE9
WG		WATER COLUMN
W		WASTE
RPM		ROTATIONS PER MINUTE
MAX		MAXIMUM
CFM		CUBIC FEET PER MINUTE
A.F.G		ABOVE FINISHED GRADE
CD		CONDENSATE



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### SPECTORS/RECYCL SNOVATION RSYTH COUNTY

PERMIT SET

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 Job

 04/02/2020
 20007

Sheet Title

LEGENDS, SCHEDULES, DETAILS & SPECS -HVAC & PLUMBING

Sheet No.

MP-0-00

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### MECHANICAL AND PLUMBING GENERAL NOTES

- ALL WORK SHALL COMPLY WITH ALL LOCAL BUILDING CODES, LAWS, REGULATIONS, ORDINANCES, SMACNA STANDARDS, AND ASHRAE GUIDELINES.
- THE WORK SHALL CONSIST OF ALL LABOR AND MATERIAL TO COMPLETELY INSTALL ALL WORKS AS SHOWN ON THESE DRAWINGS.

NECESSARY, AS DIRECTED BY THE ARCHITECT/ENGINEER.

- COORDINATE LOCATION OF PIPE ROUTING, DUCTWORK AND DIFFUSERS WITH LIGHT FIXTURES WITH ELECTRICAL CONTRACTOR. RELOCATE PIPING \$/OR DUCTWORK, IF
- ALL WORK ASSOCIATED WITH THE SCOPE OF THIS PROJECT INCLUDING EQUIPMENT, ACCESSORIES, DEVICES, SYSTEMS, ETC. SHALL BE COVERED BY A ONE YEAR GUARANTEE WHICH SHALL START AT THE TIME OF FINAL ACCEPTANCE BY THE OWNER ANY DEFECTS IN PRODUCTS, INSTALLATION, WORKMANSHIP SHALL BE CORRECTED AT NO ADDITIONAL CHARGE AND SHALL INCLUDE ANY NECESSARY REPAIRS TO WALLS, FLOORS, MILLWORK, ETC. WHICH SHALL BE REPAIRED BACK TO NEW AND FINISHED
- THE CONTRACTOR SHALL KEEP A RECORD OF THE CHANGES WHICH ARE IN CONFLICT WITH THESE DRAWINGS AND SPECIFICATIONS. AT THE COMPLETION OF THIS WORK THE CONTRACTOR SHALL SUBMIT "AS BUILT" PRINTS TO THE OWNER.
- THE DRAWINGS ARE DIAGRAMMATIC AND DO NOT NECESSARILY SHOW THE EXACT ROUTING OR DETAILED FITTINGS. ALL WORK SHALL BE INSTALLED AS A COMPLETE SYSTEM WITH NECESSARY COMPONENTS, FITTINGS, STRAPS, ETC. ALL DAMPERS AND VALVES SHALL BE INSTALLED SO THAT THEY ARE ACCESSIBLE.
- REFER TO THE ENTIRE CONTRACT DRAWING SET AND SPECIFICATIONS FOR GUIDANCE ON DIMENSIONS, CEILING HEIGHTS, DOOR SWINGS, ROOM FINISHES, STRUCTURAL DETAILS, LOCATIONS OF DUCTWORK, PIPING AND STRUCTURAL MEMBERS. INSTALL THE MECHANICAL SYSTEMS SO AS NOT TO INTERFERE WITH THE INSTALLATION OR FUNCTION OF ANOTHER DISCIPLINES WORK.
- ALL DUCT AND PIPING MUST BE CONCEALED ABOVE THE CEILING OR IN THE WALLS
- COORDINATE DIFFUSER LOCATIONS WITH ARCHITECTURAL REFLECTED CEILING PLAN
- COORDINATE VALVE LOCATIONS WITH ARCHITECTURAL REFLECTED CEILING PLAN TO MAKE CERTAIN NONE ARE INSTALLED OVER GYPSUM BOARD CEILINGS.

TO VERIFY FRAME TYPES BASED ON CEILING TYPE.

- THE CONTRACTOR SHALL INSTALL ALL WORK IN A NEAT AND WORKMANLIKE MANNER AND ACCORDING TO GENERALLY ACCEPTED PRACTICES OF FIRST CLASS
- ALL DIMENSIONS OF EXISTING CONSTRUCTION ARE APPROXIMATE. THE CONTRACTORS SHALL MAKE ALL NECESSARY FIELD MEASUREMENTS OF EXISTING STRUCTURES, AND EQUIPMENT TO VERIFY DIMENSIONS SHOWN ON THE DRAWINGS. PROVIDE PROPER DIMENSIONS NOT SHOWN PRIOR TO EQUIPMENT FABRICATION. ALL COST FOR MODIFICATIONS OF NEW CONSTRUCTION DUE TO LACK OF CONFIRMATION OF DIMENSIONS BY FIELD MEASUREMENT SHALL BE THE RESPONSIBILITY OF THE MECHANICAL CONTRACTOR.
- ALL PIPING, DUCTWORK, INSULATION, CONSTRUCTION STANDARDS, ETC. MUST BE EQUAL TO OR GREATER THAN EXISTING BUILDING STANDARDS. THE USE OF RIGID FIBER DUCT BOARD AND PYC IS NOT PERMITTED.
- LANDLORD SHALL HAVE FIRST REFUSAL FOR EXISTING EQUIPMENT AND MATERIALS SHOWN OR LISTED TO BE REMOVED FROM THE PROPERTY. EQUIPMENT AND MATERIALS SHALL BECOME PROPERTY OF THE CONTRACTOR AND REMOVED FROM THE SITE IF NOT ACCEPTED BY THE LANDLORD.
- CONTRACTOR SHALL PROVIDE MANUAL VOLUME DAMPER AT SUPPLY AND/OR RETURN AIR TAKE-OFFS IF NONE EXIST TO PROPERLY BALANCE SYSTEMS WITHIN THE
- CONTRACTOR SHALL CLEAN AND/OR PAINT EXISTING AIR DISTRIBUTION DEVICES TO

### MECHANICAL (HYAC & PLUMBING) SPECIFICATIONS A. GENERAL CONDITIONS OTHER CONTRACT DOCUMENTS

THE GENERAL CONDITIONS AND OTHER CONTRACT DOCUMENTS AS SET FORTH HEREBY ARE TO BE INCORPORATED INTO AND BECOME A PART OF THE SPECIFICATIONS FOR THE WORK UNDER THIS DIVISION.

- B. CODES AND PERMITS COMPLY WITH ALL RULES, REGULATIONS OF STATE, COUNTY, AND CITY AUTHORITIES HAVING JURISDICTION OVER THE PREMISES, INCLUDING SAFETY REQUIREMENTS OF OSHA. DO NOT CONSTRUE THIS AS RELIEVING CONTRACTOR FROM COMPLYING WITH SPECIFICATIONS WHICH EXCEED CODE
  - SECURE AND PAY FOR ALL PERMITS AND CERTIFICATES OF INSPECTION

REQUIREMENTS AND NOT IN CONFLICT THEREWITH.

### C. LOCAL CONDITIONS:

- THE CONTRACTOR SHALL VISIT THE SITE PRIOR TO BID AND BE FAMILIAR WITH ALL EXISTING CONDITIONS. SPECIAL ATTENTION SHALL BE GIVEN TO WORK TO BE PERFORMED ABOVE AN EXISTING CEILING. NO ALLOWANCE WILL BE MADE FOR LACK OF KNOWLEDGE OF EXISTING CONDITIONS.
- THIS CONTRACTOR SHALL BE HELD TO HAVE EXAMINED THE PREMISES AND SITE SO AS TO COMPARE THEM WITH THE DRAWINGS AND SPECIFICATIONS. NO ALLOWANCE SHALL BE MADE TO THE CONTRACTOR BY REASON OF HIS FAILURE TO HAVE MADE SUCH EXAMINATION OR OF ANY ERROR ON HIS PART.
- WHERE EXISTING SLABS ARE TO BE CUT OR CORE DRILLED, THE CONTRACTOR SHALL X-RAY THE EXISTING SLABS TO AVOID CUTTING OR DISRUPTING EXISTING CONDUITS, CABLES, PLUMBING OR STRUCTURAL
- HVAC SYSTEMS, PLUMBING SYSTEMS, AND ELECTRICAL SERVICE TO THE BUILDING SHALL NOT BE INTERRUPTED WITHOUT WRITTEN CONSENT OF THE BUILDING OWNER.
- AT THE COMPLETION OF THE PROJECT, ALL WORK UNDER THIS DIVISION SHALL BE COMPLETELY INTEGRATED WITH THE EXISTING SYSTEMS AND LEFT IN PERFECT OPERATING CONDITION.
- PRIOR TO ANY DEMOLITION OR CONSTRUCTION THE CONTRACTOR SHALL HAVE THE EXISTING CONDITIONS INSPECTED BY AN EPA, OSHA CERTIFIED ASBESTOS ABATEMENT AGENCY TO IDENTIFY THE PRESENCE OF ASBESTOS. SHOULD ANY ASBESTOS BE FOUND IT SHALL BE BROUGHT TO THE IMMEDIATE ATTENTION OF THE ARCHITECT AND OWNER AND SPECIFICALLY IDENTIFIED IN

### D. DRAWINGS

- DRAWINGS AND SPECIFICATIONS ARE TO BE CONSIDERED AS SUPPLEMENTING EACH OTHER. WORK SPECIFIED SHALL BE PERFORMED OR FURNISHED AS THOUGH MENTIONED IN BOTH SPECIFICATIONS AND DRAWINGS.
- THE DRAWINGS ARE SCHEMATIC ONLY AND ARE INTENDED TO SHOW APPROXIMATE LOCATIONS. DO NOT SCALE.

### E. SHOP DRAWINGS/SUBMITTALS

- THIS CONTRACTOR SHALL SUBMIT SHOP DRAWINGS ON THE ITEMS OF EQUIPMENT AND SYSTEMS AS NECESSARY TO CLEARLY SHOW EQUIPMENT AND CONSTRUCTION.
- THE GENERAL CONTRACTOR SHALL REVEW, COMMENT AND STAMP THE SHOP DRAWINGS/SUBMITTALS PRIOR TO THE ENGINEER REVIEW.

### F. SUPERVISION

THIS CONTRACTOR SHALL HAVE IN CHARGE OF THE WORK, A COMPETENT SUPERINTENDENT WITH EXPERIENCE IN THE WORK TO BE INSTALLED UNDER THIS CONTRACT.

### G. COORDINATION

- THIS CONTRACTOR SHALL COORDINATE HIS WORK AND COOPERATE WITH THE OTHER CONTRACTORS. HE SHALL ARRANGE HIS WORK WITH THEIRS SO THAT THERE WILL BE NO DELAY IN THE PROPER INSTALLATION.
- EXAMINE WORK OF OTHER TRADES WHICH COMES IN CONTACT WITH OR IS COVERED BY THIS WORK. DO NOT ATTACH TO, COVER, OR FINISH AGAINST ANY DEFECTIVE WORK, OR INSTALL WORK OF THIS DIVISION IN A MANNER WHICH WILL PREVENT OTHER TRADES FROM PROPERLY INSTALLING THEIR WORK. CONSULT ALL DRAWINGS, SPECIFICATIONS AND DETAILS OF OTHER DIVISIONS OF THE WORK.

### H. CUTTING AND PATCHING

ALL CUTTING AND PATCHING WORK RELATED TO THIS CONTRACT WILL BE THE RESPONSIBILITY OF THIS CONTRACTOR REPAIRS SHALL MATCH NEW AND/OR EXISTING CONDITIONS.

### I. GUARANTEE AND WARRANTIES

- CONTRACTOR SHALL WARRANT THAT EQUIPMENT AND ALL WORK IS INSTALLED IN ACCORDANCE WITH GOOD ENGINEERING PRACTICE AND THAT ALL EQUIPMENT WILL MEET REQUIREMENTS SPECIFIED. ANY EQUIPMENT FAILING TO PERFORM OR FUNCTION AS SPECIFIED SHALL BE REPLACED WITH COMPLYING EQUIPMENT, WITHOUT COST TO THE OWNER.
- GUARANTEE AGAINST DEFECTS IN WORKMANSHIP AND MATERIALS. MAKE GOOD REPAIR OR REPLACE ANY DEFECTIVE WORK, MATERIAL OR EQUIPMENT WITHIN (I) ONE YEAR FROM DATE OF ACCEPTANCE.

### J. INSTALLATION REQUIREMENTS

LOCATIONS OF PIPING, EQUIPMENT, DUCTS, ETC., ON THE DRAWINGS IS DIAGRAMMATIC. INDICATED POSITIONS SHALL BE FOLLOWED AS CLOSELY AS POSSIBLE. EXACT LOCATIONS SHALL BE SUBJECT TO BUILDING CONSTRUCTION AND INTERFERENCES WITH OTHER WORK. ARCHITECT RESERVES THE RIGHT TO MAKE MINOR CHANGES IN LOCATION OF ANY PART OF THE WORK UP TO THE TIME OF ROUGHING-IN WITHOUT ADDITIONAL

### K. TEST AND ADJUSTMENTS

- OBTAIN ALL INSPECTIONS REQUIRED BY LAW, ORDINANCES, RULES, REGULATIONS OF AUTHORITIES HAVING JURISDICTION, FURNISH CERTIFICATES OF SUCH INSPECTIONS. PAY ALL FEES AND PROVIDE ALL EQUIPMENT. POWER AND LABOR NECESSARY FOR INSPECTIONS AND TEST.
- A. ALL PIPING SHALL BE GIVEN THE FOLLOWING PRESSURE TEST WITHOUT APPRECIABLE PRESSURE DROP. EQUIPMENT WHICH WOULD BE DAMAGED BY THE REQUIRED TEST PRESSURE SHALL BE ISOLATED FROM THE SYSTEM DURING TESTING.

### MEDIUM (PSI) HRS. DOMESTIC WATER WATER 125 B. SANITARY SEWERS PER STATE PLUMBING CODE AND LOCAL AUTHORITY.

### L. INSULATION

- ALL INSULATION SHALL BE INSTALLED OVER CLEAN DRY SURFACES. INSULATION MUST BE DRY AND IN GOOD CONDITION. WET OR DAMAGED INSULATION WILL NOT BE ACCEPTABLE. NO INSULATION SHALL BE APPLIED PRIOR TO PRESSURE TEST COMPLETION OF THE RESPECTIVE PIPING SYSTEMS. INSTALLATION SHALL BE
- FIBERGLASS PIPE INSULATION SHALL BE INSTALLED WITH JOINTS BUTTED FIRMLY TOGETHER, JACKET LAPS TO BE SEALED WITH FACTORY APPLIED ADHESIVE, BUTT JOINTS TO BE SEALED WITH BUTT STRIPS, HAVING FACTORY APPLIED ADHESIVE YALYES AND FITTINGS SHALL BE INSULATED USING MITERED SECTIONS OF INSULATION, INSULATION CEMENT, OR PRE-MOLDED FITTING INSULATION. THE INSULATION APPLIED TO THE VALVES, FITTINGS AND THROUGH HANGERS SHALL BE COVERED WITH THE SAME TYPE OF COVERING AS USED ON THE PIPE INSULATION. PIPE SHIELDS TO BE PROVIDED AT ALL SUPPORTS.
- PROVIDE THE FOLLOWING INSULATION PRODUCTS AS MANUFACTURED BY OWENS-CORNING. INSULATION PRODUCTS AS MANUFACTURED BY ARMSTRONG, CERTAINTEED OR KNAUF ARE ACCEPTABLE. ADHESIVE SHALL BE BENJAMIN FOSTER OR EQUAL.
- DOMESTIC HOT WATER: 1" THICK ASJ/SSL FIBERGLASS FOR PIPE SIZES 1-1/4" OR 9MALLER, 1-1/2" THICKA9J/99L FIBERGLASS FOR PIPE 9IZES 1-1/2" ♥ GREATER. DOMESTIC COLD WATER: 1" THICK ASJ/SSL FIBERGLASS.
- REFRIGERANT PIPING: 1" THICK ASJ/SSL FIBERGLASS. 4.4. ALL INSULATION SHALL MEET 25/50 FLAME AND SMOKE SPREAD RATING FOR PLENUM APPLICATIONS.
- EXISTING \$ NEW PVC OR NON-COMPLIANT PLENUM RATED MATERIALS
- SHALL BE WRAPPED WITH 3M FIRE BARRIER OR EQUIVALENT PRODUCT OR CONSTRUCTED WITH PLENUM COMPLIANT MATERIALS.

### M. DUCTWORK

- ALL DUCTWORK SHALL BE CONSTRUCTED AND INSTALLED IN COMPLIANCE WITH SMACNA HVAC DUCT CONSTRUCTION STANDARDS (2005 ED. OR
- 2. NEW DUCTWORK SHALL BE CONSTRUCTED OF GALVANIZED SHEET METAL AND INSTALLED AS SHOWN ON THE DRAWINGS. ALL SHEETMETAL DUCT JOINTS \$ SEAMS (MINIMUM SEAL CLASS B) SHALL BE SEALED WITH TAPES AND MASTICS AS LISTED IN UL STANDARDS 181A AND 181B.
- 3. DUCT SIZES INDICATED ON PLANS ARE FREE INSIDE CLEAR DIMENSIONS UNLESS OTHERWISE NOTED
- LEAKAGE RATE ALLOWANCE SHALL BE THE LESSER OF SMACNA CLASS B LEAKAGE CALCULATION OR 5% OF SYSTEM CFM.
- 5. ELBOWS 45 DEGREES \$ GREATER IN ALL DUCT SYSTEMS MUST BE EITHER
- FULL-RADIUS OR MITERED WITH TURNING VANES. 5.1. INSTALL TURNING YANES FOR ALL RECTANGULAR MITERED ELBOWS. 5.2. FOR DUCTS WITH VELOCITIES LESS THAN 2,200 FPM PROVIDE SINGLE WALL

### O. MATERIALS

- PIPE AND FITTINGS DOMESTIC WATER TYPE "L" HARD COPPER.
- CONDENSATE PIPING TYPE "M" OR DWY COPPER TUBING, NO-HUB CAST IRON, OR PYC (EXCEPT IN RETURN AIR PLENUMS).
- WASTE \$ VENT PIPING (ABOVE GROUND INTERIOR) NO-HUB CAST IRON BUILDING SEWERS \$ DRAINS (UNDERGROUND): SANITARY SEWERS SHALL BE SERVICE WEIGHT CAST IRON, BELL \$ SPIGOT, SOIL PIPE WITH TYLER "TY-SEAL" NEOPRENE PIPE
- REFRIGERANT PIPING SEAMLESS COPPER TUBE, HARD DRAWN, ASTM B15, TYPE K OR L B88. FITTINGS SHALL BE WROUGHT COPPER OR WROUGHT BRONZE WITH

### P. WASTE SYSTEMS

- RUN ALL DRAINAGE PIPING AS DIRECT AS POSSIBLE. ACTUAL LOCATION OF DRAINS AND WASTE PIPING SHALL MEET THE VARIOUS BUILDING CONDITIONS. DO ANY WORK NECESSARY TO CONCEAL PIPING OR CLEAR PIPING OF OTHER TRADES.
- WASTE PIPING SHALL BE SLOPED AT A MINIMUM OF 1/4" PER FOOT FOR PIPE SIZES 2-1/2" OR LESS, 1/8" PER FOOT FOR PIPE SIZES 3" TO 6" AND 1/16" PER FOOT FOR PIPE SIZES 8"
- CONDENSATE PIPING SHALL BE SLOPED AT A MINIMUM OF 1/8" PER FOOT.

### Q. PIPING HANGER SPACING

SPACING

- INSTALL HANGERS AND SUPPORTS IN PIPING SYSTEMS TO REMOVE STRESS FROM SYSTEM. SPACE HANGERS AND SUPPORTS PER THE FOLLOWING TABLES: 1.1. COPPER PIPE: 1-1/4" OR SMALLER - 6' MAXIMUM SPACING  $\P$  1-1/2" OR LARGER - 10' 1.2.CAST IRON PIPE: ALL SIZES - 5' MAXIMUM SPACING (SPACING OF 10' MAY BE USED WHEN
- 10' PIPE LENGTH ARE UTILIZED. 1.3. PVC PIPE: ALL SIZES - 4' MAXIMUM SPACING 1.4. CPVC PIPE: 1" OR SMALLER - 3" MAXIMUM SPACING \$ 1-1/4" OR LARGER - 4" MAXIMUM

### R. VALVES

VALVES IN WATER PIPING: BALL VALVES WITH SCREWED ENDS, MIN. 150 LBS., SWP. VALVES USED FOR SHUT-OFF AND BALANCING SHALL BE EQUIPPED WITH MEMORY STOP.

### S. WIRING

- ALL WIRING INCIDENTAL TO THIS TEMPERATURE CONTROL SYSTEM SHALL BE PROVIDED BY THE MECHANICAL CONTRACTOR.
- THE TERM "WIRING" SHALL BE CONSTRUED TO INCLUDE FURNISHING OF WIRE, CONDUIT, MISCELLANEOUS MATERIALS AND LABOR AS REQUIRED FOR MOUNTING AND CONNECTING ELECTRICAL CONTROL DEVICES, AND CONNECTING ELECTRICAL DEVICES, AND PROVIDING ELECTRICAL INTERLOCKS BETWEEN EQUIPMENT.

### T. EQUIPMENT

SEE SCHEDULES ON DRAWING.

- THE BASIS OF DESIGN INDICATED ON ALL SCHEDULES CONTAINED ON THESE DRAWING INDICATES MINIMUM QUALITY AND CONSTRUCTION STANDARDS. ALTERNATE MANUFACTURERS EQUIPMENT MAY BE USED SO LONG AS THE EQUIPMENT / DEVICE MEETS OR EXCEEDS THE QUALITY OF THE BASIS OF DESIGN. CONTRACTOR SHALL BE RESPONSIBLE FOR COORDINATING SPACE REQUIREMENTS FOR ALTERNATE EQUIPMENT.
- WHERE A PRODUCT IS SUBSTITUTED FOR A "BASIS OF DESIGN" PRODUCT, THE CONTRACTOR SHALL NOTIFY THE DESIGN TEAM THAT CHANGES IN PROJECT MAY BE MANDATORY IN ORDER TO PERMIT THE USE AND THE INSTALLATION OF THE SUBSTITUED PRODUCT. SHOP DRAWING SUBMITTALS FOR A SUBSTUTE PRODUCT SHALL INCLUDE A COMPLETE SCHEDULE OF CHANGES IN PROJECT DESIGN, IF ANY, WHICH MUST BE MADE IN ORDER TO PERMIT USE AND INSTALLATION OF THE SUBSTITUTED PRODUCT. THE CONTRACTOR SHALL BE RESPONSIBLE FOR THE COORDINATION OF ALL TRADES FOR USE OF THE SUBSTITUTED PRODUCT. THE CONTRACTOR SHALL BEAR ALL EXPENSES RELATED TO THE USE OF A SUBSTITUE



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**SPECIFICATIONS - HVAC** & PLUMBING

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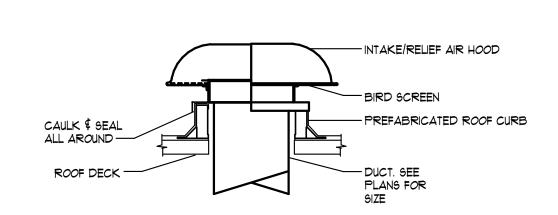
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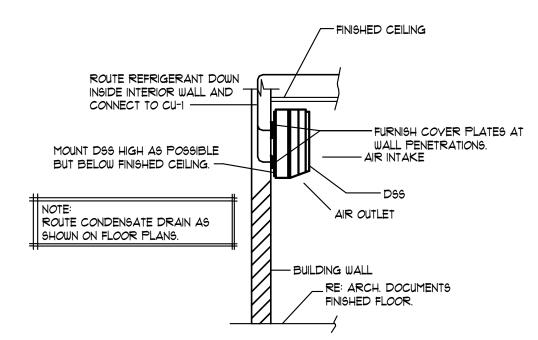
**Sheet Title** 

— MOUNT FAN FROM STRUCTURE ABOVE WITH METAL STRAPS \$ VIBRATION ISOLATION FLEXIBLE CONNECTION -SEE PLANS FOR CONTINUATION — CEILING EXHAUST REGISTER


### CEILING EXHAUST FAN DETAIL NOT TO SCALE



### RELIEF AIR HOOD DETAIL NOT TO SCALE



### 3 DUCTLESS SPLIT WALL INSTALLATION NOT TO SCALE

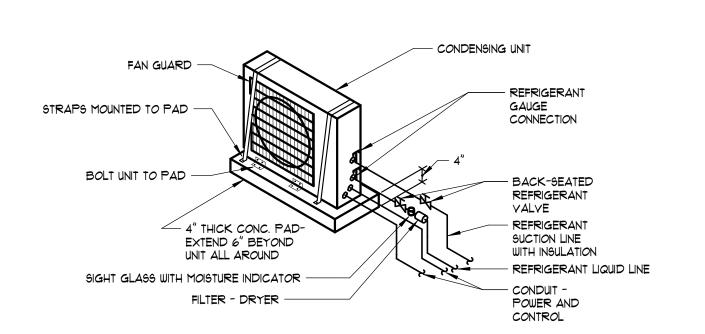

### NOTE: PROVIDE REFRIGERANT ACCESSORIES AS REQUIRED BY MANUFACTURER'S LITERATURE AND RECOMMENDATIONS.

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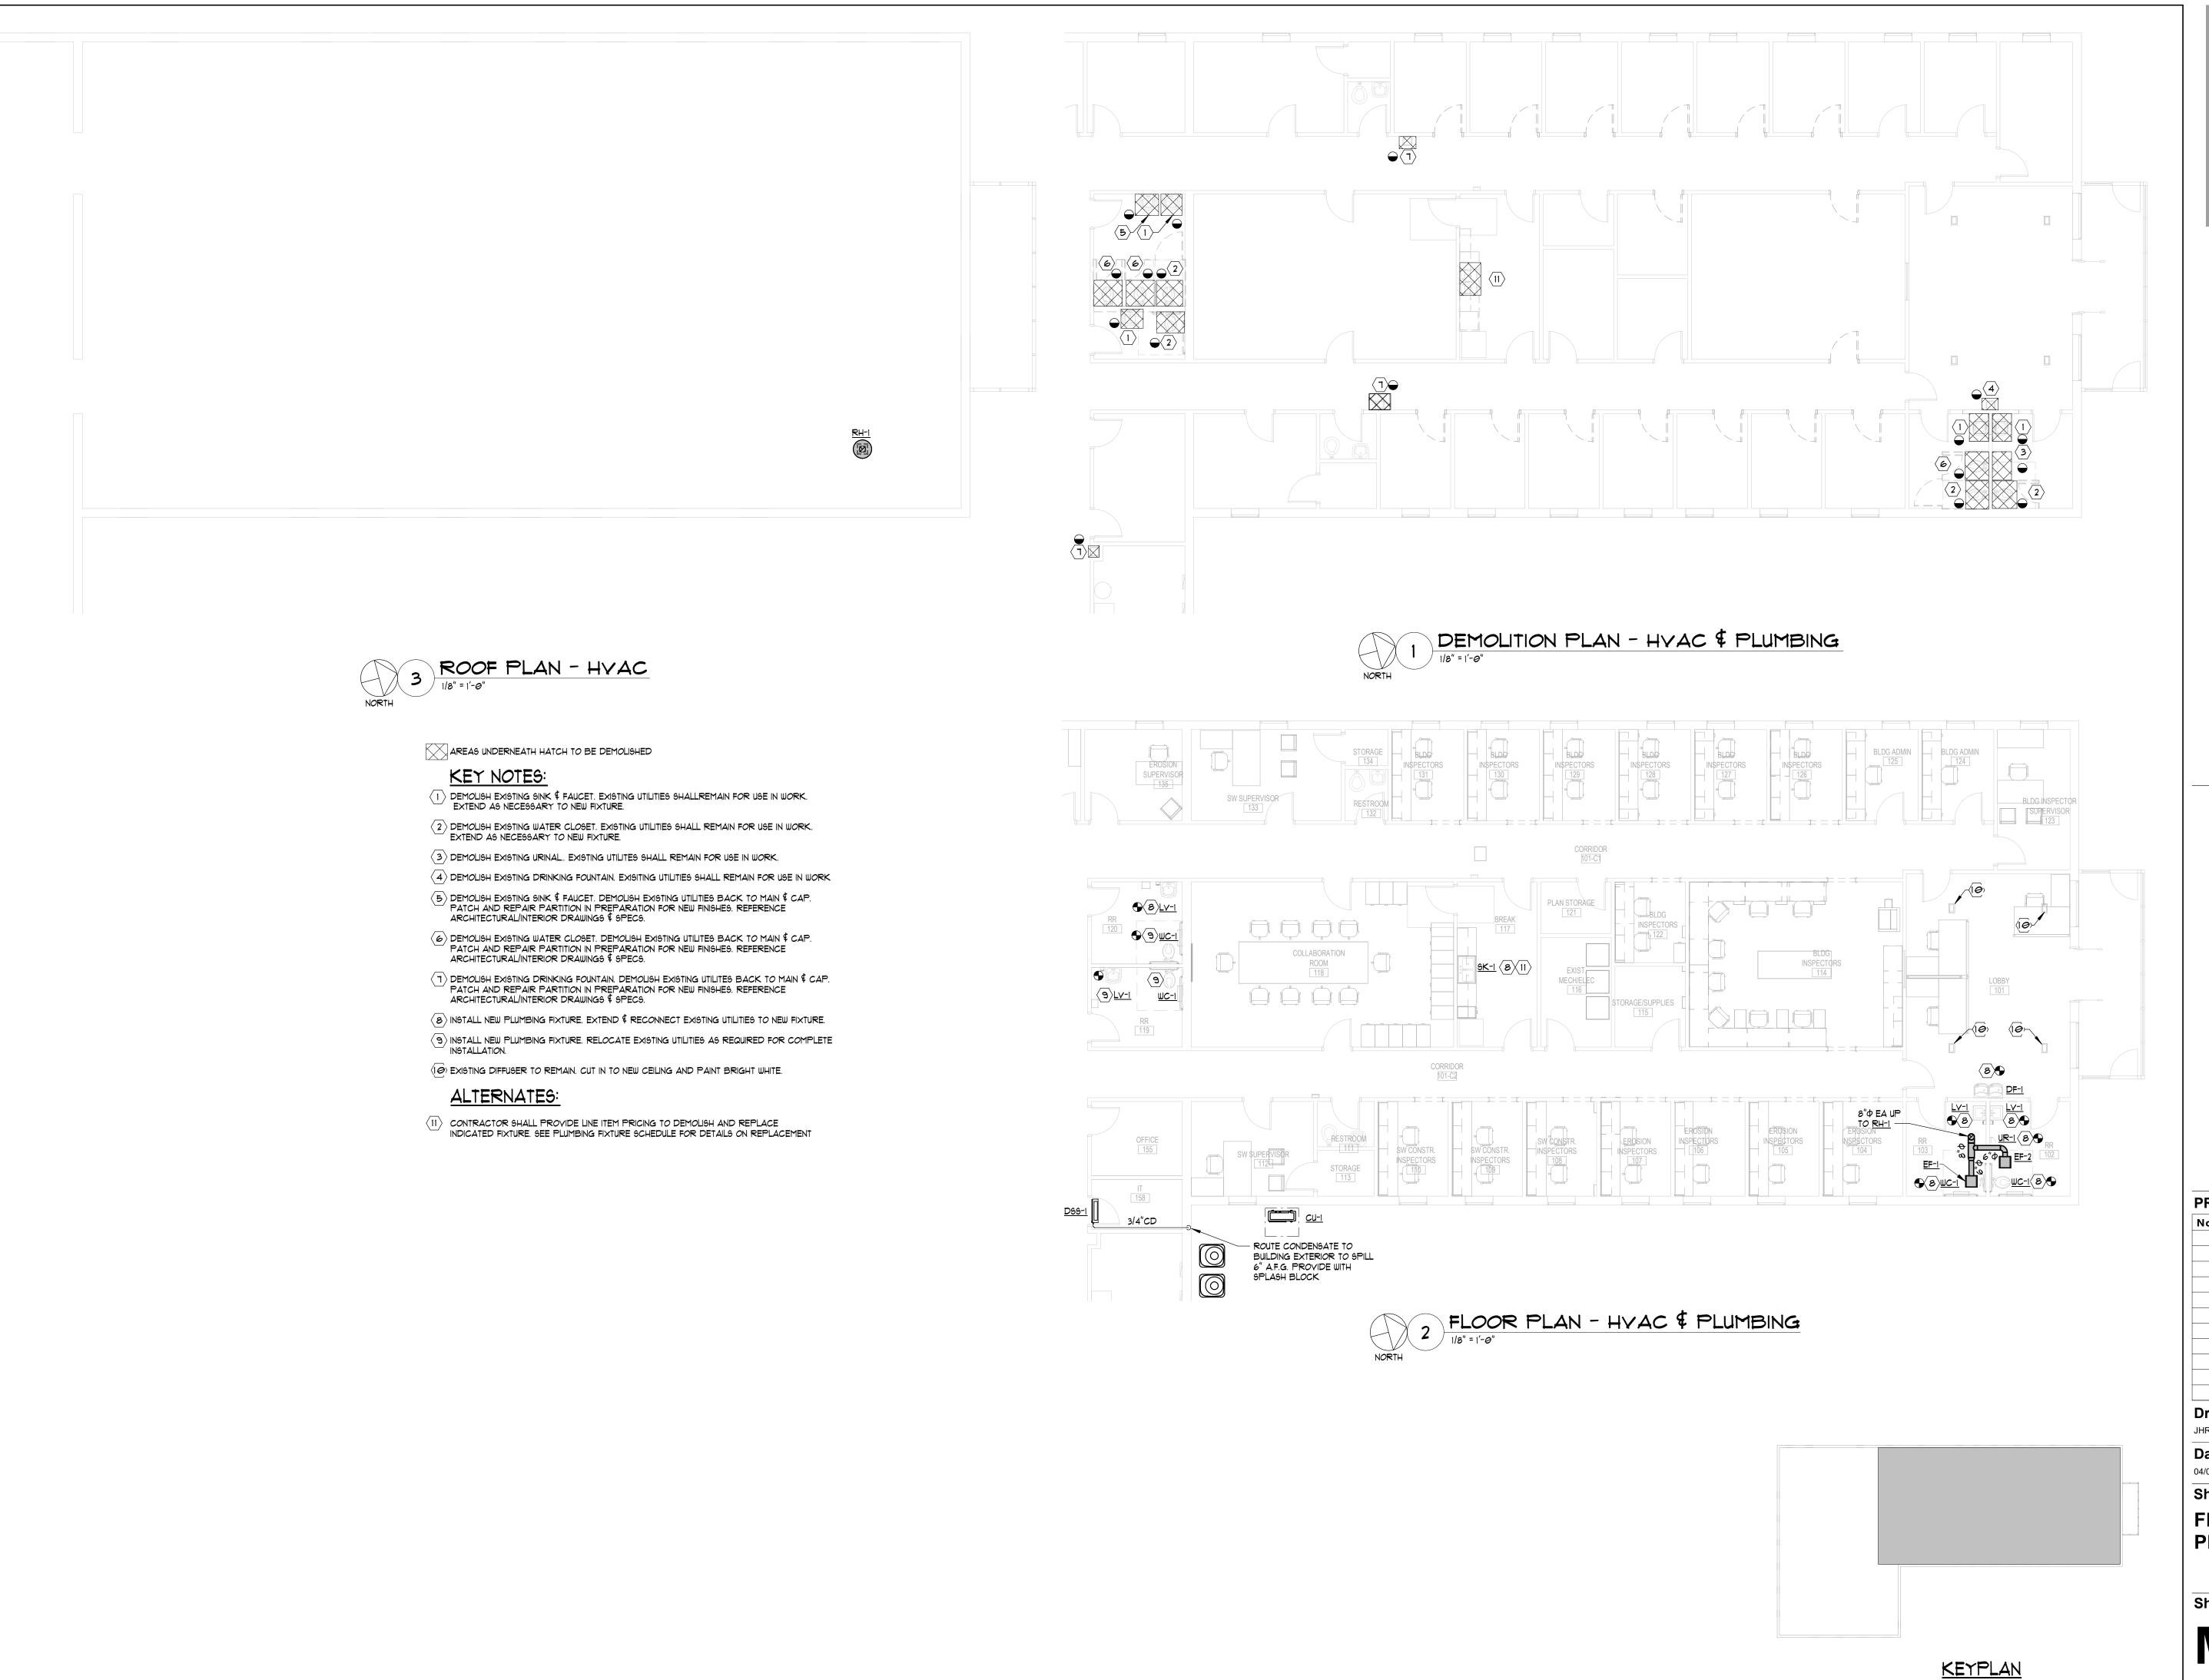
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**PLUMBING** 

Sheet No. **MP-0-02** 

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FLOOR PLANS - HVAC & PLUMBING

Sheet No.

MP-1-01

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### ELECTRICAL GENERAL NOTES:

- ALL WORK SHALL COMPLY WITH ALL LOCAL BUILDING CODES, LAWS, REGULATIONS, ORDINANCES AND 2017 NATIONAL ELECTRICAL CODE.
- 2. THE ELECTRICAL WORK SHALL CONSIST OF ALL LABOR AND MATERIAL TO COMPLETELY INSTALL ALL ELECTRICAL WORKS AS SHOWN ON THESE DRAWINGS.
- COORDINATE LOCATION OF LIGHT FIXTURES IN AREAS OF MECHANICAL DUCTWORK AND PIPING WITH MECHANICAL CONTRACTOR. RELOCATE LIGHT FIXTURES, WIRING AND CONDUIT IF NECESSARY AS DIRECTED BY THE ARCHITECT/ENGINEER.
- ALL WORK ASSOCIATED WITH THE SCOPE OF THIS PROJECT INCLUDING EQUIPMENT, ACCESSORIES, DEVICES, SYSTEMS, ETC. SHALL BE COVERED BY A ONE YEAR GUARANTEE WHICH SHALL START AT THE TIME OF FINAL ACCEPTANCE BY THE OWNER. ANY DEFECTS IN PRODUCTS, INSTALLATION, OR WORKMANSHIP SHALL BE CORRECTED AT NO ADDITIONAL CHARGE AND SHALL INCLUDE ANY NECESSARY REPAIRS TO WALLS, FLOORS, MILLWORK, ETC. WHICH SHALL BE REPAIRED BACK TO NEW AND FINISHED CONDITION.
- THE CONTRACTOR SHALL KEEP A RECORD OF THE CHANGES WHICH ARE IN CONFLICT WITH THESE DRAWINGS AND SPECIFICATIONS. AT THE COMPLETION OF THIS WORK THE CONTRACTOR SHALL SUBMIT "AS BUILT" PRINTS TO THE OWNER.
- 6. THE DRAWINGS ARE DIAGRAMMATIC AND DO NOT NECESSARILY SHOW THE EXACT ROUTING OR DETAILED FITTINGS. ALL WORK SHALL BE INSTALLED AS A COMPLETE SYSTEM WITH NECESSARY COMPONENTS, FITTINGS, STRAPS, ETC. ALL JUNCTION BOXES AND COMPONENTS SHALL BE INSTALLED SO THAT THEY ARE ACCESSIBLE.
- REFER TO THE ENTIRE CONTRACTED DRAWING SET AND SPECIFICATIONS FOR GUIDANCE ON DIMENSIONS, CEILING HEIGHTS, DOOR SWINGS, ROOM FINISHES, STRUCTURAL DETAILS, LOCATIONS OF DUCTWORK, PIPING AND STRUCTURAL MEMBERS. INSTALL THE ELECTRICAL SYSTEMS SO AS NOT TO INTERFERE WITH THE INSTALLATION OR FUNCTION OF ANOTHER DISCIPLINES WORK.
- 8. ALL CONDUIT MUST BE CONCEALED ABOVE THE CEILING OR IN THE WALLS UNLESS OTHERWISE NOTED.
- 3. COORDINATE RECEPTACLE NEMA TYPE AND VOLTAGE WITH ALL EQUIPMENT.
- THE CONTRACTOR SHALL INSTALL ALL WORK IN A NEAT AND WORKMANLIKE MANNER AND ACCORDING TO GENERALLY ACCEPTED PRACTICES OF FIRST CLASS WORKMANSHIP.
- 11. PROVIDE A NEW DIRECTORY FOR ALL PANELS. CORRECTLY LABEL ALL CIRCUITS, SPACES AND SPARES PER NEC 408.4.
- 12. ALL RECESSED LIGHTING FIXTURES SHALL BE FASTENED TO STRUCTURE OR GRID PER N.E.C. 410.
- 13. ANY CONDUIT, BUSWAY, CABLE TRAY, SLEEVES, ETC. THAT PENETRATE RATED WALLS, CEILINGS AND FLOORS SHALL BE FIRE STOPPED PER CODE.
- 14. MOUNTING HEIGHTS FOR DEVICES ARE TO BE MEASURED TO THE DEVICE CENTERLINE.
- 15. ALL BRANCH CIRCUITS SHALL BE WIRED  $\frac{1}{2}$ "C, 2-#12, 1-#12G MINIMUM, UNLESS OTHERWISE NOTED ON THE PLANS. ALL HOMERUNS SHALL BE A MINIMUM  $\frac{3}{4}$ " CONDUIT.
- 16. MULTIWIRE BRANCH CIRCUITS MAY NOT BE USED. PROVIDE SEPARATE NEUTRAL FOR EACH CIRCUIT OF A DIFFERENT PHASE. OVERCURRENT PROTECTION SHALL COMPLY WITH NEC 210.4.
- PROVIDE A SEPARATE GREEN, INSULATED, #12AWG EQUIPMENT GROUNDING CONDUCTOR ROUTED WITH THE BRANCH CIRCUIT HOMERUN CONDUCTORS.
  PROVIDE GROUND THROUGH ENTIRE CONDUIT RUN TO THE LAST DEVICE. ALL EQUIPMENT SHALL BE GROUNDED AT THE PANEL WHICH FEEDS THE EQUIPMENT. PROVIDE GROUNDING PER NEC 250.
- 18. ALL SWITCHES FOR LIGHTS, FANS, ETC., WHICH ARE SHOWN TO BE MOUNTED IN THE SAME GENERAL AREA, SHALL SHARE A MULTI-GANG COVER PLATE AS REQUIRED.
- 19. ARMORED CABLE MAY BE USED IN WALLS AND MILLWORK ONLY AND MUST BE MC TYPE (WITH GROUND). ALL CONDUIT TO AND ABOVE THE PLENUM SHALL BE EMT. ALL HOMERUNS SHALL BE IN CONDUIT RAN FROM THE FIRST DEVICE OR LIGHT FIXTURE TO THE PANEL.
- 20. THE CONTRACTOR SHALL REFER TO ARCHITECTURAL PLANS FOR EXACT LOCATIONS OF OUTLETS, LIGHT FIXTURES, AND PARTITIONS. FINISHES FOR DEVICES AND COVERPLATES SHALL BE AS SELECTED BY ARCHITECT.
- 21. PROVIDE A 2-GANG OUTLET BOX AND 1" CONDUIT WITH PULL STRING TO ABOVE ACCESSIBLE CEILING
- FOR ALL NEW DATA, TELEPHONE AND CABLE OUTLETS. COORDINATE PLASTER RING SIZE WITH TENANT AND CABLE VENDOR.

  22. LIGHT FIXTURES SHALL BE AS SCHEDULED, WITH ONLY PRE-APPROVED EQUAL FIXTURES ACCEPTABLE.
- FLUORESCENT LAMPS SHALL BE RAPID START, 32W, OR LOW MERCURY CONTENT, AND OF NOT LESS THAN 2900 LUMEN OUTPUT UNLESS OTHERWISE NOTED ON LIGHT FIXTURE SCHEDULE.
- 24. FLUORESCENT BALLASTS SHALL BE ELECTRONIC WITH A MAXIMUM OF 10% THD AND AS MANUFACTURED BY ADVANCE, OSRAM/SYLVANIA,
- 25. ALL CONDUCTORS SHALL BE COPPER. CONDUCTORS FOR SIZES NO. 10 AND SMALLER SHALL BE TYPE "THWN" OR "THHN/THWN". CONDUCTORS FOR SIZES NO. 8 AND LARGER SHALL BE TYPE "XHHW". SOLID CONDUCTORS TERMINATING IN A BREAKER OR DEVICE SHALL BE UTILIZED FOR WIRE SIZE NO. 12. MINIMUM WIRE SIZE SHALL BE NO. 12.
- 26. ALL BOXES SHALL BE PRESSED STEEL, SINGLE PIECE (NON-GANGABLE) TYPE.
- 21. ALL COVER PLATES SHALL BE STAINLESS STEEL.

GE/MAGNETEK, OR MOTOROLA.

- 28. ALL COYER PLATES FOR DEVICES AND JUNCTION BOXES SHALL HAVE CIRCUIT NUMBERS LABELED WITH INDELIBLE INK MARKER. DEVICE COYERS SHALL BE LABELED ON THE BACK, JUNCTION BOX COYERS SHALL BE LABELED ON THE FRONT.
- 9. RECEPTACLES SHALL BE 120 VOLT, 20A, WITH PARTS NUMBERS AS LISTED BY HUBBELL OR EQUAL BY ARROWHART, P\$S, OR LEVITON. COLOR SHALL BE AS SELECTED BY THE ARCHITECT.

9INGLE RECEPTACLE #HBL536IX
DUPLEX RECEPTACLE #HBL5352X (HBL8300 - HEALTHCARE)
GFCI RECEPTACLE #GF5352X (GFR8300 - HEALTHCARE)

30. SWITCHES SHALL BE 120/2777, 20A, WITH PARTS NUMBERS AS LISTED BY HUBBELL OR EQUAL BY ARROWHART, P\$S, OR EAGLE. COLOR SHALL BE AS SELECTED BY THE ARCHITECT.

SINGLE POLE #HBL1221X
THREE WAY #HBL1223X
FOUR WAY #HBL1224X
(ADD "L" SUFFIC FOR KEYED LOCKING TYPE)

- 31. PANELBOARDS, MOTOR STARTERS, SAFETY SWITCHES (HEAVY DUTY), ETC. SHALL BE AS MANUFACTURED BY GENERAL ELECTRIC, SQUARE D, SIEMENS, OR CUTLER HAMMER. ALL BREAKERS SHALL BE "BOLT-ON" TYPE.
- FOR EQUIPMENT THAT IS TO BE WIRED BY ELECTRICAL CONTRACTOR AND FURNISHED BY OTHERS, ELECTRICAL CONTRACTOR SHALL REVIEW ALL SPECIFICATION SECTIONS, EQUIPMENT SCHEDULES, AND/OR DETAILS THROUGHOUT DOCUMENTS THAT PERTAIN TO THIS EQUIPMENT AND INCLUDE ALL WIRING AND DEVICES REFERENCED IN THEIR BIDS. ELECTRICAL CONTRACTOR SHALL COORDINATE EXACT LOCATION OF THIS EQUIPMENT WITH RESPECTIVE CONTRACTOR PRIOR TO ROUGH-IN.
- 33. ALL ABANDONED WIRE SHALL BE REMOVED.
- 34. WHERE WORK BY THE GENERAL CONTRACTOR (WALL REMOVE, NEW OR RELATED WALL OPENING, ETC.) RESULTS IN THE REMOVALS, REFEEDING, OR RELOCATION OF LIGHTING FIXTURES OR ELECTRICAL DEVICES, THE ELECTRICAL CONTRACTOR SHALL DISCONNECT OR RECONNECT AS REQUIRED ALL ACTIVE DEVICES REMAINING ON THAT CIRCUIT SYSTEM.
- 35. RING OUT ALL CIRCUITS IN EXISTING PANEL AFFECTED BY THIS ALTERATION. WHERE ADDITIONAL CIRCUITS ARE NEEDED, REFUSE CIRCUITS AVAILABLE FOR REUSE, OR PROVIDE NEW BREAKERS. TAG ALL UNUSED CIRCUITS AS SPARE, REPLACE ALL INOPERATIVE OR DEFECTIVE CIRCUIT BREAKERS, AND TIGHTEN ALL CONNECTIONS.
- 6. WHERE DEMOLITION DISRUPTS ELECTRICAL CONTINUITY OF EXISTING RECEPTACLES/LIGHTS, AND NO RECONNECTION IS SHOWN, RECONNECT TO ITS EXISTING CIRCUIT.
- ALL DIMENSIONS OF EXISTING CONSTRUCTION ARE APPROXIMATE. THE ELECTRICAL CONTRACTOR SHALL MAKE ALL NECESSARY FIELD MEASUREMENTS OF EXISTING STRUCTURES AND EQUIPMENT TO VERIFY DIMENSIONS SHOWN ON THE DRAWINGS. PROVIDE PROPER DIMENSIONS NOT SHOWN PRIOR TO EQUIPMENT FABRICATION. ALL COST FOR MODIFICATIONS OF NEW CONSTRUCTION DUE TO LACK OF CONFIRMATION OF DIMENSIONS BY FIELD MEASUREMENT SHALL BE THE RESPONSIBILITY OF THE ELECTRICAL CONTRACTOR.
- PROVIDE 120 VOLT POWER FOR ALL SMOKE/FIRE DAMPERS AND TIE DAMPERS BACK TO THE BUILDING FIRE ALARM SYSTEM SO THAT UPON ACTIVATION OF DUCT MOUNTED SMOKE DETECTOR OR INDIVIDUAL SENSORS ASSOCIATED WITH DAMPER A SIGNAL WILL BE SENT BACK TO THE BUILDING FIRE ALARM SYSTEM INDICATING ALARM AND STATUS OF DAMPER (OPEN/CLOSED). CONTRACTOR SHALL PROVIDE ALL WIRING, DUCT MOUNTED SMOKE DETECTORS, MODULES, RELAY, AND ASSOCIATED EQUIPMENT REQUIRED FOR A COMPLETE INSTALLATION. COORDINATE EXACT CONNECTION REQUIREMENTS BETWEEN ALL TRADES. (ELECTRICAL MECHANICAL \$ FIRE PROTECTION). CONTRACTOR SHALL COORDINATE QUANTITIES OF DUCT MOUNTED SMOKE DETECTORS.
- 39. CONDUCTORS SHALL HAVE COLOR CODED JACKETS THE ENTIRE LENGTH FOR SIZES NO. 6 AND SMALLER. THE CONDUCTORS FOR SIZES NO. 4 AND LARGER SHALL HAVE COLOR CODED MARKING TAPE OR COLOR CODED JACKETS THE ENTIRE LENGTH. COLORS SHALL BE AS FOLLOWS

120/208 VOLT SYSTEM	211/480 VOLT SYSTEM
PHASE 'A' - BLACK	PHASE 'A' - BROWN
PHASE 'B' - RED	PHASE 'B' - ORANGE
PHASE 'C' - BLUE	PHASE 'C' - YELLOW
NEUTRAL - WHITE	NEUTRAL - GRAY
GROUND - GREEN	GROUND - GREEN

- 40. WHERE PHASE MARKING TAPE IS USED IT SHALL BE WRAPPED 2" WIDE AND LOCATED AT TWO (2) LOCATIONS 6" AND 18" FROM THE TERMINATION. PHASE MARKING TAPE FOR THE NEUTRAL AND GROUNDING CONDUCTORS SHALL BE PROVIDED WHERE VISIBLE AT ANY POINT WHERE THE CONDUCTOR IS ACCESSIBLE.
- 41. FIELD IDENTIFY EXISTING PANELBOARDS THAT ARE MODIFIED PER NEC 408.4(B).
- 42. PROVIDE ARC-FLASH WARNING LABELS ON ELECTRICAL EQUIPMENT THAT COMPLIES WITH NEC 110.16.
- 43. PROVIDE CONSPICUOUS AND PERMANENT LABEL ON NEW PANELBOARDS INDICATING AVAILABLE FAULT CURRENT PER NEC 110.24.

ELECTRICAL ABBREVIATIONS					
SYMBOL	DESCRIPTION				
AC	ABOVE COUNTER				
AFF	ABOVE FINISHED FLOOR				
BFG	BELOW FINISHED GRADE				
E/R	EXISTING / RELOCATED				
FAA	FIRE ALARM ANNUNCIATOR PANEL				
FACP	FIRE ALARM CONTROL PANEL				
UNO	UNLESS NOTED OTHERWISE				
WP	WEATHER PROOF				
XFMR	TRANSFORMER				

		MOUNTING HEIGH
6YMB <i>O</i> L	DESCRIPTION	ON CENTER (COORD WITH ARC
<u></u> ⊢• ⊢	LED LIGHT FIXTURE	
	EMERGENCY LIGHT FIXTURE	
0	CEILING MOUNTED LIGHT FIXTURE	
○>	CEILING MOUNTED WALL WASH LIGHT FIXTURE	
⊗	EXIT SIGN (PROVIDE FACES AND ARROWS AS SHOWN)	
-⊗	WALL MOUNTED EXIT SIGN (PROVIDE FACES AND ARROWS AS SHOWN)	
	CONDUIT RUN CONCEALED IN WALL OR CEILING	
	CONDUIT RUN CONCEALED IN THE FLOOR, UNDERGROUND, OR UNDER THE ELEVATED SLAB	
	CONDUIT RUN EXPOSED. ROUTE PARALLEL/PERPENDICULAR TO WALLS AND STRUCTURE.	
	CIRCUITS HOMERUN TO THE PANEL	
-	NUMBER OF CONDUCTORS (GROUND NOT SHOWN)	
$\overline{\mathcal{M}}$	FLEXIBLE CONDUIT OR CORD	
	PLYWOOD BACKBOARD. ¾"D(UNO) × 8' H (UNO) × WIDTH AS SHOWN ON PLANS. PAINT WITH FIRE RETARDANT PAINT PRIOR TO INSTALL.	
→ AND →	DUPLEX AND QUAD RECEPTACLE - WALL MOUNTED	18"
=	ISOLATED GROUND DUPLEX RECEPTACLE - WALL MOUNTED	18"
→ AND →	GFCI DUPLEX AND QUAD RECEPTACLE - WALL MOUNTED	18"
1 4 1 11	OUTLET ABOVE THE COUNTER	6" ABOVE COUNT
<b>* * *</b>	SPECIAL AMP/VOLT RECEPTACLE - WALL MOUNTED	18"
- <b>⊘</b>		
==_wp	WEATHER PROOF GFCI DUPLEX RECEPTACLE - WALL MOUNTED	18"
0	CEILING MOUNTED DUPLEX RECEPTACLE	
0	FLOOR MOUNTED DUPLEX RECEPTACLE	
<b>⊕</b>	FLOOR MOUNTED QUAD RECEPTACLE	
4	VOICE AND DATA OUTLET - WALL MOUNTED - PROVIDE JUNCTION BOX AND 3/4" CONDUIT TO 6" ABOVE ACCESSIBLE CEILING. PROVIDE 90 DEG ELBOW ABOVE CEILING WITH PLASTIC GROMMET	18"
•	FLOOR VOICE AND DATA OUTLET. PROVIDE 1.25" CONDUIT TO NEAREST WALL AND THEN UP TO 6" ABOVE ACCESSIBLE CEILING. PROVIDE 90 DEG ELBOW ABOVE CEILING WITH PLASTIC GROMMET	
◀	VOICE OUTLET - WALL MOUNTED - PROVIDE JUNCTION BOX AND 3/4" CONDUIT TO 6" ABOVE ACCESSIBLE CEILING.PROVIDE 30 DEG ELBOW ABOVE CEILING WITH PLASTIC GROMMET.	18"
◁	DATA OUTLET - WALL MOUNTED - PROVIDE JUNCTION BOX AND 3/4" CONDUIT TO 6" ABOVE ACCESSIBLE CEILING.PROVIDE 30 DEG ELBOW ABOVE CEILING WITH PLASTIC GROMMET.	18"
$\P \mathbf{\nabla}$	FLOOR BOX RECEPTACLE AND DATA - WIREMOLD # RFB4 SERIES. PROVIDE 1.5" CONDUIT TO NEAREST WALL AND THEN UP TO 6" ABOVE ACCESSIBLE CEILING. PROVIDE 90 DEG ELBOW ABOVE CEILING WITH PLASTIC GROMMET FOR DATA.	
<b>®</b> —	TELEVISION CABLE OUTLET - PROVIDE CABLE	18"
<b>①</b>	JUNCTION BOX. SIZE AS REQUIRED. PROVIDE CONDUIT AS REQUIRED.	
-0	JUNCTION BOX - WALL MOUNTED - CONDUIT TO 6" ABOVE ACCESSIBLE CEILING AS REQUIRED	
\$/\$3/\$ <sub>T</sub> /\$ <sub>MC</sub>	SPST SWITCH / 3-WAY SWITCH / TIMER SWITCH / MOMENTARY CONTACT SWITCH - WALL MOUNTED	48"
\$ D /\$ LVD	DIMMER SWITCH / LOW YOLTAGE DIMMER SWITCH - WALL MOUNTED (PROVIDE WATTAGE AS REQUIRED)	48"
\$ <sub>M</sub>	MOTOR RATED SWITCH	
<b>O</b> 9	WALL MOUNTED OCCUPANCY SENSOR - WATTSTOPPER WS-301. COLOR TO MATCH STANDARD OUTLETS	48"
Ø5 > <sub>2</sub>	WALL MOUNTED DUAL RELAY OCCUPANCY SENSOR - WATTSTOPPER DW-200. SET BOTH RELAYS TO MANUAL-ON OPERATING MODE. COLOR TO MATCH STANDARD OUTLETS	48"
(OS)	CEILING MOUNTED OCCUPANCY SENSOR - WATTSTOPPER CI-200. PROVIDE ACCESSORIES AS REQ'D.	
(PP)	POWER PACK FOR OCCUPANCY SENSOR - WATTSTOPPER BZ-150.	
_	PANELBOARD OR DISTRIBUTION PANEL	
	DISCONNECT (FRAME AND POLES TO MATCH OVER CURRENT PROTECTION REQUIRED PER NEC OR AS NOTED)	
(F)	FIRE ALARM PULL STATION - WALL MOUNTED	48" AFF TO TOP OF
	FIRE ALARM ADA APPROVED AUDIO/VISUAL (IIOCD)	80" AFF TO BOTTOM OF VISUA
_	FIRE ALARM ADA APPROVED AUDIO ONLY	80" AFF TO
⊢¤	FIRE ALARM ADA APPROVED VISUAL ONLY (110CD)	BOTTOM OF VISUA
[F] <b>\box</b> (	FIRE ALARM PULL STATION AT 48" AFF TO TOP OF BOX AND AUDIO/VISUAL AT 80" AFF	BOTTOM OF VISUA
(Z)	AT 80" AFF TO BOTTOM OF VISUAL  SMOKE DETECTOR - CEILING MOUNTED - QUANTITY AS REQUIRED PEN NFPA	
_		12" BELOW CEILIN
•	HEAT DETECTOR - CEILING MOUNTED, WALL MOUNTED  PROVIDE FIRE ALARM CONNECTION TO SPRINKLER FLOW AND TAMPER SWITCHES/VALVES.	12 DELOW CEILIN
WF √S	COORDINATE QUANTITY AND LOCATIONS WITH SPRINKLER CONTRACTOR.	ĺ





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**ELECTRICAL NOTES** 



ITEMS UNDERNEATH HATCHING NOT IN SCOPE OF WORK.

- DEMOLITION GENERAL NOTES:

  1. WHERE DEMOLITION DISRUPTS THE ELECTRICAL CONTINUITY OF EXISTING RECEPTACLES / LIGHTS AND NO RECONNECTION IS SHOWN, RECONNECT TO IT'S EXISTING CIRCUIT.
- AND NO RECONNECTION IS SHOWN, RECO
- 2. ALL ABANDONED WIRE SHALL BE REMOVED.
- 3. ALL EXISTING ELECTRICAL PANELS ARE TO REMAIN.4. SEE ELECTRICAL AND LIGHTING PLANS FOR MORE INFORMATION.

### DEMOLITICAL MEY MOT

DEMOLITION KEY NOTES:

ALL EXISTING 2X4 LIGHT FIXTURES IN THE INDICATED RESTROOM SHALL BE REMOVED AND SALVAGED FOR RELOCATION. SEE SHEET 1/E-2-01 FOR NEW LOCATION DENOTED WITH "R".







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Sheet Title

FLOOR PLAN -ELECTRICAL DEMOLITION

Sheet No.

E-0-02

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ELECTRICAL GENERAL NOTE: CONTRACTOR SHALL PROVIDE NEW UPDATED PANEL SCHEDULES FOR ALL PANELS AFFECTED


DURING THIS PROJECT. ALL PANEL SCHEDULES SHALL BE PRINTED LABELS (NOT HAND WRITTEN).

2. LABEL PANELBOARDS SCHEDULES PER NEC 408.4. 3. ALL NEW BREAKER AIC RATING SHALL MATCH EXISTING PANEL AIC RATING IN ALL ASPECTS.

4. REFER TO LY DRAWINGS FOR ALL JUNCTION BOX AND CONDUIT REQUIREMENTS FOR LY \$ AV

ELECTRICAL KEY NOTES: CONNECT NEW RECEPTACLE TO EXISTING 120 VOLT RECEPTACLE CIRCUIT. CONTRACTOR SHALL VERIFY EXISTING CIRCUIT HAS SPARE CAPACITY, MAXIMUM 1500 WATTS PER 120 YOLT, 20 AMP CIRCUIT, PRIOR TO MAKING NEW CONNECTION. IF NO SPARE CAPACITY EXISTS ON EXISTING CIRCUIT, PROVIDE NEW 20A/IP BREAKER AS REQUIRED IN PANEL "2" AND CONNECT RECEPTACLE TO NEW CIRCUIT.

$\square$	ALL EXISTING POWER RECEPTACLES UNDERNEATH HATCHING TO REMAIN (NOT IN SCOPE OF WORK).

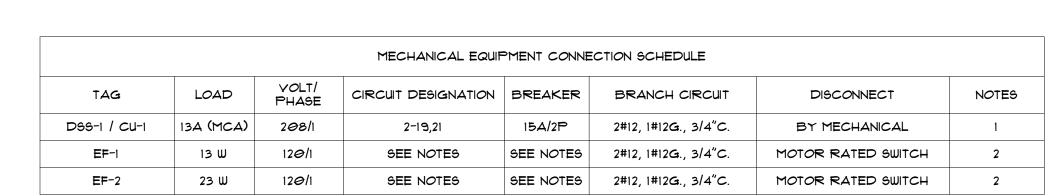

	MECHANICAL EQUIPMENT CONNECTION SCHEDULE NOTES
NUMBER	NOTES
1	INDOOR UNIT (DSS) POWERED FROM OUTDOOR UNIT (CU). CONNECT EXTERNAL CONDENSATE PUMP TO NEAREST AVAILABLE 120 VOLT, 20 AMP CONVENIENCE RECEPTACLE CIRCUIT. COORDINATE EXACT LOCATION OF CONDENSATE PUMP WITH MECHANICAL CONTRACTOR.
2	EXHUAST FAN SHALL BE CONNECTED TO THE 120 VOLT, 20 AMP LIGHTING CIRCUIT SERVING THE RESTROOM. EXHUAST FAN SHALL BE INTERLOCKED WITH THE RESTROOM LIGHT SWITCH SO THAT EXHAUST FAN AND LIGHTING TURN ON AND OFF TOGETHER.



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Sheet Title FLOOR PLAN -**ELECTRICAL** 

Sheet No.

04/02/2020

PROVIDE NEW DEDCIATED

ROUGH-IN. -

RECEPTACLE TO SERVE UPS

FOR RELOCATED IT RACK TO BE WALL MOUNTED ABOVE. COORDINATE EXACT LOCAITON OF RECEPTACLE WITH UPS/IT RACK PRIOR TO

ENLARGED IT ROOM - ELECTRICAL



ALL EXISTING LIGHT FIXTURES AND CONTROLS UNDERNEATH HATCHING TO REMAIN (NOT IN SCOPE OF WORK).


### LIGHTING GENERAL NOTES:

- 1. CONTRACTOR SHALL VERIFY PROPER WORKING ORDER OF ALL EXISTING LIGHT FIXTURES IN THE AREA OF WORK. REPAIR / REPLACE AS NECESSARY. PROVIDE UNIT PRICING FOR REPLACEMENT FIXTURES AT TIME OF BID.
- 2. CONTRACTOR SHALL CLEAN AND RE-LAMP ALL EXISTING LIGHT FIXTURES IN THE AREA OF WORK PRIOR TO TURNING OVER TO OWNER.
- ALL EXISTING LIGHT FIXTURES AND CONTROLS IN THE CORRIDORS SHALL REMAIN.
- 4. WHERE EXISTING/RELOCATED/NEW FIXTURES AS SHOWN TO BE RE-CONNECTED TO EXISTING LIGHTING CIRCUITS AND CONTROL, THE CONTRACTOR SHALL FIELD VERIFY THE CIRCUIT LOAD AND AVAILABLE AMPACITY PRIOR TO CONNECTING FIXTURES. IF EXISTING CIRCUIT DOES NOT HAVE SUFFICIENT CAPACITY CONTRACTOR SHALL TIE INTO NEAREST AVAILABLE CIRCUIT WITH PROPER VOLTAGE AND AVAILABLE AMPACITY OR PROVIDE NEW CIRCUIT FROM NEAREST PANEL.
- 4.1. 120 VOLT LIGHTING CIRCUITS SHALL HAVE A MAXIMUM OF 1500 WATTS.
  5. CONTRACTOR SHALL VERIFY THAT ALL EXISTING EXIT SIGNS AND EMERGENCY LIGHT FIXTURES ARE IN GOOD OPERATING CONDITION AND THEY MEET ALL LOCAL AND JURISDICTIONAL CODES. REPAIR/REPLACE AS NECESSARY. PROVIDE UNIT PRICING FOR REPLACEMENT OF EXIT SIGNS AND EMERGENCY LIGHT FIXTURES AT TIME OF BID.


### LIGHTING IZEN MOTEC

LIGHTING KEY NOTES:

ALL EXISTING LIGHT FIXTURES AND CONTROLS IN THE INDICATED AREA SHALL REMAIN.

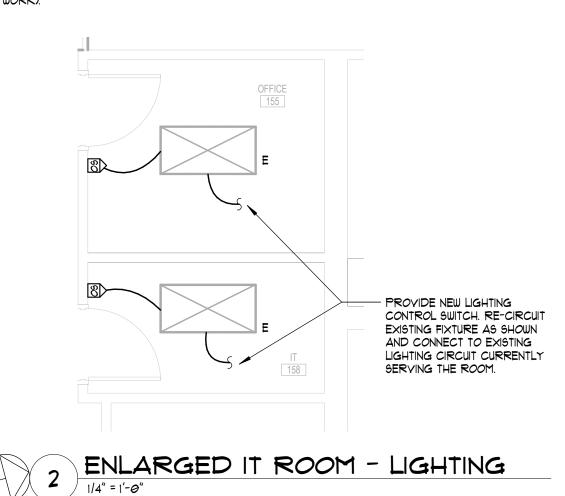

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04/02/2	2020	20007			

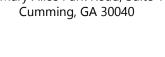**FLOOR PLAN - LIGHTING** 

Olered N.

**Sheet Title** 

E-2-01

RELEASED FOR CONSTRUCTION

			Е	XIST	ΓING	PAI	NELE	BOAF	RD "L	B" S	CHE	DUL	E		
VOL	TAGE:	208	Y / 120	3 PHASE	4 WIRE		MAIN:		200A MCB	}	MOU	NTING:			
BUS	SIZE:	225	AMPS	F.	AULT DUT	Y:		EXISTING	ì	AIC	SUR	FACE			
CKT		DESCRIPTIO	)NI	LOAD	NOTE	BKR		PHASE	_	BKR	NOTE	LOAD	DESCRIPTION	1	CKT
NO	DEGGINI HON		/1 <b>1</b>	LOAD	NOTE	DIXIX	Α	В	С	Ditit	NOTE	LOAD	DECORN HON		NO
1	FR	ONT RESTRO	MOC	0.0	1	20/1	0.0					0.0			2
3		OFFICE #2		0.0	1	20/1		0.0		50/3	1	0.0	AIR CONDITIONS	ΞR	4
5	FRON	IT WATER C	OOLER	0.0	1	20/1			0.0			0.0			6
7		OFFICE #1		0.0	1	20/1	0.0			20/1	1	0.0	CONF. ROOM LIGI	HTS	8
9		OFFICE #3		0.0	1	20/1		0.0		20/1	1	0.0	CONF. ROOM RE	EC	10
11		OFFICE #5		0.0	1	20/1			0.0	20/1	1	0.0	OFFICE #7		12
13		OFFICE #4		0.0	1	20/1	0.0			20/1	1	0.0	BATH AND STORA	AGE	14
15	C	OMPUTER C	CIR	0.0	1	20/1		0.0		20/1	1	0.0	HALL WATER COC	LER	16
17	F	RONT OFFI	CE	0.0	1	20/1			0.0	20/1	1	0.0	OFFICE #8		18
19		OFFICE #9		0.0	1	20/1	0.0			20/1	1	0.0	OFFICE #6		20
21	L	LOBBY LIGHT	ΓS	0.0	1	20/1		0.0		20/1	1	0.0	MICROWAVE		22
23		HALL LIGHT	S	0.0	1	20/1			0.0	20/1	1	0.0	FRIDGE & KIT COU	NTER	24
25	C	OMPUTER BA	ACK	0.0	1	20/1	0.0			20/1	1	0.0	KIT. LIGHTS & MECH	ROOM	26
27	E	XISTING LO	AD	0.0	1	20/1		0.0		20/1	1	0.0	EXISTING LOAD	D	28
29	BLDG	SINSPECTOR	R REC.	0.5	2	20/1			1.0	20/1	2	0.5	LOBBY RECEPTAC	CLES	30
					•		0.0	0.0	1.0				,		
LIGHTING	G	0.0	x 125	% =	0.	.0	TO	TAL BUS I	<b>KVA</b>	NOTES:					
RECEPT	ACLES	1.0	x nec 2	20.44	1.	.0	А	В	С	1	EXISTING	BREAKER	AND LOAD ON THE CIRC	UIT TO REN	MAIN
MOTORS	3	0.0	x 100	0%	0.	.0	0.0	0.0	0.0 1.0						
A/C:		0.0	x 100	0%	0.	.0									
HEATING	HEATING 0.0 x 100%		0.	.0				2			UIT BREAKER. NEW CIRC	UIT BREAK	ŒR TO		
KITCHEN	KITCHEN 0.0 x nec 220.56		20.56	0.0						MATCH E	XISTING IN	ALL ASPECTS.			
MISC.		0.0 × 100%^ 0.0		.0											
TOTAL K	.VA	1.0	CALC	KVA	1.	.0									
TOTAL A	MPS	2.8	CALC A	AMPS	2.	.8									



102 Mary Alice Park Road, Suite 103 Cumming, GA 30040





PRINT RECORD

No.	DATE	DESCRIPTION
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		DN .
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04/02/2	2020	20007

**Sheet Title** 

**ELECTRICAL PANEL SCHEDULES** 

Sheet No.

E-3-01

RELEASED FOR CONSTRUCTION

TOTAL AMPS

9.4

CALC AMPS

9.4

Syd

20005 - FOCO - 426 Cant	
- 20005 - F	
:s\2019 - CENTRAL	
C:\Users\karroyo\Documents\2019 -	∢

LOW YOLTAGE ELECTRICAL CONDUIT ROUGH-IN LEGEND				
9YMB <i>O</i> L	DESCRIPTION			
	ELECTRICAL CONTRACTOR TO PROVIDE 4" SQUARE BACKBOX WITH 1-GANG TRIM RING FLUSH-MOUNTED IN WALL AT DATA OUTLET LOCATION WITH ONE (1)-1"CONDUIT FROM BOX TO ACCESSIBLE CEILING SPACE. SEE DETAILS SHEETS. COORDINATE MOUNTING HEIGHT WITH ELECTRICAL OUTLETS.			
WP	ELECTRICAL CONTRACTOR TO PROVIDE 3/4" CONDUIT SYSTEM ABOVE FINISHED CEILING AS REQUIRED TO SUPPORT 20' CABLE SERVICE LOOP AS SHOWN IN DETAILS.			
	ELECTRICAL CONTRACTOR TO PROVIDE 1-1/4" CONDUIT FROM FLOOR BOX LOCATION TO ACCESSIBLE CEILING SPACE. ALL CONDUITS BELOW GRADE SHALL BE SCHEDULE 40 PVC.			
	SEE CAMERA SCHEDULE FOR REFERENCE TO MOUNTING DETAILS.			
M	SEE INSTALLATION DETAILS.			
E	SEE INSTALLATION DETAILS.			
R	SEE INSTALLATION DETAILS.			
CR	SEE INSTALLATION DETAILS.			
Vw .	ELECTRICAL CONTRACTOR TO PROVIDE 4" SQUARE BACKBOX WITH 1-GANG TRIM RING FLUSH-MOUNTED IN WALL AT 48"AFF TO TOP OF BOX WITH ONE (1)-3/4"CONDUIT FROM BOX TO ACCESSIBLE CEILING SPACE.			
MD	ELECTRICAL CONTRACTOR TO PROVIDE 4" SQUARE BACKBOX WITH 1-GANG TRIM RING FLUSH-MOUNTED IN WALL AT 12" BELOW CEILING. WITH ONE (1)-3/4"CONDUIT FROM BOX TO ACCESSIBLE CEILING SPACE.			
KP	ELECTRICAL CONTRACTOR TO PROVIDE 4" SQUARE BACKBOX WITH 1-GANG TRIM RING FLUSH-MOUNTED IN WALL AT 42"AFF WITH ONE (1)-3/4"CONDUIT FROM BOX TO ACCESSIBLE CEILING SPACE.			
DR	ELECTRICAL CONTRACTOR TO PROVIDE ONE (1)-3/4"CONDUIT FROM BOX TO ACCESSIBLE CEILING SPACE. SEE FLOOR PLAN			
9	ELECTRICAL CONTRACTOR PROVIDE 2-GANG BOX AND 3/4" CONDUIT TO ACCESSIBLE CEILING. PROVIDE WEATHERPROOF BOX FOR EXTERIOR LOCATION.			
9	ELECTRICAL CONTRACTOR PROVIDE 2-GANG BOX AND 3/4" CONDUIT TO ACCESSIBLE CEILING. PROVIDE WEATHERPROOF BOX FOR EXTERIOR LOCATION.			

ABBREVIATIONS		
	DESCRIPTION	
AV	AUDIO-VISUAL	
EC	ELECTRICAL CONTRACTOR	
LAN	LOCAL AREA NETWORK	
NET	FACILITY COMPUTER NETWORK	
OFE	OWNER FURNISHED EQUIPMENT	
P <i>O</i> E	POWER OVER ETHERNET	
PROVIDE	FURNISH AND INSTALL	
Pī	POKE-THROUGH DEVICE	
<b>R</b> J45	EIGHT POSITION MODULAR PLUG AND JACK UTILIZED FOR TWISTED- PAIR CABLE CONNECTIONS	
9C	FIBER OPTIC CABLE CONNECTOR FORM FACTOR	
TBD	TO BE DETERMINED	
uno	UNLESS OTHERWISE NOTED	
VOIP	VOICE OVER INTERNET PROTOCOL (IP) TELEPHONE SYSTEM	
WP	WEATHER PROOF	

	LOW YOLTAGE DEVICE LEGEND
SYMBOL	DE9CRIPTION
V#	DATA OUTLET. ELEVATION IS AT 18" AFF OR AS NOTED ON PLANS. PROVIDE TWO (2) CATEGORY 6 AWG, UTP CABLES TO LOCAL TELECOM ROOM. TERMINATE CABLES ON CATE PATCHBAY
<b>* #</b>	•'#' SUBSCRIPT WHERE USED DETAILS NUMBER OF DATA CIRCUITS . PROVIDE DEFAULT QUANTITY OF TWO CIRCUIT WHEN SUBSCRIPT NOT PRESENT. •'W' SUBSCRIPT WHERE USED DETAILS ONE DATA CIRCUIT INSTALLED AT 48" TO TOP OF DEVICE FOR WALL PHONE OR INTERCOM CALL SWITCH.
	DATA OUTLET FOR WIRELESS ACCESS POINT. PROVIDE TWO (2) CATEGORY 6 AWG, UTP CABLE FROM STATION OUTLET MOUNTED IN CEILING SPACE TO LOCAL IDF ROOM. INSTALL OUTLET IN SURFACE-MOUNTED BOX ATTACHED TO STRUCTURE. LABEL CABLE FOR DATA USE AND TERMINATE ON NEW 6 PATCH PANEL, GROUPED SEPARATELY FROM HORIZONTAL DATA CIRCUITS. PROVIDE 20'-0" SERVICE LOOP AT CEILING.
	DATA OUTLET INSTALLED IN FLOOR BOX OR POKE-THRU DEVICE. SEE ELECTRICAL DRAWING FOR DEVICE SPECIFICATIONS. PROVIDE TWO (2) CATEGORY 6/23 AWG, UTP CABLE FROM STATION OUTLET TO LOCAL TELECOM ROOM. TERMINATE ON CAT6 PATCH PANEL
*	• '#' SUBSCRIPT WHERE USED DETAILS NUMBER OF DATA CIRCUITS. PROVIDE DEFAULT QUANTITY OF TWO CIRCUIT WHEN SUBSCRIPT NOT PRESENT.
AM	AIPHONE MASTER INTERCOM STATION
CR	CARD READER INSTALLED AT 48" AFF TO TOP OF DEVICE. SECURITY CONTRACTOR TO FURNISH, INSTALL, AND PROGRAM CARD READER.
E	ELECTRONIC DOOR HARDWARE WITH DOOR POSITION SWITCH SHALL BE WIRED AND INTEGRATED INTO ACCESS CONTROL SYSTEM BY SECURITY CONTRACTOR. DOOR HARDWARE CONTRACTOR TO PROVIDE BUILT-IN REQUEST TO EXIT DEVICE, AND POWER SUPPLY FOR ELECTRIFIED PANIC HARDWARE. SECURITY CONTRACTOR TO PROVIDE POWER SUPPLIES FOR REMAINING LOW VOLTAGE DOOR HARDWARE.
М	ELECTRO-MAGNETIC DOOR HARDWARE WITH DOOR POSITION SWITCH SHALL BE WIRED AND INTEGRATED INTO ACCESS CONTROL SYSTEM BY SECURITY CONTRACTOR. DOOR HARDWARE CONTRACTOR TO PROVIDE MAGNETIC LOCK AND POWER SUPPLY. SECURITY CONTRACTOR TO PROVIDE POWER SUPPLIES FOR REMAINING LOW VOLTAGE DOOR HARDWARE.
P	DOOR POSITION SWITCH TO BE FURNISHED, INSTALLED, AND PROGRAMMED BY THE SECURITY CONTRACTOR.
R	REQUEST TO EXIT PUSHBUTTON FURNISHED, INSTALLED, AND PROGRAMMED BY THE SECURITY CONTRACTOR.
9	TILE CEILING SPEAKER ASSEMBLY. CABLING PER SPECIFICATIONS.
	SECURITY CAMERA. PROVIDE ONE (1) CATEGORY 6 CABLE.
	SECURITY INTERIOR DOME MULTI-SENSOR CAMERA WITH EXTENDED VIEWING ANGLES. PROVIDE ONE (1) CATEGORY 6 CABLE.
Vw	INTERCOM CALL STATION PROVIDE ONE (1) CATEGORY 6 CABLE.
MD	MOTION DETECTOR, WALL MOUNTED. CABLING AS PER SPECIFICATIONS.
KP	ALARM CONTROL KEY PAD, WALL MOUNTED. CABLING: AS PER SPECIFICATIONS.
DR	DOOR RELEASE BUTTON. SEE ACCESS CONTROL FUNCTIONAL DIAGRAM FOR CABLING.
9	PAGING HORN LOUDSPEAKER
9	SURFACE-MOUNTED INTERCOM SPEAKER

### LOW YOLTAGE LEGEND NOTES


- ELECTRICAL CONTRACTOR TO PROVIDE PULL STRINGS IN ALL CONDUITS.
- ELECTRICAL CONTRACTOR TO TERMINATE ALL CONDUIT STUB-OUTS AND SLEEVES WITH PLASTIC BUSHINGS.
- NO MORE THAN TWO (2) QUARTER BENDS SHALL BE INSTALLED BETWEEN PULL BOXES
- ALL LOW VOLTAGE CABLES NOT INSTALLED IN CONDUIT TO BE SUPPORTED BY J-HOOKS INSTALLED ON 4' CENTERS. ALL CABLES NOT IN CONDUIT TO BE PLENUM RATED.

### PROJECT SCOPE

- A. GENERAL CONTRACTOR SHALL BE RESPONSIBLE FOR ALL RACEWAY SYSTEMS AND ASSOCIATED POWER REQUIREMENTS SHOWN IN LOW VOLTAGE DRAWINGS.
- B. GENERAL CONTRACTOR SHALL BE RESPONSIBLE FOR ALL CABLE AND EQUIPMENT REQUIREMENTS SHOWN IN LOW VOLTAGE DRAWINGS.
- GENERAL CONTRACTOR TO PROVIDE ALL SYSTEM EQUIPMENT NOTED IN DRAWINGS. OWNER TO FURNISH WALL-MOUNTED TELECOM RACK FOR INSTALLATION BY GENERAL CONTRACTOR.



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LOW VOLTAGE LEGEND

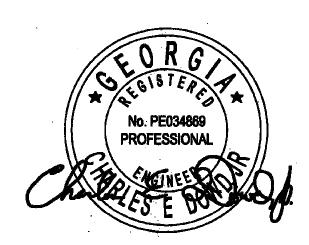Sheet No. LV-0-00

SINGLE GANG FACEPLATE

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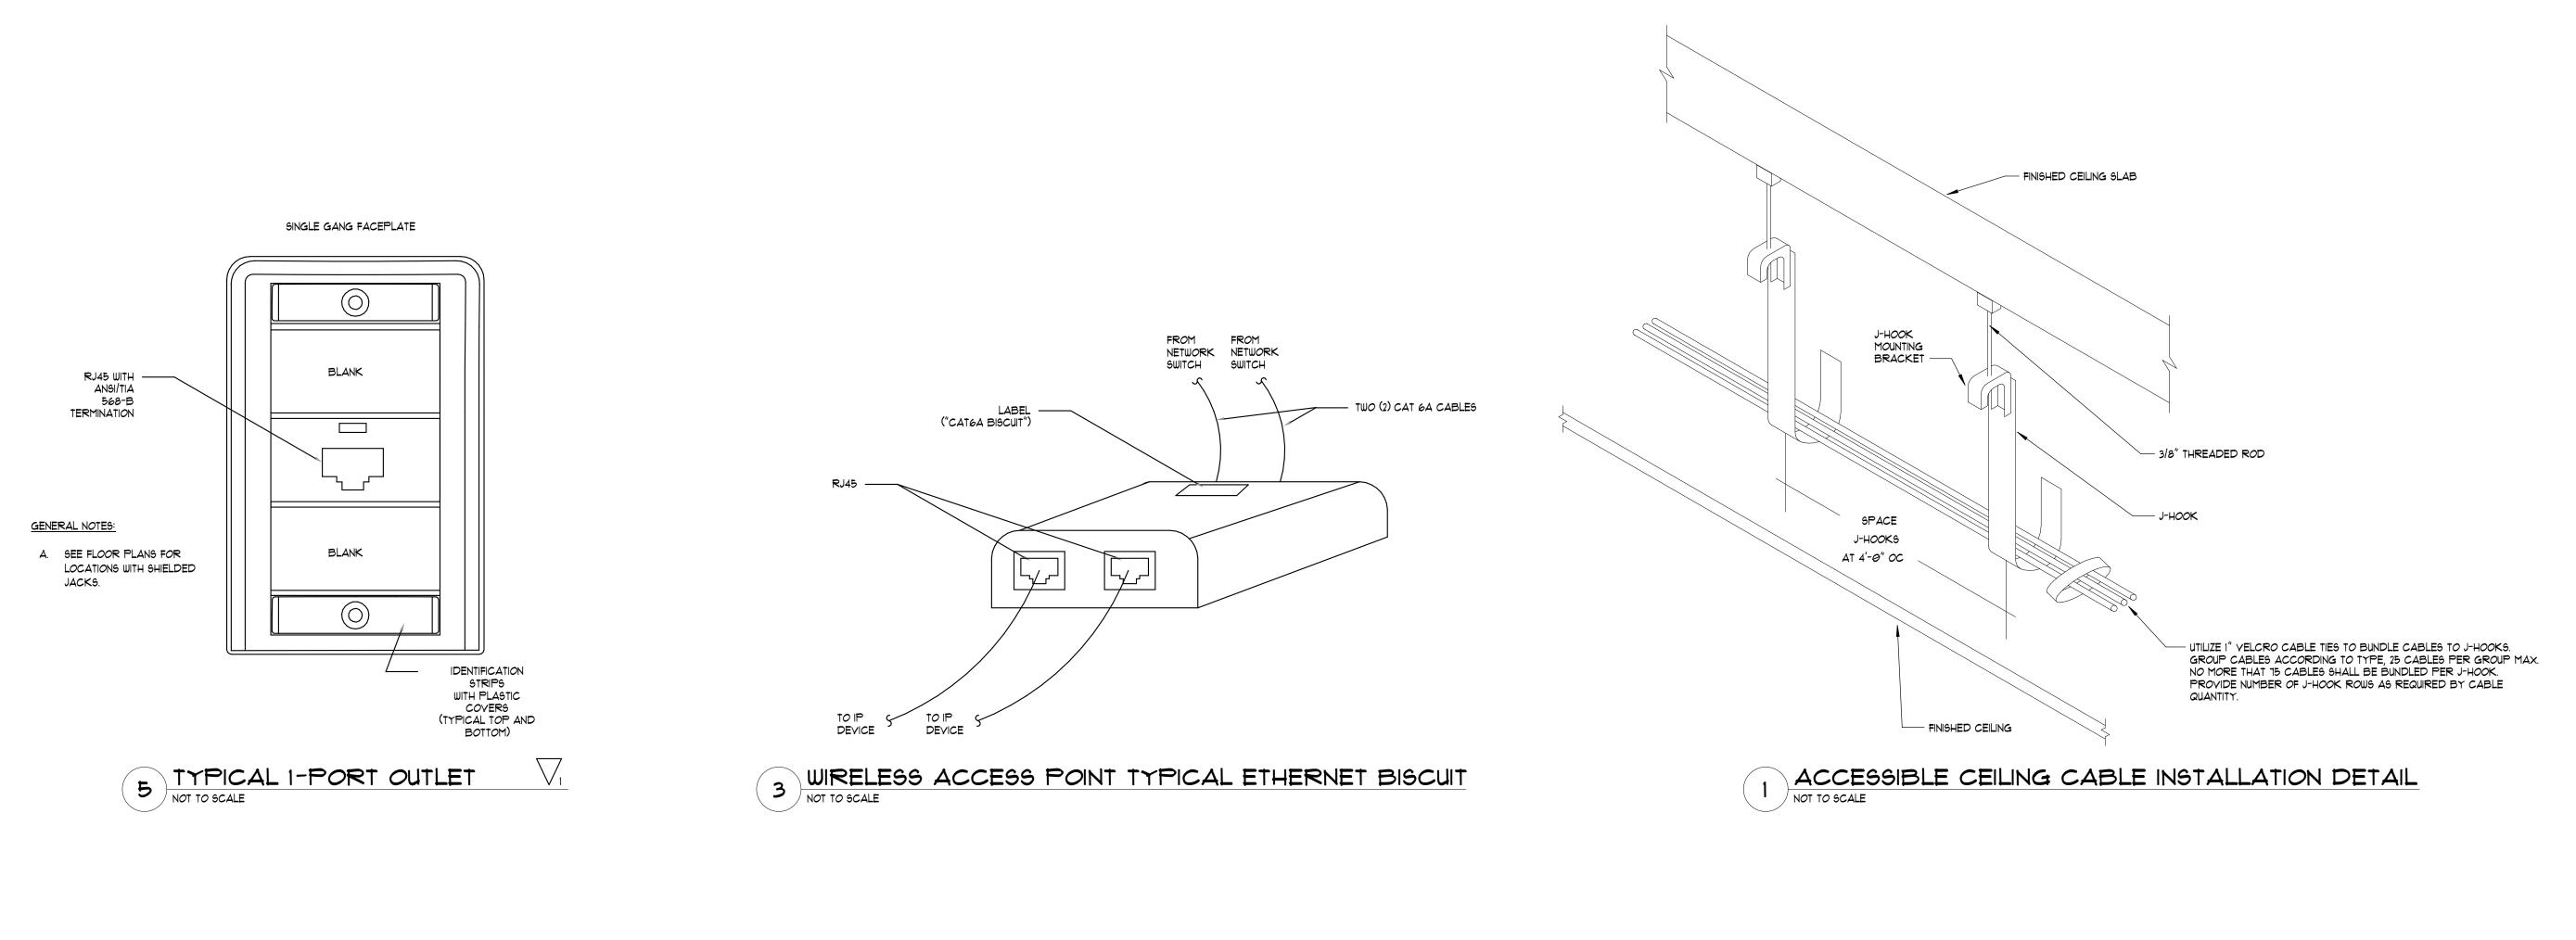
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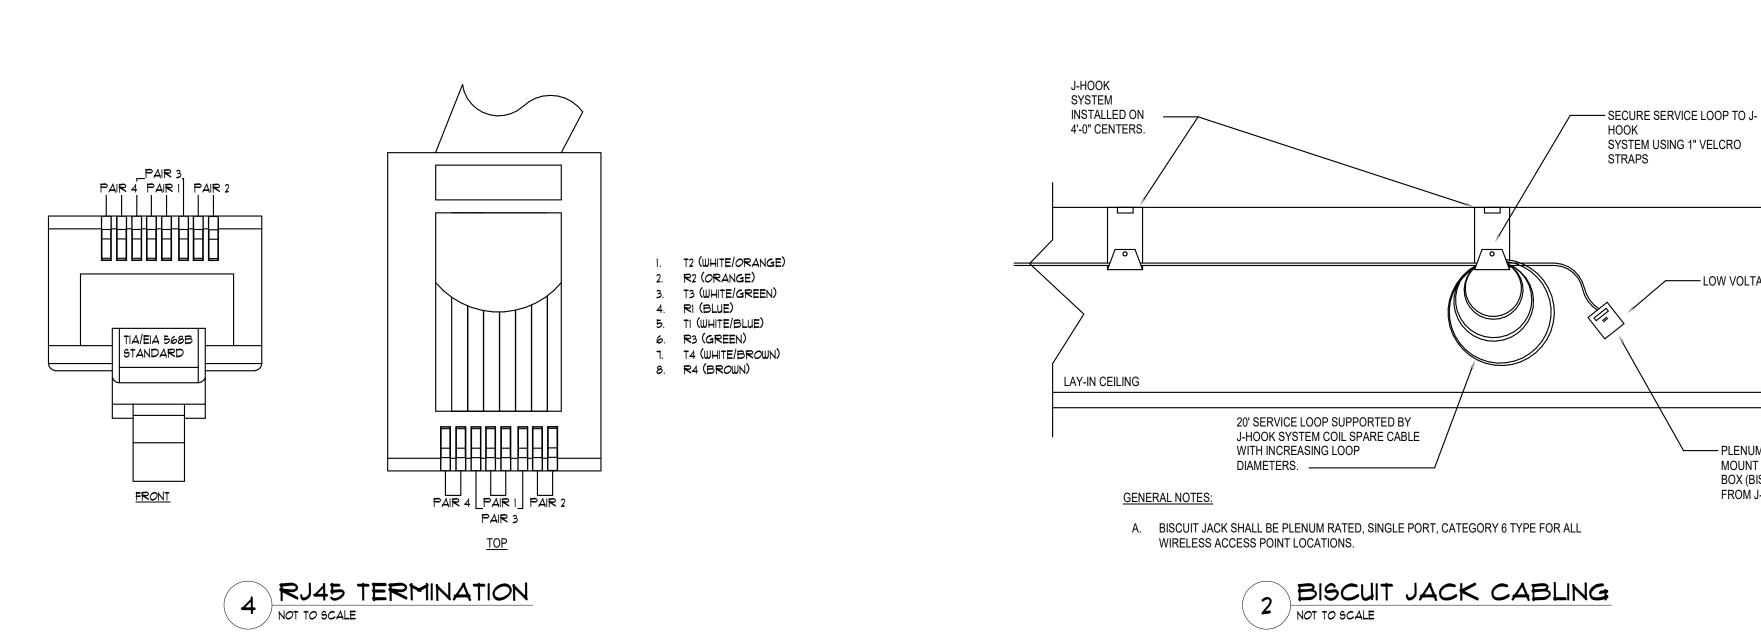
6 TYPICAL 2 -PORT OUTLET


IDENTIFICATION
STRIPS
WITH PLASTIC
COVERS
(TYPICAL TOP AND
BOTTOM)

RJ45 WITH AN9I/TIA 568-B

TERMINATION





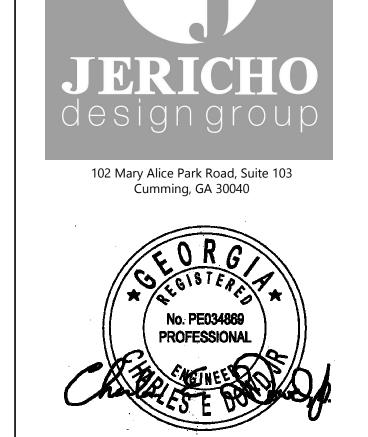



# FORSYTH COUNTY

426 CANTON HWY CUMMING, GA 300

No.	DATE	DESCRIPTION
	04/02/2020	PERMIT SET
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Date		Job No.
04/02/2020		20007

Sheet No.

— LOW VOLTAGE CABLING

— PLENUM RATED, SURFACE MOUNT

BOX (BISCUIT JACK) SUSPENDED FROM J-HOOK SYSTEM.

LV-0-01

VOICE \$ DATA INFRASTRUCTURE

ALL HORIZONTAL CABLE FOR THE VOICE AND DATA SYSTEMS SHALL BE FOUR (4) PAIR, UTP CABLE. BLUE JACKETED CABLE IS TO BE USED FOR DATA. DATA RUNS ARE TO TERMINATE IN TELECOM ROOM. DATA CABLES WILL BE TERMINATED ON CATEGORY 6 PATCH PANELS. ALL OUTLETS, PATCH PANELS, AND CABLE LINKS ARE TO BE LABELED PER TIA/EIA STANDARDS. INSTALLER SHALL DEVELOP AND SUBMIT FOR APPROVAL A LABELING SYSTEM FOR INSTALLER SHALL DEVELOP AND SUBMIT FOR APPROVAL A LABELING SYSTEM FOR INSTALLER SHALL DEVELOP AND SUBMIT FOR APPROVAL A LABELING SYSTEM FOR INSTALLER SHALL DEVELOP AND SUBMIT FOR APPROVAL A LABELING SYSTEM FOR INSTALLER SHALL DEVELOP AND SUBMIT FOR APPROVAL A LABELING SYSTEM FOR INSTALLER SHALL DEVELOP AND SUBMIT FOR APPROVAL A LABELING SYSTEM FOR INSTALLER SHALL DEVELOP AND SUBMIT FOR APPROVAL A LABELING SYSTEM FOR INSTALLER SHALL DEVELOP AND SUBMIT FOR APPROVAL A LABELING SYSTEM FOR INSTALLER SHALL DEVELOP AND SUBMIT FOR APPROVAL A LABELING SYSTEM FOR INSTALLER SHALL DEVELOP AND SUBMIT FOR APPROVAL A LABELING SYSTEM FOR INSTALLER SHALL DEVELOP AND SUBMIT FOR APPROVAL A LABELING SYSTEM FOR INSTALLER SHALL DEVELOP AND SUBMIT FOR APPROVAL A LABELING SYSTEM FOR INSTALLER SHALL DEVELOP AND SUBMIT FOR APPROVAL A LABELING SYSTEM FOR INSTALLER SHALL DEVELOP AND SUBMIT FOR APPROVAL A LABELING SYSTEM FOR INSTALLER SHALL DEVELOP AND SUBMIT FOR APPROVAL A LABELING SYSTEM FOR INSTALLER SHALL DEVELOP AND SUBMIT FOR APPROVAL A LABELING SYSTEM FOR INSTALLER SHALL DEVELOP SHALL SHA THE INFRASTRUCTURE INSTALLATION. ALL DATA RUNS ARE TO BE TESTED FOR COMPLIANCE TO TSB61 USING A LEVEL III OR HIGHER HAND HELD TESTER. CONTRACTOR SHALL PROVIDE ALL PATCH CORDS AND FIBER JUMPERS.

CONSIDERING OTHER BUILDING ADDITIONS AND CONSTRUCTION SCHEDULES.

HORIZONTAL AND BACKBONE CABLE SHALL BE CMP OR CMR RATED ACCORDING TO THE SPACE THE CABLE WILL OCCUPY.

APPROVED MANUFACTURERS - LEVITON, COMMSCOPE SYSTIMAX, HUBBELL, SIEMON, BERK-TEK.

FACEPLATES: COORDINATE COLOR WITH ARCHITECT

SECURITY
SECURITY SYSTEM WILL CONSIST OF CLOSED CIRCUIT CAMERA. ALL COMPONENTS TO BE INSTALLED IN APPROPRIATE LOCATIONS PER DRAWINGS. CONTRACTOR IS RESPONSIBLE FOR INSTALLING ALL NECESSARY COMPONENTS,
CABLE, HARDWARE, SOFTWARE, ETC. TO FURNISH COMPLETE SYSTEM. ALL INDOOR CABLES SHALL BE RATED CMP OR CMR ACCORDING TO THE SPACE THE CABLE WILL OCCUPY. CONTRACTOR WILL BE RESPONSIBLE FOR
CABLE, HARDWARE, SOFTWARE, ETC. TO FURNISH COMPLETE SYSTEM. ALL INDOOR CABLES SHALL BE RATED CMP OR CMR ACCORDING TO THE SPACE THE CABLE WILL OCCUPY. CONTRACTOR WILL BE RESPONSIBLE FOR
CABLE, HARDWARE, SOFTWARE, ETC. TO FURNISH COMPLETE SYSTEM. ALL INDOOR CABLES SHALL BE RATED CMP OR CMR ACCORDING TO THE SPACE THE CABLE WILL OCCUPY. CONTRACTOR WILL BE RESPONSIBLE FOR PROVIDING TRAINING TO OPERATOR STAFF, AS REQUIRED TO ASSURE THE APPROPRIATE STAFF BE FAMILIAR AND FLUENT IN OPERATING AND PROGRAMING SYSTEMS. TRAINING SESSIONS TO BE COVERED WITH OWNER/OPERATOR

SPECIFICATIONS

SCOPE OF WORK - TELECOM/SECURITY CONTRACTOR
INSTALLATION OF VOICE, DATA \$ SECURITY INFRASTRUCTURE AND EQUIPMENT. INSTALLER IS RESPONSIBLE FOR PROVIDING ALL CABLE, CONNECTORS, CABLE MANAGEMENT HARDWARE, PATCH PANELS, RACKS AND/OR MOUNTING

BRACKETS AND ANY OTHER RELATED PRODUCTS OR HARDWARE REQUIRED TO DELIVER COMPLETED SYSTEM TO CLIENT. SELECTED CONTRACTOR MUST INSTALL ALL EQUIPMENT AND CABLING IN THE PROPER SEQUENCE

APPROVED MANUFACTURER
VIDEO SURVEILLANCE: SEE DRAWINGS

PRIOR TO COMPLETION OF SYSTEM INSTALLATION.

PROPOSAL COSTS
ALL COSTS ASSOCIATED WITH PREPARATION OF THIS PROPOSAL WILL BE THE RESPONSIBILITY OF THE VENDORS.

| INSTALLATION DOCUMENTATION | AS-BUILT DRAWINGS ARE REQUIRED FOR THIS INSTALLATION. PLEASE PROVIDE INFORMATION ON THE TYPES OF RECORDS YOU WILL PROVIDE AND DELIVERY DATE THEREOF. ALL AS-BUILT DRAWINGS MUST HAVE OUTLETS LABELS SHOWN ON DRAWINGS. ALL AS-BUILT DRAWINGS MUST HAVE CABLE PATHWAYS SHOWN, TERMINATION SCHEDULES FOR ALL PATCH PANELS, TERMINAL BLOCKS OR ANY OTHER APPROPRIATE CABLE TERMINATION WILL ALSO BE

ADDITIONAL GUIDELINES

I. TOTAL INSTALLATION MUST FOLLOW APPLICABLE CODES INCLUDING BUT NOT LIMITED TO, NATIONAL ELECTRIC CODE, NFPA GUIDELINES AND ANY LOCAL CODES OR ORDINANCES IN EFFECT.

2. ALL FLOOR AND WALL OPENINGS MUST BE FIRE SEALED ACCORDING TO LOCAL CODES AND ORDINANCES BY THE VENDOR. ALL WALL OPENINGS MUST BE SLEEVED AND FIRE STOPPED.

3. VENDOR IS RESPONSIBLE FOR OWN CLEANUP.

4. YENDOR IS RESPONSIBLE FOR SAFE KEEPING OF THEIR OWN MATERIAL. ANY LOSSES OF MATERIAL IS THE RESPONSIBILITY OF THE VENDOR. OWNER, GENERAL CONTRACTOR, ETC. ARE NOT RESPONSIBLE FOR LOSSES.

5. GENERAL CONTRACTOR MAY ASK VENDOR TO ATTEND AND HOLD REGULAR AND MANDATORY SAFETY MEETINGS FOR PROJECT MANAGER AND/OR TECHNICIANS.

6. VENDOR MUST COORDINATE WITH GENERAL CONTRACTOR AND ARCHITECT BEFORE DRILLING OR CORING FLOORS FOR CABLE ACCESS.

1. IT IS THE RESPONSIBILITY OF THE VENDOR TO VERIFY FINAL OUTLET PLACEMENT PRIOR TO ANY CONDUIT ROUGH IN OR BOX INSTALLATION. VERIFICATION PROCESS SHALL INCLUDE REFERENCING INTERIOR DESIGN, MEP AND ARCHITECTURAL DRAWINGS AS WELL AS FIELD VERIFICATION.

8. CONTRACTOR IS RESPONSIBLE FOR CONFORMING TO THE SPECIFICATIONS CONTAINED WITHIN THE FOLLOWING STANDARDS:

TIA 568-C.0 GENERIC TELECOMMUNICATIONS CABLING FOR CUSTOMER PREMISES

TIA 568-C.I COMMERCIAL BUILDING TELECOMMUNICATIONS CABLING STANDARD.

BALANCED TWISTED PAIR TELECOMMUNICATIONS CABLING AND COMPONENTS STANDARD.

TELECOMMUNICATIONS PATHWAYS \$ SPACES.

ADMINISTRATION STANDARD FOR TELECOMMUNICATIONS.

TELECOMMUNICATIONS GROUNDING AND BONDING FOR CUSTOMER PREMISES

9. LEAD TECHNICIAN ON SITE MUST BE A FULL-TIME EMPLOYEE OF THE CONTRACTING FIRM AND NOT A SUB-CONTRACTOR.

	CAMERA SCHEDULE				
TAG	DETAIL	MTG HT	CAMERA LOCATION	CAMERA VIEW	VIEW
C-1	2	10'-0"	OUTDOOR	TYPE 2	REAR PARKING
C-2	2	9'-0"	OUTDOOR	TYPE 1	REAR ENTRANCE
C-3	2	9'-0"	OUTDOOR	TYPE I	SIDE ENTRANCE
C-4	2	BELOW SOFFIT-SEE NOTE 9	OUTDOOR	TYPE I	FRONT ENTRANCE
C-5	2	BELOW SOFFIT-SEE NOTE 9	OUTDOOR	TYPE I	FRONT ENTRANCE

### CAMERA TYPE:


1. BULLET STYLE WITH ILLUMINATOR, 2 MEGAPIXEL, VARIABLE FOCAL (2.8MM-8.5MM), RATED FOR EXTERIOR USE, AXIS P1445-LE. 2. BULLET STYLE WITH ILLUMINATOR, 5.3 MEGAPIXEL, VARIABLE FOCAL (2.8MM-8.5MM) RATED FOR EXTERIOR USE, AXIS P1441-LE.

### SECURITY GENERAL NOTES

1. ALL CAMERAS REQUIRE A CAT 6 DROP WITHIN 4FT OF CAMERA LOCATION, PROVIDED BY TELECOM CONTRACTOR.

- 2. ALL CAMERAS REQUIRE POE, 1.5 WATTS NOMINAL.
- 3. ALL DATA TERMINATIONS PROVIDED BY TELECOM CONTRACTOR.
- 4. COORDINATE CAMERA LAYOUT IN ALL SPACES WITH STRUCTURAL PRIOR TO INSTALLATION.
- 5. ALL PENETRATIONS MUST BE CAULKED WITH APPROPRIATE U.L. LISTED FIRE-STOP ASSEMBLY.
- 6. ALL CAMERAS ARE TO BE SECURELY FASTENED.
- 1. ALL CABLING SHALL BE RUN IN DESIGNATED RACEWAY AND/OR SECURED BY APPROVED METHODS.
- 8. PROVIDE CAMERA VMS AND DELL POWEREDGE 1440 SERVER, QUOTE #3000025646166.1 CONFIGURED AS NETWORK VIDEO RECORDER.
- 9. VERIFY SOFFIT HEIGHT IN FIELD. COORDINATE WITH OWNER ON SUBSTITUTION OF VANDAL-RESISTANT FIXED DOME CAMERA IF AVAILABLE MOUNTING HEIGHT IS LESS THAN 3'-0

### LY SECURITY DETAILS - CAMERA SCHEDULE

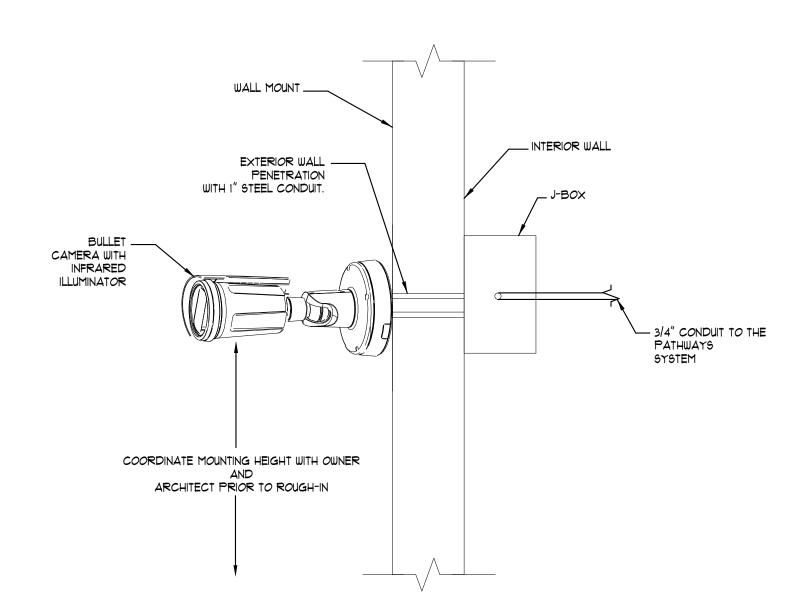


### GENERAL NOTES (APPLY TO THIS DETAIL ONLY):

- PROVIDE 20'-0" SERVICE LOOP AT CAMERA LOCATION. SERVICE LOOP TO BE INSIDE BUILDING AND
- B. ALL PENETRATIONS MUST BE CAULKED WITH APPROPRIATE U.L. LISTED FIRE-STOP ASSEMBLY.
- C. COORDINATE CAMERA ELEVATION WITH DOOR CANOPIES.

2 INTERIOR/EXTERIOR FIXED WALL MOUNT BULLET CAMERA ENCLOSURE DETAIL



102 Mary Alice Park Road, Suite 103 Cumming, GA 30040

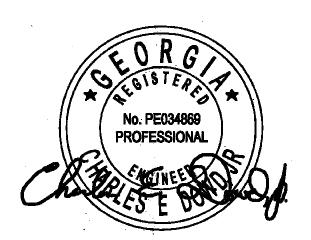

Mechanical • Electrical • Plumbing 1455 Bluegrass Lakes Parkway Alpharetta, Ga 30004 P: (678) 350-9000 F: (678) 350-9010

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2020	20007
	DATE 04/02/2020 wn By


**DETAILS AND SPECIFICATIONS** 

Sheet No.

**Sheet Title** 

LV-0-02

- DATA TRIANGLE WITH "A" SUBSCRIPT EXISTING DATA LOCATION WITH ONE NEW CAT6 AND ONE EXISTING CAT5.
- DATA TRIANGLE WITH "B" SUBSCRIPT NEW DATA LOCATION WITH ONE NEW CAT6 AND ONE RELOCATED CAT5.
- 3. DATA TRIANGLE WITH "C" SUBSCRIPT EXISTING DATA LOCATION WITH TWO CAT6 CABLES, NO MODIFICATIONS REQUIRED AT OFFICE END.
- 4. DATA TRIANGLE WITH "D" SUBSCRIPT NEW DATA LOCATION WITH EXISTING TWO DATA CABLES RELOCATED.
- 5. DATA TRIANGLE WITH "E" SUBSCRIPT NEW DATA LOCATION WITH TWO NEW CAT6 CABLES.
- 6. DATA TRIANGLE WITH "F" SUBSCRIPT EXISTING DATA LOCATION, NO MODIFICATIONS REQUIRED AT OFFICE END.

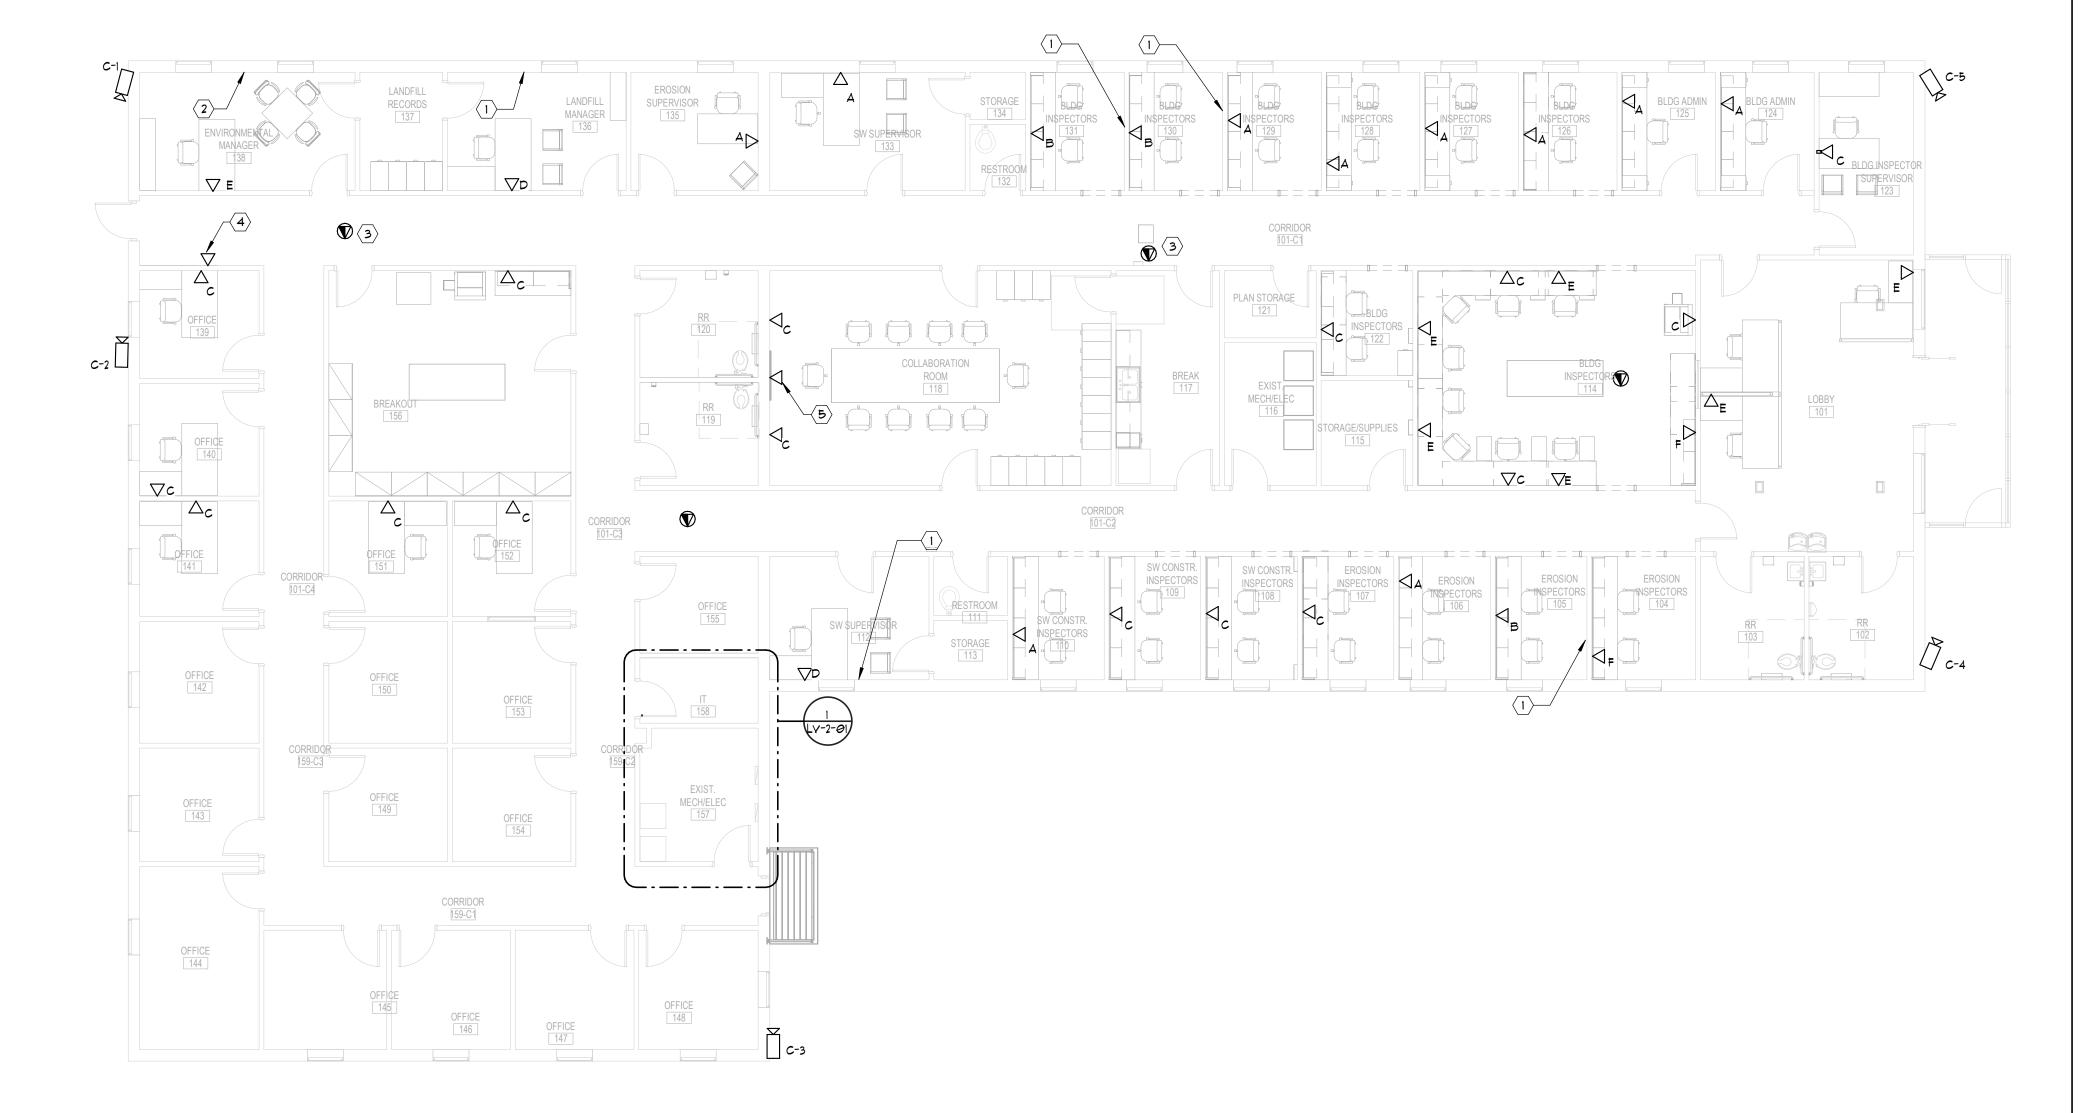



### KEY NOTES:

- 1 LOCATION OF EXISTING DATA OUTLET. ONLY NOTED FOR LOCATIONS WHERE EXISTING DATA CABLES WILL BE RELOCATED
- $\overline{2}$  Location of existing telecom faceplate. Relocate any existing data cables to New Data Location.
- PROVIDE OUTLET ABOVE CEILING FOR FUTURE WIRELESS ACCESS POINT
- $raket{4}$  Provide single data outlet at 48" AFF for timeclock. Coordinate with electrical

AFTER ALL CABLING HAS BEEN INSTALLED IN ORDER TO MAINTAIN WALL RATING.

5 PROVIDE DUAL DATA OUTLET BEHIND FLAT PANEL DISPLAY AT 12" AFF.

### GENERAL NOTES:

- A. DATA CABLES PRESENTLY INSTALLED CONSISTS OF APPROXIMATELY 63 CAT6 AND APPROXIMATELY 18 CAT5 CABLES. OFFICE LOCATIONS WITH CAT5 WILL NEED TO BE FIELD-DETERMINED BUT APPEAR TO BE PRIMARILY ALONG THE BUILDING NORTH WALL.
- B. ALL ITEMS AND CABLING INSTALLED WITHOUT CONDUIT AND ABOVE GRADE SHALL BE CMP (PLENUM RATED) AND LISTED FOR THE INTENDED USE.
- C. ALL CABLES ROUTED BELOW GRADE OR IN SLAB ON GRADE SHALL BE OUTSIDE PLANT RATED FOR WET ENVIRONMENTS. CONTRACTOR TO
- TRANSISTION CABLE TO PLENUM RATED BEFORE CABLE ENTERS A CEILING SPACE.
- D. IN LOCATIONS WHERE CEILING SPACE IS NOT ACCESSIBLE, CABLES SHALL BE INSTALLED IN EMT CONDUIT HAVING A MINIMUM SIZE OF 3/11.
- E. WHERE EXPOSED, ALL CABLES SHALL BE PROTECTED BY STEEL CONDUIT OR BY A STEEL SURFACE MOUNT WIREWAY.
- F. INTERIOR CABLING SHALL BE SUPPORTED BY J-HOOKS ON 4'-0" CENTERS AND ROUTED IN A CONCEALED MANNER ABOVE ACCESSIBLE CEILINGS UNTIL REACHING THE NEAREST CABLE TRAY.
- G. ROUTE CABLING VIA DIRECT PATH 90 THAT INSTALLED CABLE LENGTH DOES NOT EXCEED 90 METERS (295 FEET).
- H. TELECOM CONTRACTOR TO PROVIDE WALL SLEEVES AS REQUIRED FOR CABLE ROUTING. TELECOM CONTRACTOR TO PROVIDE FIRESTOPING
- SPLICES IN CABLE RUNS ARE NOT PERMITTED. ALL LOW VOLTAGE CABLES TO BE ROUTED SPLICE FREE. ROUTE ALL DEVICE CABLING TO NEAREST TELECOM ROOM UNLESS OTHERWISE NOTED.
- J. SEAL ALL BELOW GRADE CONDUITS ENTERING EQUIPMENT ROOM AFTER CABLES HAVE BEEN INSTALLED IN ORDER TO PREVENT WATER FROM ENTERING EQUIPMENT ROOM.
- K. COORDINATE EXTERIOR CAMERA ELEVATION WITH DOOR CANOPY



102 Mary Alice Park Road, Suite 103 Cumming, GA 30040





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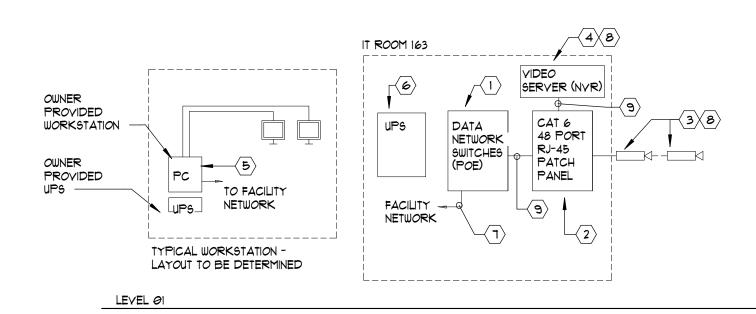
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### KEY NOTES (APPLY TO THIS DETAIL ONLY):

- PROVIDE CATEGORY 6 COMPLIANT FOUR-PAIR CABLE FROM CATEGORY 6 COMPLAINT PATCH PANEL IN TELECOM ROOM TO STATION OUTLET LOCATIONS. CABLE TO BE PLENUM RATED AND AWG 23 CONDUCTOR SIZE. SEE FLOOR PLAN AND LEGEND FOR ADDITIONAL REQUIREMENTS.
- PROVIDE CATEGORY 6 COMPLIANT FOUR-PAIR CABLE CATEGORY 6 COMPLAINT PATCH PANEL IN TELECOM ROOM TO WI-FI ACCESS POINT LOCATIONS. CABLE TO BE PLENUM RATED AND AWG 23 CONDUCTOR SIZE. SEE FLOOR PLAN AND LEGEND FOR ADDITIONAL REQUIREMENTS. GROUP WAP CABLES TOGETHER ON PATCH PANEL.
- 3 SEE OUTLET DETAILS FOR TERMINATION REQUIREMENTS.
- PATCH PANELS TO BE CATEGORY 6, 48 PORT, STANDARD DENSITY TYPE. PROVIDE QUANTITY OF CATEGORY 6 COPPER PATCH PANELS AS REQUIRED TO ACCOMMODATE STATION CABLES INDICATED PLUS CAPACITY FOR 20% SPARES.
- WAP PATCH PANELS TO BE CATEGORY 6A, 48 PORT, STANDARD DENSITY TYPE. PROVIDE QUANTITY OF CATEGORY 6A COPPER PATCH PANELS AS REQUIRED TO ACCOMMODATE STATION CABLES INDICATED PLUS CAPACITY FOR 20% SPARES.
- PROVIDE OPTICAL FIBER PATCHCORDS FROM SERVICE PROVIDER EQUIPMENT TO EQUIPMENT
- 1) TWO (2) EXTREME X450, I GB, 48 PORT DATA SWITCHES WITH POE AND EXTREME ROUTING LICENSE. SWITCHES FURNISHED BY OWNER, INSTALLED BY CONTRACTOR. CONTRACTOR TO PROVIDE ALL REQUIRED PATCHCORDS.
- PROVIDE (1) ONE CATEGORY 6 PATCH CABLE, 2-METERS IN LENGTH, FOR EACH TERMINATED CATEGORY 6 HORIZONTAL CIRCUIT.
- PROVIDE APC 1500 UPS. POWER ALL TELECOM EQUIPMENT THROUGH UPS.
- PROVIDE TWO (2) EXTREME AP38251 WIRELESS ACCESS POINTS. SEE FLOOR PLAN. PROVIDE RF SURVEY TO VERIFY FINAL LOCATIONS.
- PROVIDE ONE (1) TWO-PORT ANALOG TELEPHONE LINE INTERFACE FOR FAX MACHINE. COORDINATE WITH OWNER FOR FINAL LOCATION


### LY - FUNCTIONAL DIAGRAM - YOIP/DATA 2 NOT TO SCALE



### KEY NOTES (APPLY TO THIS DETAIL ONLY):


- $\langle 1 
  angle$  FURNISHED BY OWNER, INSTALLED BY CONTRACTOR. CONTRACTOR TO PROVIDE PATCHCORDS. SEE VOIP/DATA FUNCTIONAL DIAGRAM. CONTRACTOR TO COORDINATE WITH OWNER INFORMATION TECHNOLOGY STAFF FOR SWITCH PORT CONFIGURATION.
- $\langle 2 
  angle$  PATCH PANEL PROVIDED BY TELECOM CONTRACTOR. SEE VOIP/DATA FUNCTIONAL DIAGRAM.
- 3 VIDEO SURVEILLANCE CAMERA FURNISHED AND INSTALLED BY SECURITY CONTRACTOR. CAMERA SHALL BE POWERED BY POE. CAMERAS SHALL PROVIDE WIDE DYNAMIC RANGE FOR DAY AND NIGHT OPERATION. CONTRACTOR TO PROVIDE SURGE PROTECTION FOR ALL
- CONTRACTOR TO PROVIDE NETWORK VIDEO RECORDER (NVR). NVR SHALL BE DELL POWEREDGE T440, QUOTE #3000025646766.1
- 5 SECURITY SYSTEM/VIDEO SURVEILLANCE REVIEW WORKSTATION PROVIDED BY OWNER. CONTRACTOR SHALL BE RESPONSIBLE FOR PROVIDING AND CONFIGURING VIDEO MANAGEMENT SYSTEM (VMW) SOFTWARE CLIENT APPLICATION SOFTWARE ON A MAXIMUM OF TWO OWNER PROVIDED WORKSTATIONS. COORDINATE WITH OWNER ON WORKSTATION QUANTITIES AND
- CONNECT DATA SWITCH DEVICES TO UPS, SEE VOIP/DATA FUNCTIONAL DIAGRAM.
- $\langle \gamma \rangle$  STRUCTURED CABLING FOR FACILITY NETWORK INSTALLED UNDER COMMUNICATIONS (VOIP/DATA) SCOPE OF WORK. SEE VOIP/DATA FUNCTIONAL DIAGRAM.
- (8) CONTRACTOR SHALL PROVIDE ALL CONFIGURATION AND PROGRAMMING FOR CAMERAS AND
- $\langle {f g} 
  angle$  contractor to provide all required category 6 Patch cords and cabling.

### 3 LY - FUNCTIONAL DIAGRAM - VIDEO SURVEILLANCE / NOT TO SCALE

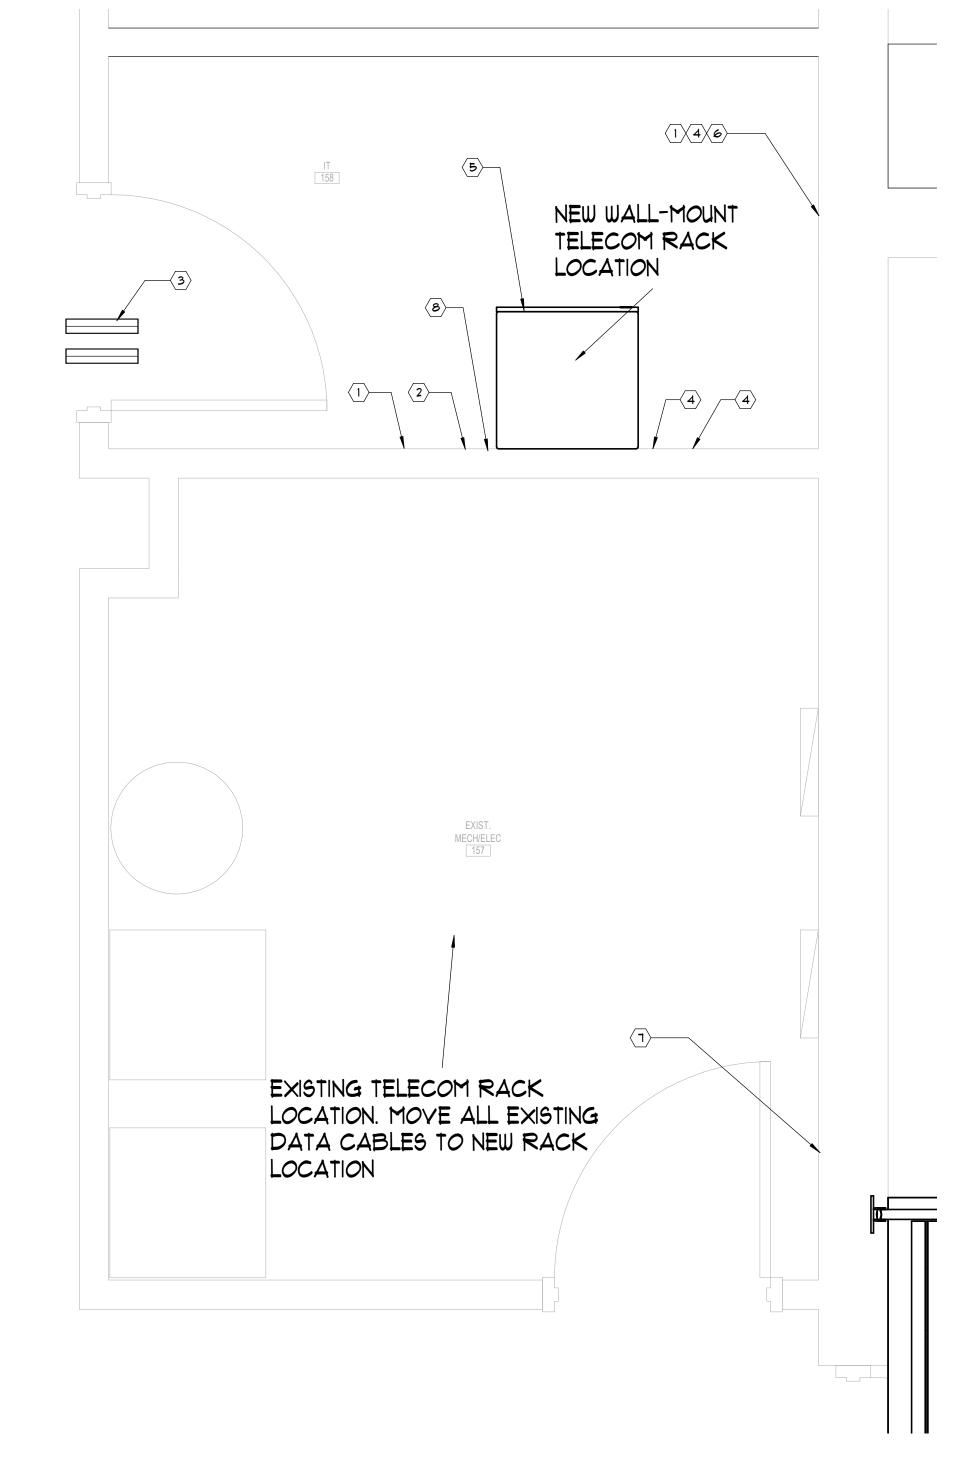


### KEY NOTES:

- $\langle$  1  $\rangle$  GENERAL CONTRACTOR TO INSTALL 8' HIGH  $\times$  3/4" THICK PLYWOOD BACKBOARD TO FULL LENGTH OF WALL AT LOCATIONS SHOWN. PLACE BOTTOM OF BACKBOARD AT 18" AFF. PLYWOOD SHEETS SHALL BE CDX GRADE AND BOTH SIDES AND ALL FOUR EDGES SHALL BE TREATED WITH TWO (2) COATS OF FIRE RETARDANT GREY PAINT.
- $\langle 2 \rangle$  ELECTRICAL CONTRACTOR SHALL PROVIDE MAIN TELECOM GROUNDING BUSBAR. REFERENCE ELECTRICAL DRAWINGS FOR ADDITIONAL INFORMATION.
- (3) ELECTRICAL CONTRACTOR TO PROVIDE TWO (2) 4" WALL SLEEVES AT LOCATIONS SHOWN. FIRESTOP PENETRATIONS AFTER CABLE INSTALLATION TO MATCH WALL RATING.
- 4 ELECTRICAL CONTRACTOR TO PROVIDE A 120V QUAD RECEPTACLE AT 84" AFF FOR EQUIPMENT RACK AND OTHER WALL-MOUNTED EQUIPMENT. PROVIDE A DEDICATED 20A
- (5) WALL MOUNTED TELECOM RACK. TELECOM CONTRACTOR TO INSTALL HOFFMAN EISSWMI2U20 SWING-OUT, 12-SPACE RACK FURNISHED BY OWNER. OVERALL RACK DIMENSIONS ARE
- $20.75" \times 25.5" \times 20" (WXHXD)$ (6) WALL SPACE RESERVED FOR FUTURE EQUIPMENT.
- (7) EXISTING AT\$T SERVICE PROVIDER EQUIPMENT INCLUDING CIENA 3930 SERVICE DELIVERY DATA SWITCH.
- $\langle s \rangle$  TELECOM CONTRACTOR TO PROVIDE J-HOOKS ABOVE CEILING FROM TELECOM RACK TO CORRIDOR.

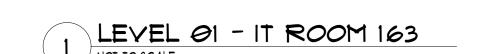



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**ENLARGED TELECOM** ROOMS

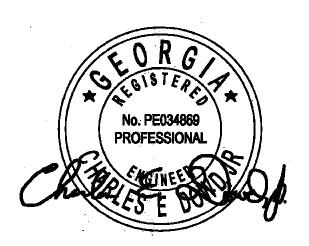Sheet No.

**Sheet Title** 

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