

PERMIT SET

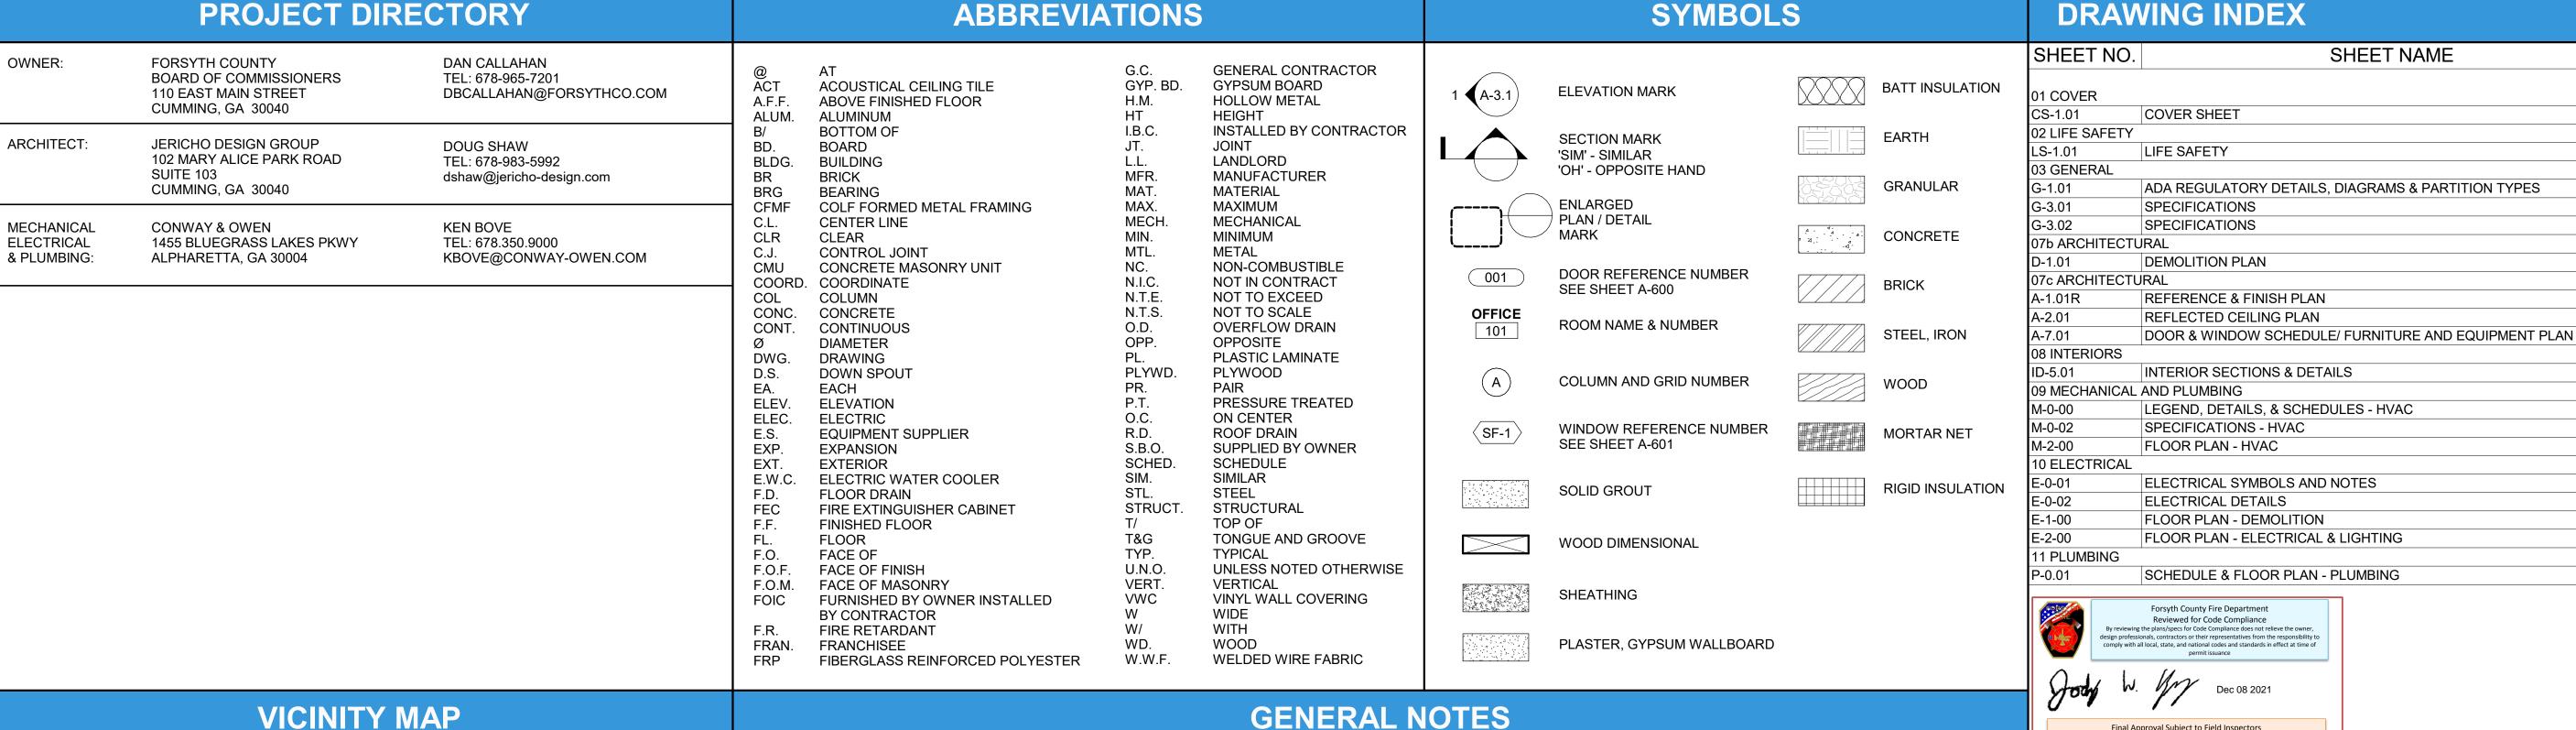

GENERAL NOTES

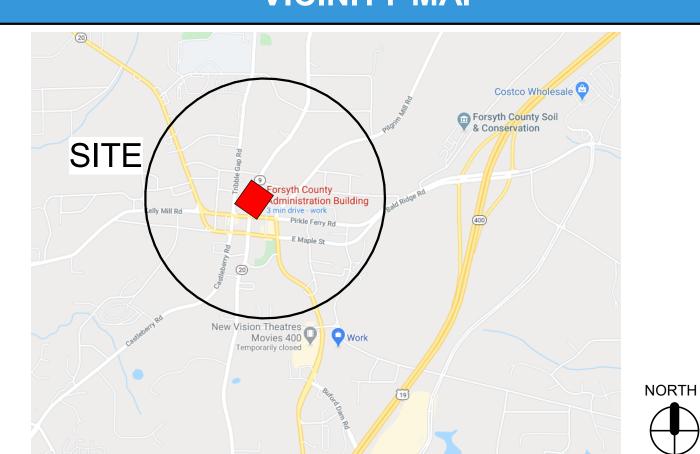

KEY PLAN

 THESE DRAWINGS ARE THE PROPERTY OF JERICHO DESIGN GROUP, LLC AND SHALL NOT BE REPRODUCED OR COPIED (PHYSICALLY AND/OR DIGITALLY) IN PART OF WHOLE. THEY ARE TO BE USED FOR THIS PROJECT ONLY AND ARE NOT TO BE USED ON ANY OTHER 2. DRAWINGS AND SPECIFICATIONS ARE INTENDED TO AGREE AND BE MUTUALLY

EXPLANATORY. THEY SHALL BE ACCEPTED/USED AS A WHOLE; NOT SEPARATELY. SHOULD ANY ITEMS BE OMITTED FROM THE DRAWINGS AND BE HEREIN SPECIFIED, OR VICE VERSA, IT SHALL BE EXECUTED THE SAME AS IF SHOWN AND COMBINED IN BOTH. IT IS THE RESPONSIBILITY OF THE CONTRACTOR TO SUPPLY ENTIRE SET TO EACH

3. THE CONTRACTOR IS TO NOTIFY ARCHITECT OF ANY DISCREPANCIES AFTER FULL REVIEW OF CONTRACT DOCUMENTS TO INCLUDE BUT NOT LIMITED TO ERRORS, OMISSIONS, INCONSISTENCIES, DISCREPANCIES, AND CONFLICTS WITH THE DRAWINGS/SPECIFICATIONS OR AS RELATED TO FIELD CONDITIONS. CONTRACTOR TO CONTACT ARCHITECT IMMEDIATELY TO DISCUSS A RESOLUTION. 4. DO NOT SCALE THE DRAWINGS UNDER ANY CONDITION.

WORK PERFORMED SHALL BE IN ACCORDANCE TO ALL FEDERAL, STATE AND LOCAL BUILDING CODE REQUIREMENTS PER INDUSTRY STANDARDS. ALL REQUIRED PERMITS AND FEES ASSOCIATED ARE TO BE THE RESPONSIBILITY OF THE CONTRACTOR NECESSARY FOR START AND COMPLETION OF THE PROJECT. COPIES OF INSPECTIONS AND PERMITS SHALL BE FURNISHED TO OWNER AT REQUEST AND/OR AT PROJECT CLOSEOUT 6. CONTRACTOR TO TAKE PRECAUTIONS IN PROTECTING THE WORK DURING CONSTRUCTION. ANY DAMAGE TO BE RESTORED TO ORIGINAL CONSTRUCTION BY THE CONTRACTOR. PATCH AND REPAIR ALL ITEMS DAMAGED OR ALTERED DURING CONSTRUCTION BY THE CONTRACTOR. ALL PATCHES SHALL BLEND WITH ADJACENT MATERIAL, COLOR, FINISH, AND TEXTURE. ALL EXISTING WORK FURNISHINGS, EQUIPMENT OR MATERIAL TO REMAIN THAT ARE DAMAGED BY THE CONTRACTOR'S OPERATION SHALL BE REPAIRED BY THE CONTRACTOR AT NO ADDITIONAL COST TO THE OWNER. 7. REQUESTS FOR SUBSTITUTIONS MUST BE SUBMITTED IN WRITING TO THE ARCHITECT FOR CONSIDERATION ONLY IF IMPACT TO SCHEDULE, COST CHANGE OR QUALITY OF PRODUCT. ACCEPTANCE BY ARCHITECT DOES NOT IDENTIFY PRODUCT TO BE OF BETTER QUALITY THAN SPECIFIED PRODUCT.

FIELD VERIFY ALL EXISTING CONDITIONS PRIOR TO COMMENCEMENT OF ANY CONSTRUCTION ACTIVITIES. NOTIFY THE ARCHITECT OF ANY DISCREPANCIES BETWEEN FIELD CONDTITION/S AND CONTRACT DOCUMENTS PRIOR TO ANY CONSTRUCTION ACTIVITY IN AREA OF CONCERN.

10. THE LOCATION OF THE EXISTING UTILITIES & STRUCTURES SHOWN HEREIN ARE APPROXIMATE. IT SHALL BE THE RESPONSIBILITY OF THE CONTRACTOR TO VERIFY THE EXISTENCE & ACTUAL LOCATIONS OF ALL, SHOWN OR NOT SHOWN. ANY DAMAGES RESULTING BY CONTRACTORS' ACTIVITIES SHALL BE REPAIRED AT THE EXPENSE OF THE

11. THE CONTRACTOR SHALL PROVIDE ADEQUATE BRACING & SHORING FOR ALL WORK DURING THE CONSTRUCTION PERIOD.

12. PROVIDE SEPARATION BETWEEN ALL DISSIMILAR METALS INCLUDING SCREWS, NAILS & OTHER FASTENING DEVICES TO AVOID GALVANIC CORROSION. 13. PROVIDE EXPANSION AND CONTROL JOINTS IN ALL WORK AS PER PRODUCT

MANUFACTURER'S STANDARDS, OR SPECIFICATIONS, UNLESS NOTED OTHERWISE.

14. ALL DIMENSIONS ARE WITNESSED TO THE OUSIDE FACE OF MASONRY, FACE OF STUD. CENTER OF COLUMN, TOP OF STRUCTURAL CONCERETE SLAB OR ROUGH WINDOW

OPENING UNLESS NOTED OTHERWISE 15. NOTES APPEAR ON VARIOUS SHEETS FOR DIFFERENT SYSTEMS AND MATERIALS. SHEETS ARE TO BE REVIEWED AND NOTES ON INDIVIDUAL SHEETS SHALL BE APPLIED TO

RELATED DRAWINGS AND DETAILS. 16. INTERIOR PARTITION MOVEMENT CONTROL - VERTICAL CONTROL JOINTS FOR ANY WALL LENGTH ARE TO OCCUR AT NOT MORE THAN 30'-0" O.C. IN THE HORIZONTAL DIRECTION, UNLESS NOTED OTHERWISE.

17. THE CONTRACTOR IS RESPONSIBLE FOR THE COORDINATION OF ALL PARTS OF THE WORK SO THAT NO WORK SHALL BE LEFT IN AN UNFINISHED OR INCOMPLETE CONDITION. 18. THE PROJECT AND ALL INTERIOR SPACES SHALL BE COMPLETELY OPERATIONAL UPON TURNOVER OF SPACE, THESE ARE TO INCLUDE SYSTEMS NOT LIMITED TO ARCHITECTURAL, INTERIORS, STRUCTURAL, CIVIL, MECHANICAL, ELECTRICAL, PLUMBING,

AND FIRE PROTECTION SYSTEMS. 19. IT IS THE CONTRACTOR'S RESPONSIBILITY TO COORDINATE LOCATIONS AND/OR ELEVATIONS OF FLOOR DRAINS, REGISTERS, GRILLES, LOUVERS, DUCTS, UNIT HEATERS, PANELS, ETC. WITH STRUCTURAL MECHANICAL AND ELECTRICAL CONTRACTORS. 20. BOLTING OF WOOD TO STRUCTURAL MEMBERS SHALL BE WITH A MINIMUM OF 1/2" BOLTS X 4'-0" O.C. UNLESS NOTED OTHERWISE ON CONSTRUCTION DOCUMENTS AND/OR SPECIFICATIONS.

22. CONTRACTOR SHALL COMPLY WITH STATE BUILDING CODES IN FIRESTOPPING ALL FLOOR PENETRATIONS.

23. METAL STUDS AND HANGER WIRE ARE NOT TO BE ATTACHED DIRECTLY TO FLOOR/CEILING MTL DECKING. ATTACH TO STRUCTURAL STEEL, BAR JOIST, MISCELLANEOUS STEEL OR CONCRETE STRUCTURE ONLY. IF THE TOP TRACK OF THE METAL STUDS AND HANGER WIRE MUST BE CONNECTED TO METAL DECK, SEE STRUCTURAL NOTES FOR ATTACHMENT CRITERIA.

24. GENERAL: <u>ALL WOOD FRAMING/BLOCKING</u> IN TYPE <u>II</u> CONSTRUCTION <u>SHALL BE</u> FIRE RETARDANT TREATED WOOD IN ACCORDANCE WITH 2012 IBC SECTION 603. 25. IF EVIDENCE SUGGESTS THE PRESENCE OF MOLD ON, BEHIND OR WITHIN SURFACES OR MATERIALS (I.E., INCLUDING, BUT NOT LIMITED TO EXISTING GYPSUM BOARD, EXISTING FLOOR FINISHES AND/OR EXISTING CEILING TILE), IT IS THE RESPONSIBILITY OF THE CONTRACTOR TO IDENTIFY AREA, REMOVE PORTION OF MATERIAL WITH MOLD AND PATCH/REPAIR TO LIKE NEW CONDITION.

26. ANY ALTERATION OR ANY INSTALLATION OF EQUIPMENT SHALL MEET AS NEARLY AS PRACTICABLE THE REQUIREMENTS FOR NEW CONSTRUCTION IN ACCORDANCE WITH NFPA 101: 4.6.7, 2012 EDITION.

27. ALL DEMOLITION WORK SHALL COMPLY WITH THE REQUIREMENT OF NFPA 241, STANDARD FOR SAFEGUARDING CONSTRUCTION, ALTERATION, AND DEMOLITION

28. ALL ALTERATIONS OR MODIFICATIONS TO EXISTING BRANCH LINES OF THE EXISTING SPRINKLER SYSTEM SHALL BE SUBMITTED ALONG WITH HYDRAULIC CALCULATIONS TO THE STATE FIRE MARSHALL FOR APPROVAL IS WORK IS OUTSIDE THE SCOPE OF SECTIONS 4.4.1 THROUGH 4.4.4 OF THE RULES AND REGULATIONS OF THE SAFETY FIRE COMMISIONER, CHAPTER 120-3-3, WHICH ADDS SECTION 4.4 TO NFPA 13.



102 Mary Alice Park Road, Suite 103

PRINT RECORD No. DATE **DESCRIPTION** 11/04/2021 | Permit Drawings Checked By

Job No.

Sheet Title

COVER SHEET

APPROVED BY Sheet No. City of Cumming

Department of Utilities Webb Hansard

NOT RELEASED FOR CONSTRUCTION

12/07/2021

Final Approval Subject to Field Inspectors

If Not Already Existing

Key box shall be located on the

exterior of the building at an approved

location.

Forsyth County Ordinance Part II Section 38-51F


IF APPLICABLE

Fire Alarm, Sprinkler Plans, Hoods, Suppression Systems and

Emergency Responder Radio must be submitted to Fire

of such systems.

ment separately and approved prior to any installations

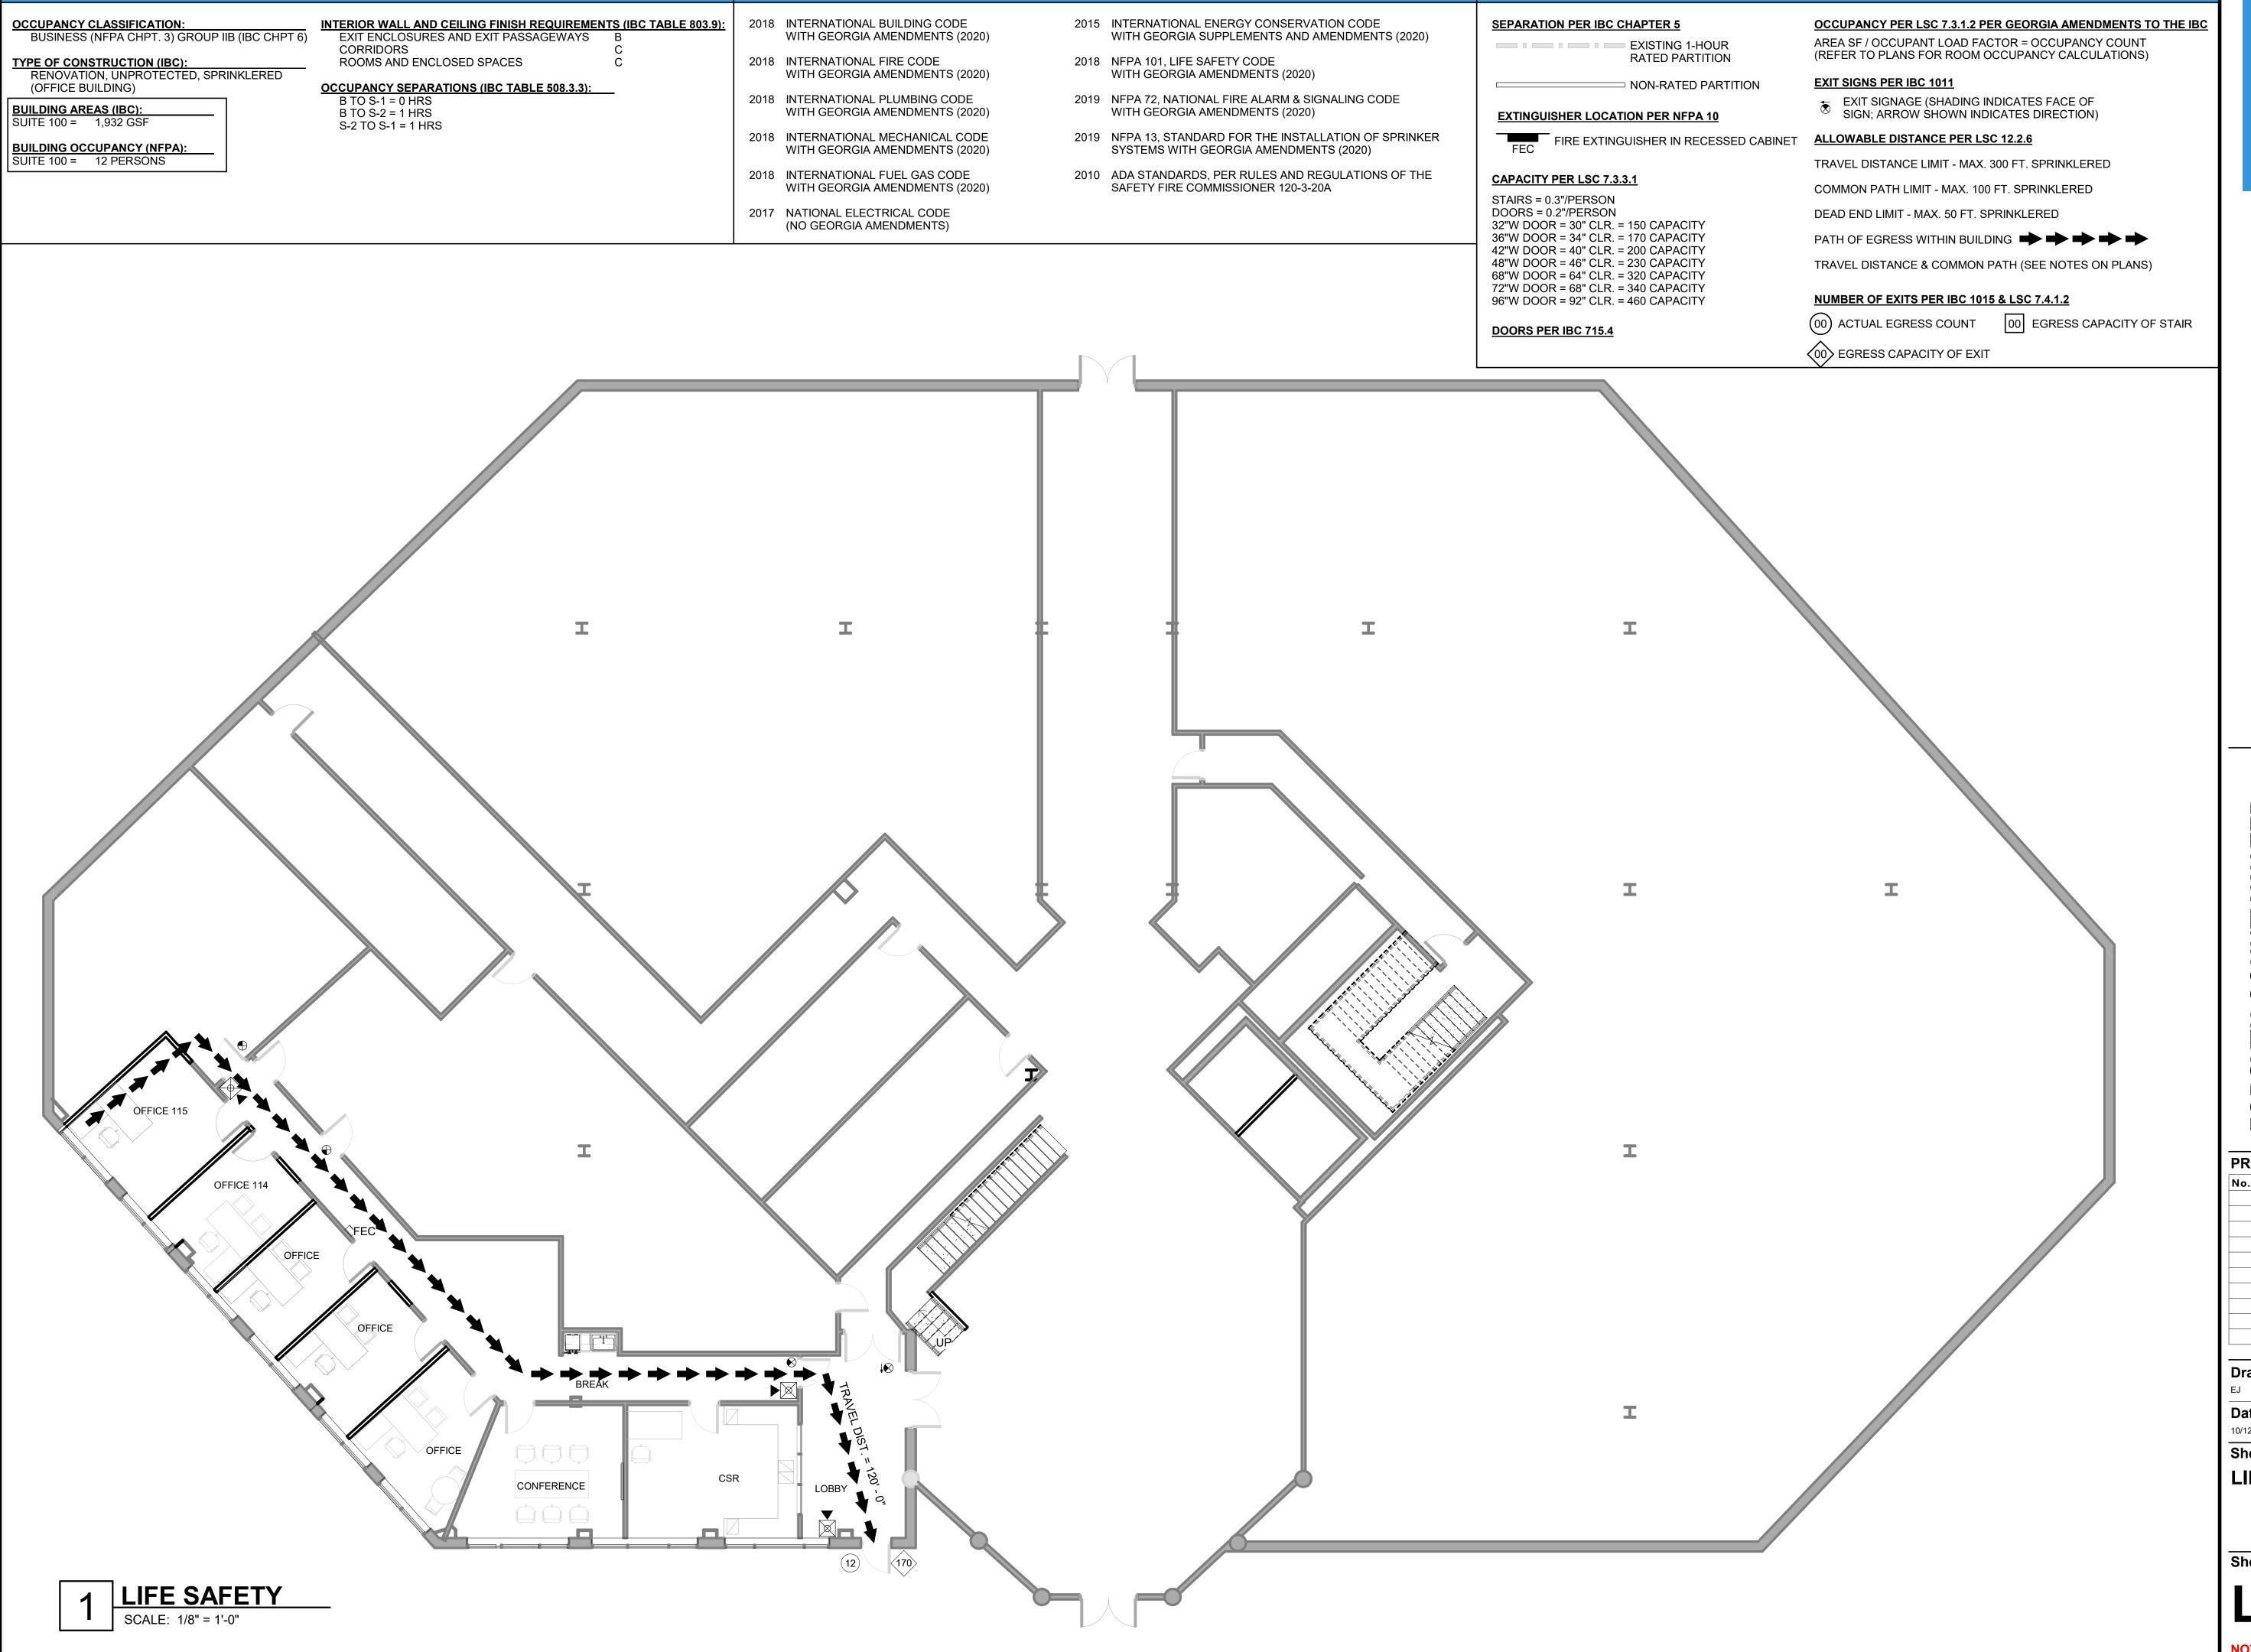

APPLICABLE CODES

BUILDING DATA



LIFE SAFETY PLAN LEGEND

102 Mary Alice Park Road, Suite 103 Cumming, GA 30040



PRINT RECORD DESCRIPTION **Checked By**

Drawn By

Job No.

Sheet Title

LIFE SAFETY

Sheet No.

LS-1.01

NOT TO SCALE

ACCOMPANIED BY GRADE II BRAILLE.

NON-GLARE FINISH.

FOR DIMENSIONS.

5/8"(15.9mm) AND A MAXIMUM OF 2" (51mm) HIGH.

HEIGHT RATIO OF BETWEEN 1:5 AND 1:10.

COMPLIANT WITH PROPORTION CODE.

. CHARACTER TYPE: CHARACTERS ON SIGNS SHALL BE RAISED

1/32"MINIMUM AND SHALL BE SANS SERIF UPPERCASE CHARACTERS

2. CHARACTER SIZE: RAISED CHARACTERS SHALL BE A MINIMUM OF

SYMBOLS AND THEIR BACKGROUND MUST BE 70% MINIMUM AND HAVE A

PROPORTIONS: CHARACTERS ON SIGNS SHALL HAVE A WIDTH-TO-

HEIGHT RATIO OF BETWEEN 3:5 AND 1:1 AND A STROKE WIDTH-TO-

ALL LETTERS MEASURED MUST BE UPPERCASE. AFTER CHOOSING A

TYPESTYLE TO TEST, BEGIN BY PRINTING THE LETTERS I, X AND O AT

WHICHEVER IS NARROWER. IF THE CHARACTER IS NOT SMALLER THAN

THE STROKE OF THE I IS TOO BROAD, AND THE 1:10 RECTANGLE TO SEE

5. BRAILLE: GRADE II BRAILLE SHALL BE USED WHENEVER BRAILLE IS

REQUIRED IN OTHER PORTIONS OF THESE STANDARDS. SEE CHART


IF IT IS TOO NARROW. IF ALL THE TESTS ARE PASSED, THE TYPESTYLE IS

1 INCH, NOR NARROWER THAN THE 3:5 RECTANGLE TO DETERMINE IF

INCH HIGH. PLACE THE TEMPLATE'S 1:1 SQUARE OVER THE X OR O,

3. FINISH AND CONTRAST: CONTRAST BETWEEN CHARACTERS

STRAIGHT

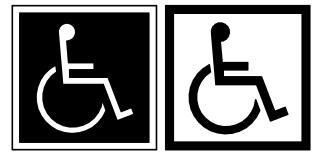

A. SYMBOL PROPORTIONS **B. DISPLAY CONDITIONS**

NOTE:

SCALE: 12" = 1'-0"

CHARACTER WIDTH

100%

B: DOT HEIGHT

SAME CELL

BRAILLE CELL

MEASUREMENT RANGE

TEMPLATE FOR CHECKING CHARACTER AND STROKE WIDTH TO HEIGHT PROPORTIONS

3:5

60%

C: DISTANCE BETWEEN CORRESPONDING

DISTANCE BETWEEN CORRESPONDING

DOTS FROM ONE CELL DIRECTLY BELOW

DOTS IN ADJACENT CELLS

D: DISTANCE BETWEEN DOTS IN THE

SYMBOL SIZE SHALL BE AS SCHEDULED IN SIGN LAYOUT DIAGRAMS. STROKE WIDTH TO HEIGHT RATIO SHALL BE BETWEEN 1:5 & 1:10.

SIGN LETTERS/ NUMBERS WIDTH TO HEIGHT RATIO SHALL BE BETWEEN 1:5 & 1:10.

INTERNATIONAL ACCESSIBILITY SYMBOL

STROKE WIDTH

1:5

20%

ROUNDED DOT

(ACCEPTABLE)

1:10

10%

MIN - MAX

0.059" - 0.063"

0.025" - 0.037"

0.241" - 0.300"

0.090" - 0.100"

0.395" - 0.400"

SQUARED DOT

(NOT ACCEPTABLE)

D3 SCALE: 1/2" - 41.0"

AT THE LATCH SIDE. WHERE A TACTILE

ONE ACTIVE LEAF, THE SIGN SHALL BE

TACTILE SIGN IS PROVIDED AT DOUBLE

WALL SPACE AT THE LATCH SIDE OF A

SINGLE DOOR OR AT THE RIGHT SIDE OF

ON THE NEAREST ADJACENT. SIGNS

TACTILE CHARACTERS, IS PROVIDED

FALL BETWEEN 48" AND 60" AFF

SHALL BE LOCATED TO THE RIGHT OF THE

RIGHT HAND DOOR. WHERE THERE IS NO

CONTAINING TACTILE CHARACTERS SHALL


SPACE OF 18"X18" MIN, CENTERED ON THE


BE LOCATED SO THAT A CLEAR FLOOR


BEYOND THE ARC OF ANY DOOR SWING


BETWEEN THE CLOSED POSITION AND 45


DEGREE OPEN POSITION. WHEN MOUNTED, RAISED CHARACTER BASE LINES MUST

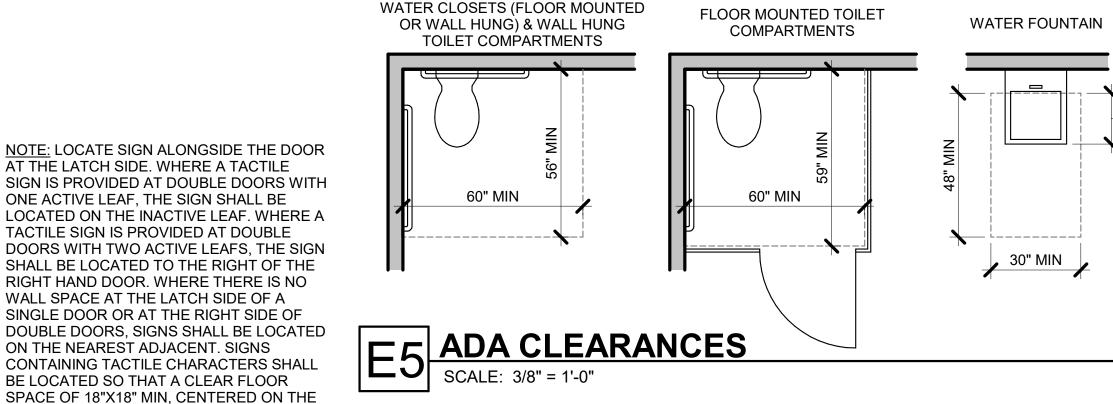

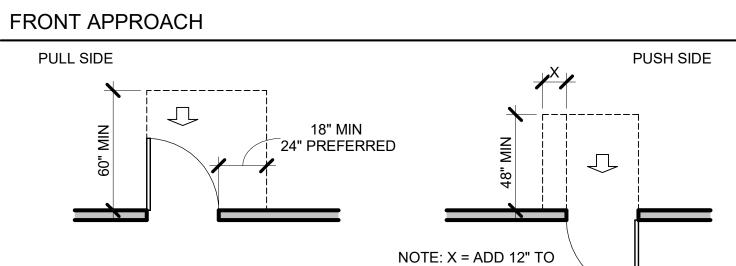


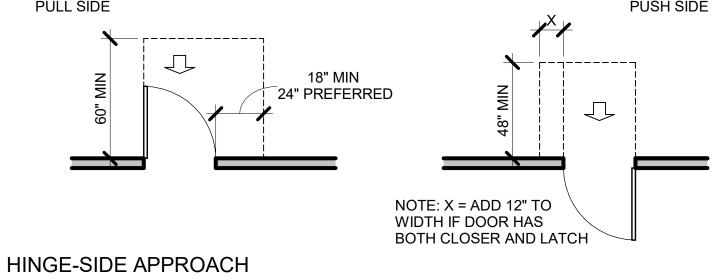

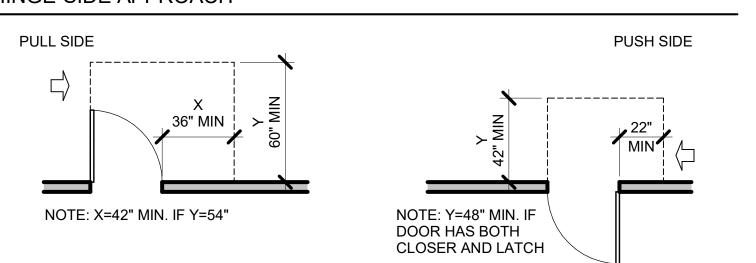

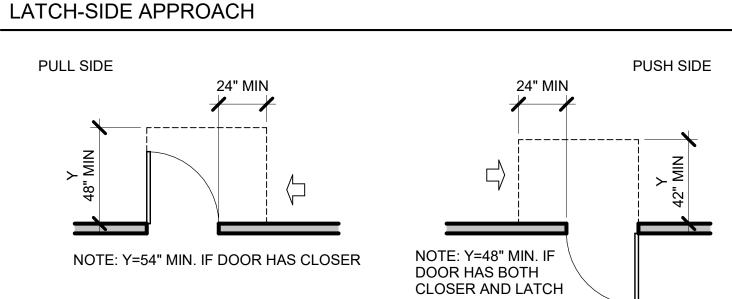

B5 DOOR CLEARANCES

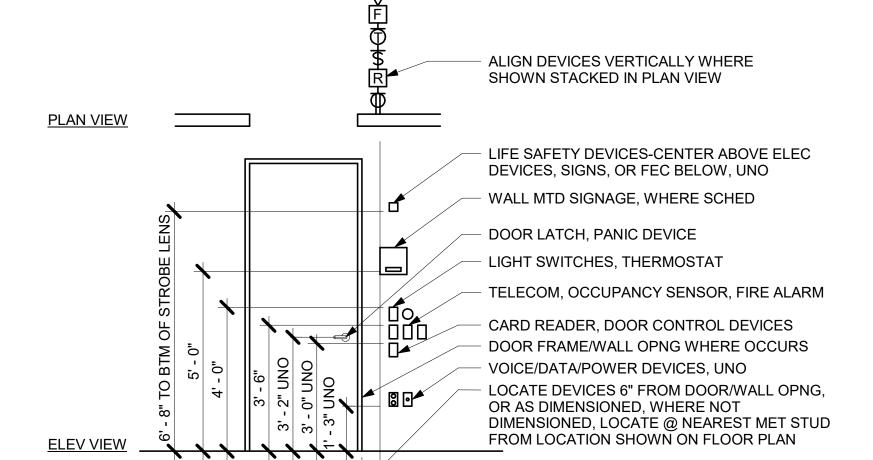



DEVICE ALIGNMENT DIAGRAM



GENERAL PARTITION NOTES

- 1. STUD DESIGN CRITERIA: ALL INTERIOR, NON-LOAD BEARING METAL STUDS SHALL BE 20 GAUGE (MIN.) UNLESS OTHERWISE NOTED. PROVIDE 5 PSF MIN. APPLIED LATERAL LOAD, L/240 MAX. DEFLECTION.
- 2. ALL FIRE RATED PARTITIONS MUST EXTEND AND SEAL TO STRUCTURE ABOVE. 3. INSTALLATION OF GYPSUM BOARD, BACKER BOARD AND BASE BOARD SHALL CONFORM TO REQUIREMENTS FOR FIRE RATINGS

SUGGESTED WORDING '(--) HOUR FIRE AND SMOKE BARRIER - PROTECT ALL OPENINGS'.

- AND ACOUSTICAL RATINGS. 4. PROVIDE WATER RESISTANT TYPE GYPSUM BOARD AT AREAS THAT ARE NOTED IN ROOM FINISH SCHEDULE TO RECEIVE CERAMIC
- OR PORCELAIN TILE FINISH INCLUDING RESTROOMS
- PROVIDE 5/8" GYPSUM BOARD UNLESS OTHERWISE NOTED. 6. PROVIDE 5/8" TYPE X GYPSUM BOARD AT FIRE RATED PARTITIONS.
- 7. METAL STUD GAUGE (IF NOTED) AND UL TEST NUMBERS WILL VARY DEPENDING ON THE MANUFACTURER OF COMPONENTS ACTUALLY USED.
- 8. PENETRATIONS IN RATED PARTITIONS AND CONNECTIONS OF THE PARTITIONS TO OTHER PORTIONS OF THE WORK SHALL BE IN ACCORDANCE WITH MANUFACTURER'S RECOMMENDED DETAILS AND IN COMPLIANCE WITH APPLICABLE TESTING AGENCY
- 9. INSTALL BLOCKING OR BACKER MATERIAL FOR ATTACHMENT / MOUNTING OF WALL HUNG ITEMS, ACCESSORIES, FIXTURES, FURNITURE OR EQUIPMENT DESCRIBED IN THE DOCUMENTS. PROVIDE BLOCKING TO MATCH THE OVERALL HEIGHT AND WIDTH OF ALL WALL MOUNTED MONITORS AND TVS.
- 10. WHEN INSTALLING GYPSUM BOARD, CONTRACTOR SHALL COMPLY WITH REQUIREMENTS OF THE MOST CURRENT EDITION OF THE GYPSUM ASSOCIATION "GA-600" FIRE RESISTANCE DESIGN MANUAL AND THE MOST CURRENT EDITION OF THE UL FIRE RESISTANCE
- 11. PARTITIONS THAT ARE REQUIRED TO EXTEND TO THE DECK ABOVE SHALL HAVE THE GYPSUM BOARD CUT TO FIT WITHIN A 1/4" MAXIMUM TOLERANCE TO THE SHAPE OF THE DECK ABOVE. GYPSUM BOARD SHALL BE CONTINUOUSLY SEALED FOR THE FULL DEPTH OF THE GYPSUM BOARD WITH FLEXIBLE SEALANT.
- 12. GYPSUM BOARD SHALL BE CUT SO THAT THE CLEARANCE BETWEEN METALLIC ELECTRICAL OUTLET BOXES AND THE GYPSUM BOARD DOES NOT EXCEED 1/8".
- 13. THE BOTTOM OF THE GYPSUM BOARD AT INTERIOR PARTITIONS SHALL BE 1/4" MINIMUM AND 1/2" MAXIMUM ABOVE THE CONCRETE FLOOR SLAB AND SHALL BE SEALED FOR THE FULL DEPTH OF THE GYPSUM BOARD WITH FLEXIBLE SEALANT. 14. REFER TO THE LIFE SAFETY FLOOR PLANS FOR EXTENT OF FIRE WALL RATINGS.
- 15. ALL ELEMENTS OF ACOUSTIC RATED PARTITIONS SHALL EXTEND TO ROOF STRUCTURE OR FLOOR DECK ABOVE. 16. PARTITION TYPES DESCRIBE GENERAL REQUIREMENTS FOR PARTITIONS. REFER TO THE MANUFACTURER'S SPECIFICATIONS AND
- REQUIREMENTS OF APPLICABLE TESTING AGENCIES FOR SPECIFICS OF PARTITION CONSTRUCTION. 17. WHERE A CLEAR DIMENSION OR OPENING IS REQUIRED OR NOTED, MEASURE DIMENSION TO FACE OF PARTITION FINISH. 18. REFER TO INTERIOR FINISH SCHEDULE FOR ALL WALL FINISHES.
- 19. ALL FIRE AND/OR SMOKE BARRIERS OR WALLS SHALL BE EFFECTIVELY AND PERMANENTLY IDENTIFIED WITH SIGNS OR STENCILING ABOVE A DECORATIVE CEILING AND OR IN CONCEALED SPACES WITH LETTERS A MINIMUM OF TWO (2) INCHES HIGH ON A CONTRASTING BACKGROUND SPACED A MAXIMUM OF TWELVE (12) FEET ON CENTER WITH A MINIMUM OF ONE PER WALL OR BARRIER IN ACCORDANCE WITH MODIFICATIONS OF THE 2006 STANDARD FIRE PREVENTION CODE, 120-3-3, CHAPTER 5 OF THE RULES AND REGULATIONS OF THE FIRE SAFETY COMMISSIONER. THE HOURLY RATING SHALL BE INCLUDED ON ALL RATED BARRIERS AND WALLS

102 Mary Alice Park Road, Suite 103 Cumming, GA 30040



No.	DATE	DESCRIPTION
	11/04/2021	Permit Drawings


Drawn By	Checked By
EJ	JDG
Date	Job No.
11/04/2020	20005


Sheet Title ADA REGULATORY

DETAILS, DIAGRAMS & PARTITION TYPES


Sheet No.

NOT RELEASED FOR CONSTRUCTION

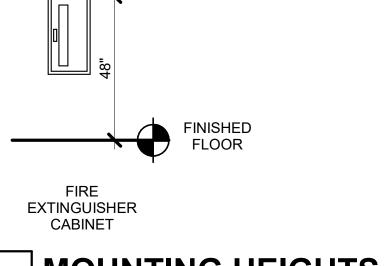

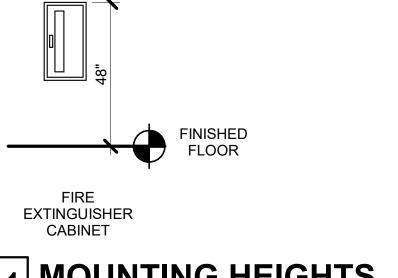

MOUNTING HEIGHTS

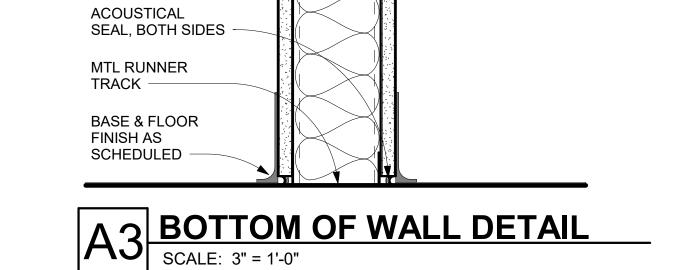

01 20 00 PRICE AND PAYMENT PROCEDURES

A. Applications for Payment shall utilize AIA G702, "Application and Certificate for Payment" including required continuation sheets. Approved Schedule of Values shall be used in the same format and values.

B. Submit three copies of each application.

C. When Architect or Owner's Representative requests substantiating information, submit data justifying

D. Submit to the Architect or Owner's Representative for review and approval a Schedule of Values, at least ten consecutive business days prior to submitting first Application for Payment, utilizing AIA Document G703, "Continuation Sheet".

E. Use Project Specification headings as basis for format for listing costs of work under Divisions 02 - 49. Additional breakdown of work in certain sections may also be provided or required if needed or requested by the Architect or Owner's Representative.

01 30 00 ADMINISTRATIVE REQUIREMENTS

A. Contractor shall schedule and administer pre-construction meeting, periodic progress meetings, and specially called meetings throughout the work progress.

B. In order to provide for a regular review and evaluation of the Work and a systematic discussion of problems, the Owner's representative, Architect (if included in CA scope) and General Contractor shall meet at a mutually agreed schedule during the construction period. Representatives of contractor, subcontractors, and suppliers shall attend on an as needed basis. Contractor shall prepare agenda for meetings, make physical arrangements, preside, record minutes, and distribute copies of minutes within three days to those in attendance, those affected by decisions, the Owner's Representative, and the Architect, if he is involved during the construction.

C. Owner and Architect may attend meetings to ascertain work is expedited consistent with Contract Documents and construction schedules.

D. The Contractor's relations with his subcontractors and materials suppliers and discussions relative thereto, are the Contractor's responsibility and will not be part of the project meeting content.

E. To the maximum extent practicable, meetings will be held at the job site.

F. Contractor shall apply Contractor's stamp, signed or initialed in blue ink, certifying that review, approval, verification of products required, field dimensions, adjacent construction work, and coordination of information is in accordance with the requirements of the work and contract documents

G. Submit sufficient quantities of project data and shop drawings for Architect or Owner's Representative to retain two copies and for one copy to be retained by Contractor and turned over to the Owner at the completion of the Project.

H. Submit sufficient quantities of samples for Architect or Owner's Representative to retain one copy. Review of submittals is only for conformance with design concept of Project and information in Contract Documents.

I. Maintain an orderly file of submittals bearing the Architect's or Owner's Representative's review stamp for the Project duration at Project site and deliver to Owner as part of Project closeout documents.

J. Maintain at the site for the Owner, one record copy of drawings and specifications, addenda, change orders, construction change directives, approved shop drawings, product data, and samples, field test reports, and RFI documents.

K. Store in Contractor's field office in file cabinets or racks for storage of documents. Using record documents for construction purposes is prohibited. Label each document "PROJECT RECORD" in large printed and legible letters.

L. If applicable, on drawings legibly mark to record actual construction including depth of foundations, vertical and horizontal locations of underground utilities, field changes of dimension or detail, and any other changes including change orders.

M. It is the responsibility of the General Contractor to maintain the "as built" set of contract documents. These will serve as the as-built record recording all field built conditions and made part of the closeout

01 32 16 CONSTRUCTION PROGRESS SCHEDULE

A. Promptly after award of Contract, Contractor shall prepare and submit to Architect or Owner's Representative estimated construction progress schedules for construction activities.

B. A formal "Notice to Proceed" will be issued to mark commencement of project.

C. Progress schedules shall include complete sequence of activity, dates for beginning and completion of each element; show accumulated percentage of each item's completion and total percentage of work

D. Submit initial schedule with 15 days of Contract award. Submit revisions as needed to show major changes in scope or other identifiable changes.

E. Contractor shall submit samples, shop drawings, and product data to Architect or Owner's Representative as required by the specification sections below.

01 40 00 TESTING LABORATORY SERVICES

A. If required for the project, the Owner shall employ and pay for services of independent testing laboratory acceptable to Architect or Owner's Representative to perform specified services and testing.

01 43 30 SPECIAL INSPECTIONS

A. If required for the project, the Owner will retain the services of a qualified licensed Architect or Engineer to serve as 'Special Inspector(s)' to perform inspections pursuant to the Statement of Special Inspections scheduled on the drawings. Approved Special Inspector(s) shall provide testing and verification reports to Owner, architect, building official, and structural engineer of record which indicate the inspected work was done in conformance with approved construction documents.

01 50 00 TEMPORARY FACILITIES, CONTROLS, AND UTILITIES

A. Temporary construction office - provide all temporary facilities as required to build this project with sufficient space for Contractor's personnel, telephone/fax, and office space complete with desk and layout board.

B. Temporary storage facilities - if required, provide with weathertight, secure storage sheds or trailers, type and size required for storage. Locate where directed by Owner. Owner is not responsible for securing the temporary storage facility and any theft or loss that may occur.

C. Electrical service – Terms to be discussed prior to execution of contact between Owner and General Contractor. Electrical for construction purposes may be obtained from Owner's present facility, coordinate with Owner's Representative. Provide temporary lighting for construction purposes as required by OSHA or local code.

D. Telephone/Wi-Fi/Fax - provide telephone, telephone message service, Wi-Fi and fax service to the temporary construction office.

E. Temporary heat and ventilation - Maintain spaces in range of 600 F to 800 F, unless product manufacturer for a particular product calls for more stringent requirements. Interior renovation within an existing building, maintain spaces in range of 60o F to 80o F, unless product manufacturer for a particular product calls for more stringent requirements.

F. Water service - Terms to be discussed prior to execution of contact between Owner and General Contractor. Water for construction purposes may be obtained from Owner's present facility, coordinate with Owner's Representative.

G. Sanitary toilet facilities - Provide and maintain temporary toilet facilities and enclosures for construction personnel. Using permanent new or existing facilities in the building is prohibited by construction personnel.

H. Project sign - order and erect or position sign as requested by Owner's Representative, or as indicated in the Construction Documents. Coordinate location with Owner's Representative.

01 60 00 PRODUCT REQUIREMENTS

A. Provide new products unless specifically required or permitted by Contract Documents.

01 70 00 EXECUTION AND CLOSEOUT REQUIREMENTS

A. Clean-up during construction - execute cleaning procedures to ensure building interior, project site, and adjacent properties are maintained free from construction debris and rubbish. Maintain site, both exterior and interior, in clean and orderly condition. Provide covered, on-site containers for waste

B. Final cleaning - clean finish surfaces in accord with manufacturer's product data and requirements specified in sections not more than 48 hours prior to Date of Substantial Completion. Remove dust, debris, oils, stains, fingerprints, manufacturer's product labels and temporary labels from exposed interior and exterior finish surfaces, include washing and polishing interior and exterior glazing materials, vacuum carpeted and soft surfaces. Broom clean paved surfaces. Protect, maintain and clean inside of all HVAC supply and return ductwork free from dust and debris, and install new clean set of HVAC system filters not more the 48 hours prior to Date of Substantial Completion. Clean plumbing fixtures. Replace spent lamps and bulbs and clean lighting fixtures to "like-new" condition.

C. Submit operation and maintenance manuals - submit at issuance of Date of Substantial Completion or 15 days prior to final inspection whichever date is earlier. Submit in duplicate, in 8 1 /2" x 11-inch format in D size ring binders with plastic Covers including an electronic version of all documents in PDF format on a CD. Internally divide with permanent page dividers logically organized. Include:

1. Part 1 - Directory: list names, addresses, telephone numbers of Architect, Contractor, subcontractors, major equipment suppliers, and local service for major equipment.

2. Part 2 - Operation and Maintenance Instructions: arrange by system further subdivided by specification section and include significant design criteria, equipment list, component parts list, operating instructions and maintenance instructions.

3. Part 3 - Project Documents and Certificates: include shop drawings and product data, air balance reports, certificates, and photocopies of warranties and bonds.

D. Certificates from governing code authorities/AHJ indicating construction has been inspected as required by laws or ordinances and building is approved for occupancy.

E. Warranties - Provide executed warranty in writing, indicate Date of Substantial Completion and warranty expiration date. Warranty period begins on Date of Substantial Completion and continues for one year unless otherwise indicated in individual specification sections or otherwise provided by individual manufacturers' warranties.

F. Record Documents - Provide set of Record Documents with final Application for Payment. This includes a scanned copy of the as-built set of contract documents identifying, including but not limited to, all Bulletins, RFI's Change Orders and field conditions.

G. Tools, equipment, spare parts, extra material, attic stock and related items as required in specification sections at final Application for Payment

H. Fire extinguishers - Verify extinguishers are charged and ready for use, provide attached tag indicating date tested and by whom.

I. Keys - Construction keying shall be voided or change out cylinders that utilize construction keying. Deliver at Date of Substantial Completion to Owner's Representative keys with each tagged indicating lock which key operates. The Owner shall provide the General Contractor with Keying schedule unless directed otherwise by the Owner.

J. Maintenance training – provide a training class for each of the primary systems. Training class shall include Owner and/or Owner's designated representative. General Contractor shall video tape training class for archiving and reference by the Owner and/or Owner's designated representative.

FOR THE FOLLOWING MATERIAL SPECIFICATIONS. REFERENCE AND COMPLY WITH THE MANUFACTURER'S PRODUCT LITERATURE, SPECIFICATIONS, AND WRITTEN INSTRUCTIONS ON INSTALLATION UNLESS OTHERWISE NOTED.

02 41 00 BUILDING DEMOLITION

A. Comply with the most recent applicable codes for demolition of structures, safety of adjacent structures, noise control, and dust control. Obtain required permits, notify affected utility companies and comply with their requirements, conform to regulatory procedures when hazardous or contaminated materials are discovered, and do not close or obstruct roadways without permits.

B. Suspend operations immediately if hazardous or contaminated materials such as asbestos or polychlorinated biphenyl), not previously rendered harmless, are encountered, contact Architect and Owner in writing. Do not resume operations until directed, hazardous or contaminated materials have been rendered harmless, and conditions are agreed to by Owner and Contractor in writing.

C. Provide and maintain temporary barriers and security procedures as required to protect property and people and to meet the requirements of the General Conditions. Protect existing landscaping, appurtenances and structures that are not to be demolished. Prevent movement or settlement of adjacent structures. Provide bracing and shoring. Mark location of all utilities prior to proceeding with scope of work.

D. Minimize interference with adjacent structures and public or private access. Maintain protected egress and access at all times. Obtain written permission from adjacent property Owners when demolition equipment will traverse or infringe upon their property. Suspend operations immediately if adjacent structures appear to be in danger, contact Architect and authority having jurisdiction, do not resume operations until directed. Provide hoses and water connection to sprinkle demolition area with water to minimize dust. It is the sole responsibility of the General Contractor to confine duct and odors to construction area and quickly remediate any breeches in containment.

06 10 00 ROUGH CARPENTRY

A. Lumber shall be #2 Southern Pine or Western Lumber. Miscellaneous furring and nailers shall be utility grade Southern Pine. Nailers and blocking associated with roofing and flashing systems shall be preservative and fire-retardant treated. Exterior plywood shall be CC-EXT-APA, Group I. Interior plywood shall be A-D, INT-APA, Group 1. Fire-retardant-treated wood.

B. Provide concealed blocking, nailers, and supports for securing applied fixtures and fittings; specific items to be indicated on the drawings.

C. Provide concealed blocking, nailers, and supports for securing base cabinets and wall mounted cabinets to partitions. Reference drawings for locations of base and wall mounted cabinets.

D. Provide concealed blocking, nailers, and supports for securing video/t.v./monitors to partitions. Reference drawings for locations of wall mounted video/t.v./monitor locations.

E. Backboards at phone equipment shall be 3 /4" fire treated plywood, painted face and all exposed edges. Sand, prime and ease all edges prior to painting.

F. Nailing schedule shall be in accord with current edition of International Building Code.

G. Install rough carpentry work cut square on bearings, closely fitted, accurately set to required lines and levels and secured in place. Brush apply preservative treatment to cut ends of treated lumber. Coordinate location of blocking and nailers with locations of finishing materials, fixtures, specialty items and trim. Install plywood with face grain perpendicular to supports. Terminate panels over supports, allowing 1/8" between end joints and 1/4" between edge joints for expansion and contraction.

A. Coordinate and install millwork provided by Tenant, and as indicated on drawings.

B. Installer must have a minimum of five years' experience in the same field and be able to demonstrate successful projects that meet the specified AWI grade.

C. Source Quality Control: Obtain materials for each type, including veneer doors, from a single manufacturer or source so as to ensure matching of quality, color, grain, and finish.

D. Quality standards for the following types of architectural woodwork, "Premium Grade" except as modified, as follows:

- Standing trim, running trim, and rails: AWI Section 300, Custom Grade.
- 2. Architectural cabinets, laminate clad: AWI Sections 400 for Flush Overlay and 400B, Premium
- 3. Architectural cabinet tops: AWI Sections 400 for High Pressure Decorative Laminate tops and
- 400C, Custom Grade
- 4. Shelving: AWI Section 600, Custom Grade. 5. Paneling: AWI Section 700.
- 6. Miscellaneous ornamental items: AWI Section 700.
- Stile and rail doors: AWI Section 1400.

8. Factory Finishing: AWI Section 1500.

treatment that will not adversely affect the desired finish and appearance. F. Project Conditions: Stabilize humidity and temperature at normal operating Conditions at least seven

E. Wood Treatment: Where fire-retardant treated woodwork is indicated, use approved fire-retardant

(7) calendar days prior to installation and thereafter. G. Installation: Meet AWI standards for quality standards and premium construction for tolerances. Scribe and cut work to fit adjoining work, refinish cut surfaces and repair damaged finish at cuts. Anchor casework to anchors or blocking built-in or directly attached to substrate. Secure to grounds, stripping,

H. Lumber (Verify all species selections with drawings):

1. Exposed and semi-exposed painted millwork and trim: Custom Grade Poplar or Custom Grade White

and blocking with countersunk concealed fasteners and blind nailing as required for a complete

2. Interior standing and running trim: Custom Grade Poplar or Custom Grade White Pine, kiln dried. Install in single, unjointed lengths for openings and runs less than 16'-0". Stagger joints in adjacent members. Cope at returns, miter at corners.

I. Hardware

- 1. Door and drawer pulls to be 4" matt nickel stainless steel.
- 2. Concealed hinges to be Grade 2 (Institutional duty), 170 degrees opening 3. Door and drawer locks: provide elbow catches on un-keyed leaf of pair of doors. If electronic
- push button, provide battery operated with low battery indicator. 4. Drawer Slides to be full extensions slides; 100lb per slide per standard drawer, 150lb per slide
- per standard file drawer and 250lb per lateral file drawer. 5. Shelf standards to be same color as cabinet interior.

J. Countertops shall have 1-1/2" radiused corners as indicated on drawings, U.N.O.

07 21 00 THERMAL INSULATION

A. Batt insulation shall be fiberglass batts width equal to framing spacing, kraft face, ASTM C665, Type II Class C, 1.0 perm rating, R-13 in walls.

B. Rigid extruded polystyrene insulation shall be extruded, closed cell, CFC-12 free, polystyrene boards meeting ASTM C578, Type IV for use in perimeter and other applications, thickness 2" or as scheduled

C. Safing Insulation – shall be unfaced, semi-rigid, 4 pcf minimum. Install in cavities of all floor-to-floor penetrations; include spaces around piping and duct penetrations. Foam safing may be used in lieu of

D. Sound insulation - refer to Section 09 21 16 Gypsum Board Assemblies.

E. Provide continuous 1 /4" foam tape filler where walls meet window mullions. Provide double foam tape fill at demising wall between tenants, intersecting partitions and demising walls.

07 84 00 FIRE STOPPING

Fire stopping shall be single component self-adhering, flexible, water-tight, non-sag, elastomeric silicon or endothermic latex compound. Provide firestopping as required to maintain ratings at all penetrations through rated walls, partitions, floors and floor-ceiling assemblies. Fire-stopping to comply with Underwriters Lavatory testing numbers where apply.

07 90 05 SEALANTS AND CAULKS

and interior door and window frames perimeter.

Exterior joints and all other openings in the building shall be caulked, gasketed, weather-stripped, or sealed in an approved manner (ref. Georgia State Energy Code, Section 502.4). Seal all sound partitions with acoustical sealant at base, head, perimeter and all openings.

A. Silicone sanitary sealant, SSS-1, one-part silicone rubber, mildew and stain resistant, ASTM C920, Type S, Grade NS, Class 25. Use at plumbing fixture perimeters mounted on walls and top and edges of backsplashes at countertops.

B. Two-part non-sag polyurethane sealant, PSV2-1, two-part polyurethane based sealant with separate prepackaged color agent to achieve colors, ASTM C920, Type M, Grade NS, Class 25. Use at exterior

C. Caulking compound for setting thresholds and for other interior caulking shall be an oleo-resinous, gun grade, non-staining plastic compound meeting Federal Specification TT-T-598. Material shall have shrinkage factor not exceeding 15%.

D. Acrylic-latex caulk, ALC-1, flexible paintable, non-staining, non-bleeding acrylic emulsion, ASTM C834. Use at interior non-working cosmetic joints between similar and dissimilar adjacent materials.

E. Butyl caulk, BC-1, one part butyl rubber caulk, ASTM C1085, black. Use continuous double bead at sill or threshold of exterior swinging doors.

F. Backer rod, compressible rod stock closed cell foam, open cell foam, soft cell foam, or neoprene foam, type recommended by sealant manufacturer for material compatibility and conditions encountered.

08 11 00 STEEL DOORS AND FRAMES

A. Exterior steel doors and frames to be Building Standard.

B. Materials include steel, ASTM A366, cold rolled steel sheet free of scale, pitting, or surface defects; exterior frames and doors, ASTM A525, zinc coated, coating designation G60; and primer, one coat manufacturer's standard baked-on enamel rust-inhibitive primer to pin hole free.

C. Frame construction shall be factory primed, pressed steel, frames for doors and other indicated openings. Exterior door frames shall be 16-gauge, face welded, seamless with joints filled and weatherstripping per Section 08710. Interior frames shall be knock down "KD" type frames, and 16-gauge. All frames shall have labels for labeled openings as required, with standard rubber, neoprene, or silicone

D. Provide manufacturer's standard frame anchors for attachment to studs at 2'0" o.c. max or fraction

E. Door construction for exterior units shall be Grade II, Heavy Duty, seamless composite construction, 16-gauge material, with 20 PSI compressive strength foamed-in-place polyurethane core.

F. Submit manufacturer's product data and shop drawings indicating door and frame elevations, sections, materials, gauges, finishes, fabrication and erection details, location of finish hardware by dimension, and details of openings and louvers.

G. Provide metal drip at exterior door frames which have no alternative cover.

08 14 16 FLUSH WOOD DOORS A. Industry standards are those of the National Wood Window and Door Association (NWWDA) and the Architectural Woodwork Institute (AWI). Fire-rated wood doors shall bear label of testing and approval by independent testing agency, having been tested in accord with UBC 7-2-1997 or UL 10-C for ratings

B. Wood doors shall be solid, particle board core, 1-3/4" thickness, meeting NWMA I.S.-1. minimum fiveply, 1-3/4" thickness. Core shall have min. 28 pcf density. Premium Grade, with "Plain-Sawn" White Oak" face veneers and edges; veneers book matched across door face; full length. Plastic laminate veneer doors shall consist of .050" high pressure decorative laminate. Conform to NEMA Standard LD-3-1980, Grade GP 50. Fire rated doors shall be rated as shown on the drawings, with factory installed labels. Fire rated doors shall have reinforced edges to accept full mortise hinges.

C. Execution: install doors in respective frames using specified hardware. Doors shall operate without binding or sticking at frames or floor. Maintain NWWDA and NFPA No. 80 standard tolerances.

D. Submit shop drawings indicating door species, finish, sizes, construction, and hardware locations.

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C. Anchor securely in place; install plumb, level and in true alignment. Isolate dissimilar materials to prevent corrosion.

D. Coordinate with glass and glazing work; install hardware and adjust for smooth, proper operation. E. Clean and protect completed system; repair damage.

08 71 00 DOOR HARDWARE

All exterior (if applicable) and interior doors shall comply with NFPA 101 Life Safety Code 2012 Edition and current Georgia Accessibility Code). Doors shall be provided with handicap accessible hardware including levers, panic hardware, u-shape designed devices, closers, etc.

A. If applicable - building exterior or suite entry door, door hardware to be Building Standard.

B. Interior door hinges, interior locksets and latchsets to be Building Standard or as directed by Owner, Hospital push/pull latches to be ABH Manufacturing or equal, interior door closers to be Building Standard, overhead door stop to be Glynn-Johnson, wall stops to be Burnes or equal.

C. Flush bolts, door silencers, kick plates, armor plates and panic exit device to be Building Standard or as directed by Owner.

D. Obtain each type of hardware from a single manufacturer. Hardware supplier shall be a recognized architectural door hardware supplier that employs an experienced architectural hardware consultant (AHC) who is available to Owner, Architect, and Contractor for consultation. Submit proposed hardware schedule developed by AHC organized into hardware sets for each door or opening to Owner's Representative for review and approval prior to ordering hardware.

E. Material and finishes: Coordinators - 600 (USP), Other items 630 (US32D) or 626 (US26D) if not commercially available. Architect to select finial color.

F. Warranty door hardware for one-year period and door closers for ten-year period.

G. Hinges, provide full mortise hinges, heavy duty ball bearing butts with non-rising stainless-steel pins, exterior doors non-removable pins, 4 1/2" by 4 1/2" unless otherwise required for proper operation, 3 hinges per door leaf minimum, Continuous hinge to be placed on doors 3'-6" wide and over door leafs. Aluminum hinge at all non-rated doors, stainless steel hinge at rated doors. Acceptable manufacturers are Hager Hinge Company, Lawrence Brothers, Stanley Works and Marker Products, 100/300 series.

H. Lock cylinders and keying, supplier will meet with Owner to finalize keying requirements. Master key the locks to Owner's current or new system. Cylinders shall be manufacturer's standard 6-pin tumbler cylinders, constructed from brass/bronze, stainless steel or nickel silver. Furnish 2 change keys for each lock and 6 master keys.

 Locksets, latchsets, and specialty locks shall be Building Standard (unless directed by the Owner), heavy-duty commercial cylindrical type, 2 3/4" backset. Lever to be Building Standard (unless directed by the Owner). Furnish locksets and latchsets with sufficient strike lip to protect door trim.

J. Surface mounted door closers shall be Building Standard. Provide closers as shown on door schedule. Powder coat finish to match adjacent door hardware.

K. Stops and Holders: overhead door stop shall be Glynn-Johnson series 90 and/or 100, wall stop to be Burnes 565 and floor stop to be 535. Where practical use wall stops unless noted otherwise on drawings. Other acceptable manufacturers are Rockwood Manufacturing and H.B. Ives. Provide stops at all doors.

J. Flush bolts shall have a 3/4" throw, complete with dust-proof bottom and top strike plate to be Building Standard (unless directed by the Owner).

K. Kickplates shall be Rockwood Manufacturing, K1050 series. kickplates shall not more than 1-1/2" less than door width on stop side and not more than 1/2" less than door width on pull side. Armor plates to be shall be Rockwood Manufacturing, K1050A-6 series.

L. Thresholds shall be National Guard Products Inc., #425, extruded smooth mill finish. Other acceptable manufacturers are Reese and Zero Weatherstripping Company. Provide at all exterior doors.

L. Weatherstripping shall be National Guard Products Inc., #133 SA door seals and #200SA door bottom seals. Other acceptable manufacturers are Reese and Zero Weatherstripping Company. Provide at all hollow metal exterior doors.

08 80 00 GLAZING

Provide glazing systems capable of withstanding normal thermal movement and impact loads (where applicable) without failure, including loss or glass breakage attributed to the following: defective manufacture, fabrication, installation, failure of sealants or gaskets to remain watertight and airtight, deterioration of glazing material and other defects in construction.

A. Clear wired glass: 1/4" thick polished both sides, diamond mesh and listed by U.L as fire resistive.

B. Fire rated clear glass: Thickness varies - see wall rating or door label for fire rating. Ultra-clear fire rated glass laminated with intumescent interlayer. Permanent U.L label to be displayed.

C. Clear float glass: 1/4" thick unless noted otherwise on the drawings, grade "B" fully tempered, style "I'

D: Glass shelving: 3/8" thick, grade "B" fully tempered, style "I" uncoated with eased and polished edges. See drawings for locations.

E. Clear tempered float glass: 1/4" or 1/2" thick polishes sides; refer to drawings for thickness. Incorporate glazing tape, glazing compounds, setting blocks, spacers and glazing gaskets recommended or accepted by both the glass manufacturer and the manufacturer of the product into which the glazing product is to be installed.

F. Mirrors: 1/4" thickness, unframed, edges polished.

G. Provide setting blocks, jamb spacers, spacers, gaskets, glazing sealants and other accessories as required to complete installation.

09 21 16 GYPSUM BOARD ASSEMBLIES

All gypsum board systems shall be in accordance with recommendations and instructions published by U.S. Gypsum Company's "Gypsum Construction Handbook", latest edition.

A. Non-loadbearing metal framing materials: Metal framing shall be cold-rolled, galvanized steel studs and runners, stud gauge as required by manufacturer's product data for heights and conditions of use; maximum deflection of I/240; sizes indicated.

B. Gypsum board: Exterior gypsum sheathing shall be moisture and fire-resistant type, thickness as indicated, with square edges. Standard gypsum board shall be 5/8" thickness, tapered edges. Fire retardant gypsum board shall be Type 'X', 5/8" thickness, tapered edges. Provide Dens-Shield DS012 gypsum board (or equal) at all non-tile wet walls. Provide Dens-Shield DS001 gypsum board (or equal) at all wet walls to receive ceramic tile. Minimize butt end joints, especially in highly visible locations. Use screws for attachment of all gypsum board.

C. Acoustic ceilings: 6" x 20 GA metal joists, or as otherwise indicated on drawings at 16" o.c. with denim batt acoustic insulation. Sheath with 1/2" sound board with applied mass loaded vinyl sound barrier adhered with Green glue. Provide 3/4" gypsum wall board metal clips @ 16" on center, horizontal, screwed to mass loaded vinyl. Overlay with 5/8" gypsum wall board applied to clips, tape and spackle all joints. Finish with batt insulation and acoustical ceiling tile system as indicated on drawings.

D. Acoustic partitions: 3 5/8" x 20 GA metal studs at 16" o.c. with denim batt acoustic insulation. Sheath with 1/2" sound board with applied mass loaded vinyl sound barrier adhered with Green glue. Provide 3/4" gypsum wall board metal clips @ 16" on center, horizontal, screwed to mass loaded vinyl. Overlay with 5/8" gypsum wall board applied to clips, provide level 5 finish.

E. Joint tape, perforated type recommended for board type use. Joint compound, ready mixed tape embedment and topping compounds, type recommended for board type use.

F. Sound Attenuation Blankets: for partition and ceiling cavities, sound blankets shall be unfaced mineralfiber blanket insulation manufacturered from slag wool or rock wool with thermosetting resins to comply with ASTM C665. Blankets shall have a minimum density of 2.5 pcf, 1-1/2" thickness.

G. Tape fill, and sand exposed joints, edges, and corners to produce smooth surface ready to receive finishes. Feather coats of joint compound so that camber is maximum 1/32 inch. Surfacing material to be U.S. Gypsum Company, Sheetrock First Coat.

H. Accessories include corner reinforcement, Unimast Inc. SHEETROCK No. 800. Metal jamb, ceiling and casing "U" and "J" shaped trim providing edge protection and neat finished edges, Unimast Inc. SHEETROCK Trim No. 801 series. Resilient channel, Unimast Inc. RC-1 Resilient Channel, 25 gauge galvanized steel.

I. Provide aluminum wall mullion end caps to match the color of existing window mullions where partitions terminate at window mullions.

J. Install framing at indicated spacing, plumb and rigid in accord with ASTM C754. Apply wallboard and fasten at intervals recommended by wallboard manufacturer. Apply embedding, filing and finishing coats of joint compound to all joints, with joint tape in the embedding coat. Install sound attenuation blankets where indicated. Partitions receiving sound attenuation blankets shall have acoustical sealant around perimeter of partition and penetrations on both sides of partition.

09 51 00 ACOUSTICAL CEILINGS

A. Install acoustical tile ceilings in compliance with ASTM C636. Secure hanger wires to structure above with double saddle ties and limit to no more than 1/360 of span of members. Support free edges of ceiling tile with edge angles attached to suspension system.

Acoustical ceiling panels shall be USG or Armstrong Ceilings, Non-directional fissured design, size 24" by 24", 5/8" thickness, tegular edges, color white; unless otherwise scheduled on drawings.

C. Exposed ceiling suspension grid system shall be in heavy duty, 24" by 24" or 24" x 48" module as indicated on drawings, cold-rolled steel, electro-galvanized, double web, 15/16" flange width, 1-1/2" height main tees, with low gloss, white paint. Edge molding minimum 0.020" thickness steel with 3/4" flange width, hemmed edge.

D. If applicable, Provide foam or neoprene spacers in space between top of partition and ceiling at ceiling height sound walls.

E. Install acoustical tile and panel systems as indicated on drawings. Direct hang suspension systems from structure; hanger wires spaced at 4'-0" o.c. maximum, with additional hangers at ends of each suspension member. Space main tees at 4'-0" o.c. maximum, with cross tees spaced as required to form grids. Install wall moldings at vertical surfaces. Replace soiled or damaged panels. Provide additional support at unrestrained conditions and where structure spacing requires indirect hanging.

09 65 00 RESILIENT FLOORING

A. Do not start work until work of other trades, including painting, has been substantially completed. Flooring shall be installed prior to the installation of millwork or casework.

B. Resilient tile flooring materials shall be installed with adhesives, as recommended by the tile manufacturer, and in a manner to produce a smooth and even finished surface with tile in tight jointed accurately aligned manner. All in accordance with manufacturer's directions.

C. Lay tile square with room axis, unless noted otherwise on the drawings. Lay edge tiles of same style as field with width varying to maintain full size tiles in field. Edge tiles shall not be smaller than half the width of the field tile.

D. Just prior to final completion, apply wax as recommended by the manufacturer. Machine buff floors

E. Extra Materials: Furnish not less than one box for each 40 boxes for each type, color, pattern and size installed. I less than 40 boxes installed, supply one box of each.

F. Where rubber base is specified, only roll type is acceptable.

09 68 00 CARPET TILES

Submit 3 samples, minimum 12"x12" of all specified carpet finishes and manufacturer's product literature

A. Carpet shall be as specified on drawings. Installation method to be direct-glued per manufacturer recommendations.

B. Fill cracks in concrete slab 1/16" wide or wider and depressions 1/8" deep or deeper with crack filler. Remove or level ridges or high spots. Lay carpet with pattern or direction running in same direction. Tseams in doorways are prohibited.

C. Carpet to carpet transitions at doors shall occur directly under door in the Closed position.

D. Provide rubber/vinyl transition strips at all carpet to hard floor finish conditions unless otherwise noted. Color to match adjacent rubber /vinyl base or, at wood base conditions, as selected by Architect from manufacturer's standard selections.

E. Extra Materials: Furnish extra materials described below that match products installed and that are packaged with protective covering for storage and identified with labels describing contents.

F. Carpet: Full width rolls equal to 5 percent of amount installed for each type indicated, but not less than 10 sq. yd.

G. Where rubber base is specified, only roll type is acceptable.

See drawings for information. For purpose of establishing a quality standard, Sherwin-Williams Company (BOD) are herein specified.

A. Tint prime coats to 1/3 shade of top coat.

B. The number of coats specified are the minimum required. First coat to be primer, second and third coat to be finish coat. The surface of all materials that are to be painted shall be completely hidden. Coverage shall be complete and meet manufacturer's standards for finish.

C. Doors and frames shall be sprayed, not rolled or brushed.

D. Paint materials shall be applied in accordance with the manufacturer's directions on the container label. Materials shall be evenly spread and smoothly flowed-on without runs, sags, dry spray or other film

E. Extra Materials: Supply for each finish coating material, color and finish specified, one gallon of coating material, marked with color and finish identification.

10 26 00 WALL PROTECTION SYSTEM

A. Products to be specified are by Construction Specialties unless noted otherwise

B. Corner Guards to be surface mounted consisting of snap-on plastic cover installed over continuous extruded aluminum retainer. Extruded plastic to be a minimum of 0.078-inch wall thickness. Mounting height shall start on top of base and continue up to 5'-0" aff.

C. Chair rail to be extruded rigid plastic with a minimum of 0.078-inch wall thickness.

D. Wall Protection Panels to be semirigid panel with a minimum sheet size of 48 inches by 96 inches by 0.040-inch sheet thickness.

10 44 00 FIRE PROTECTION SPECIALTIES

A. Extinguishers shall be multi-purpose dry chemical extinguisher, ten lbs., UL rating 4A-60B:C, with bracket supporting extinguisher top and bottom, holding extinguisher off finished wall surface if not located in cabinet.

B. Fire extinguisher cabinets shall be semi-recessed, sized to fit extinguishers, minimum 18-gauge steel cabinet, door and trim material, prefinished white painted. Door shall be duo vertical panel, with tempered glass, with full length piano hinge, roller catch, and pull, and lettering FIRE EXTINGUISHER in red pressure sensitive vinyl lettering running vertical.

C. Locate at 48" AFF, one per every 75 linear feet of travel distance, one per every 3,000 SF, or per Fire Marshal's direction. Reference drawings for locations.

D. All extinguishers in finished areas shall be set in cabinets.

DIVISIONS 21, 22, & 23 MECHANICAL AND ELECTRICAL A. See engineering drawings for specifications.

12 36 61 SOLID SURFACING COUNTERTOPS

A. Composition: Acrylic resins, fire-retardant mineral fillers, and proprietary coloring agents. Through-thebody color for full thickness of sheet material. Material Thickness: 1/2 inch, nominal. Solid surfacing countertops. Solid surfacing sinks. Solid surfacing millwork and window sills.

B. Field Measurements: Verify actual measurements and openings by field measurements before fabrication; show recorded measurements on shop drawings. Coordinate field measurements and fabrication schedule with construction progress to avoid construction delays.

C. Product Data: Submit product data for each specified product. Include manufacturer's technical data sheets and published instruction instructions. 2. Submit Material Safety Data Sheets (MSDS) for adhesives and sealants.

D. Shop Drawings: Submit fully dimensioned shop drawings showing countertop [and window sill] layouts, joinery, terminating conditions, substrate construction, cutouts and holes. Show plumbing installation provisions. Include elevations, section details, and large scale details.

E. Samples: Submit selection and verification samples for each color, pattern, and finish required.

F. Qualifications: Minimum of three years documented experience in fabricating solid surfacing countertops similar in scope and complexity to this Project. Currently certified by the manufacturer as an acceptable fabricator. 2. Installer Qualifications: Minimum of three years documented installation experience for projects similar in scope and complexity to this Project, and currently certified by the manufacturer as an acceptable installer. [Installer shall be the fabricator].

G. Warranty Provide manufacturer's standard 10 Year Commercial Limited Warranty against defects in solid surface sheet materials.



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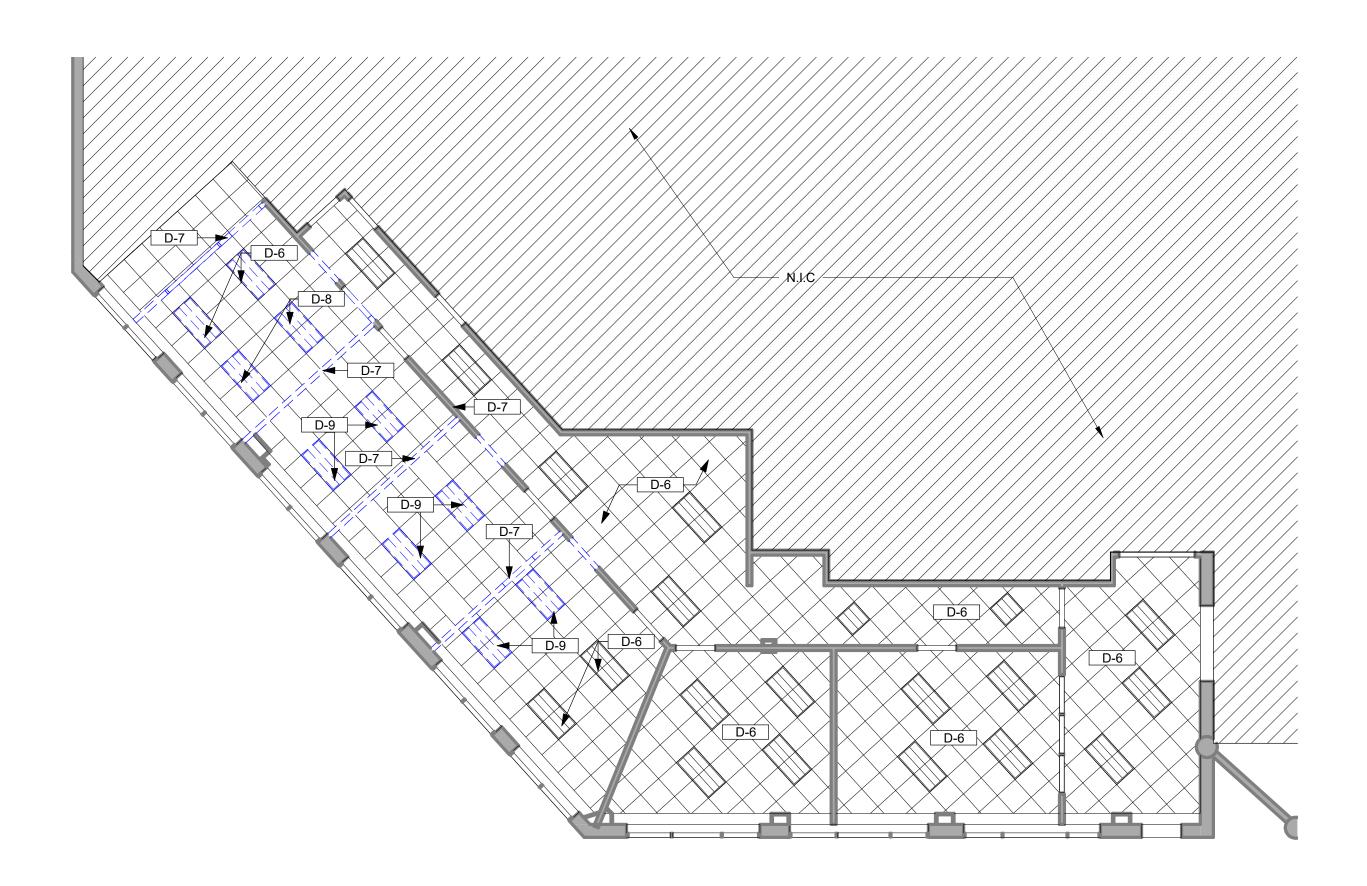
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	11/04/2021	Permit Drawings

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Sheet Title SPECIFICATIONS

Sheet No.

G-3.02



KEY NOTES - DEMO NOTE# **DESCRIPTION** D-1 DEMOLISH EXISTING PARTITIONS IN THEIR ENTIRETY TO EXTENTS INDICATED IN PREPARATION FOR NEW CONSTRUCTION. COORD. W/ ARCH, MECH, ELECTRICAL & PLUMBING DRAWINGS AND SPECIFICATIONS. D-2 REMOVE EXISTING DOOR, FRAME & HARDWARE IN ITS ENTIRETY. STORE & PROTECT FOR RE-INSTALLATION AS NOTED ON PLANS AND DOOR SCHEDULE. DEMOLISH EXISTING MILLWORK IN ITS ENTIRETY. EXISTING SECURITY GLASS AND TRANSACTION TO REMAIN. PREP AREA TO RECEIVE NEW. D-4 DEMOLISH EXISTING PLUMBING. REFER TO MEP DRAWINGS FOR SPECIFICATIONS. DEMOLISH PORTION OF WALL FOR NEW OPENING; PREP AREA FOR NEW WORK. D-6 EXISTING CEILING SYSTEM, LIGHTING AND DEVICES TO REMAIN IN ITS ENTIRETY. CONTRACTOR TO REPAIR EXISTING CEILING TILE OR REPLACE WITH NEW WHERE PARITION WAS REMOVED. EXISTING LIGHTING AND DEVICES TO REMAIN. D-8 DEMOLISH EXISTING LIGHTING IN ITS ENTIRETY. GC TO PROVIDE NEW CEILING TILE TO MATCH EXISTING. REMOVE EXISTING LIGHTING IN ITS ENTIRETY. STORE & PROTECT FOR RE-INSTALLATION AS NOTED ON MEP DRAWINGS. D-10 USER TO RELOCATE EXISTING TV MONITOR.

NOTE: REFERENCE MECHANICAL, ELECTRICAL & PLUMBING DRAWINGS & SPECS FOR ADDITIONAL DEMOLITION NOTES.

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COUNT

110 E MAIN STREET CUMMING, GA 30040

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No.	DATE	DESCRIPTION
	11/04/2021	Permit Drawings

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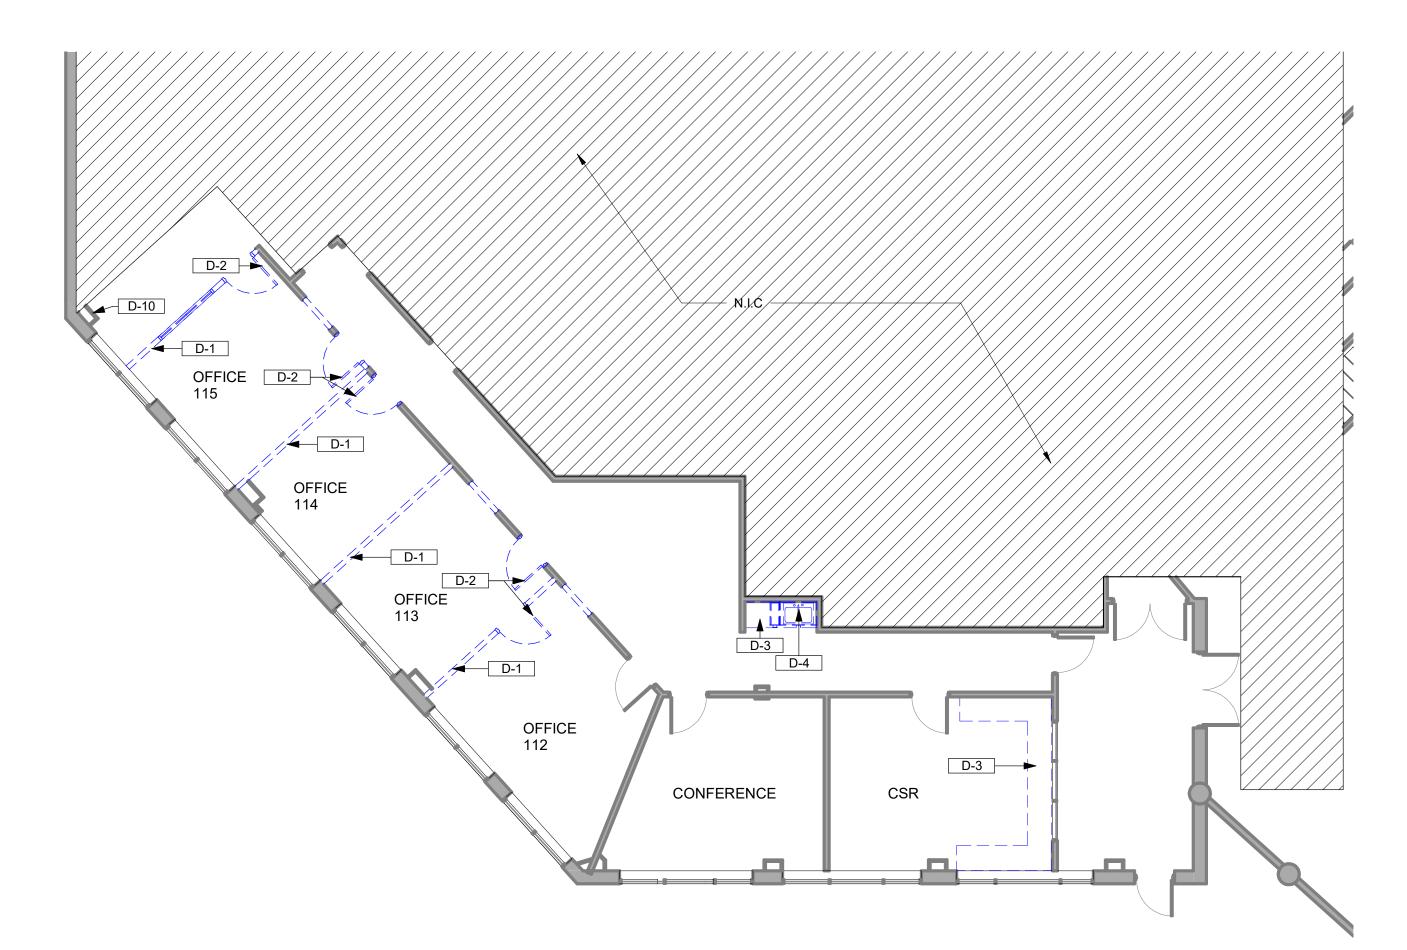
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DEMOLITION PLAN

Sheet No.

D-1.01

DEMOLITION REFLECTED CEILING PLAN



DEMOLITION PLAN

(NORTH, SOUTH, EAST OR WEST) ON WHICH THE CABINETRY IS LOCATED.

COORDINATE ALSO WITH FLOOR PLANS.

SPECIALIZED CABINET SECTIONS ONLY ARE KEYED OR NOTED ON CABINET

2. SPECIALIZED CABINET SECTIONS ONLY ARE KEYED OR NOTED ON CABINET ELEVATIONS. OTHER CABINET SECTIONS ILLUSTRATE TYPICAL CONSTRUCTION & NOT EVERY DOOR AND/OR DRAWER VARIATION IS SHOWN.

MILLWORK GENERAL NOTES

3. ALL WORKSURFACES & COUNTERTOPS ARE PL-2 U.N.O.

4. PROVIDE FINISHED END PANELS AND/OR END RETURNS AT OPEN ENDED

CABINETRY (INCLUDING KNEE SPACES).

5. PROVIDE PLAM CLAD TRIM AND FILLER PANELS WHERE EQUIPMENT IS LOCATED WITHIN CABINET UNITS.

6. PROVIDE SIDE SPLASHES WHERE COUNTERTOPS ABUT WALLS AT SIDES -

U.N.O.

7. PROVIDE COUNTERTOP BRACE SUPPORTS AT 48" O.C. MAX. @ KNEE SPACES 8

LAVATORY COUNTERS, U.N.O.

8. PROVIDE 3" DIA. GROMMETS AT BACK OF COUNTERTOPS EXACT LOCATION TO BE COORDINATED WITH THE OWNER IN THE FIELD AT THE TIME OF INSTALLATION.

9. PROVIDE BLOCKING WITHIN PARTITION FOR ALL CABINETRY ATTACHED TO WALLS. SEE DETAILS FOR ATTACHMENT DETAILS.

10. PROVIDE ALL STRAIGHT RUN COUNTERTOPS THAT HAVE SINKS, WITH SEPARATE BACKSSPLASH TO COUNTERTOP.

11. FILE DRAWERS ARE NOTED ON ELEVATIONS. PROVIDE MINIMUM INSIDE CLEAR DIMENSIONS OF 13.5" WIDE BY 10.5" HIGH BY 20.5" DEEP.

12. CABINET UNIT DEPTH IS AS SHOWN ON SECTION, U.N.O ON ELEVATION(S).
 13. PROVIDE BOTTOM CLOSURE FOR FILLER PANELS AT TOE SPACES AND AT BOTTOM OF UPPER WALL CABINETS TO CLOSE OFF AND SEAL TIGHT ALL

CONCEALED OPENINGS.

14. ALL MILLWORK/CASEWORK TO BE PL-1 U.N.O.

EQUALS

15. CABINET HARDWARE:
A. DOOR HINGES TO BE BLUM 71T5580 CHROMED, CONCEALED, SELF-

CLOSING.

B. DRAWER SLIDES TO BE HEAVY DUTY ACCURIDE HAFELE #4034,

C. DRAWER PULLS TO BE MOCKETT DP55A STAINLESS STEEL OR APPROVED

FINISH SYMBOL LEGEND

P-1 WALL FINISH


FLOOR TRANSITION

F-# FINISH PLAN KEY NOTES

FLOOR FINISH FLOOR FINISH DIRECTION


ACCENT WALL FINISH

AREA NOT IN SCOPE

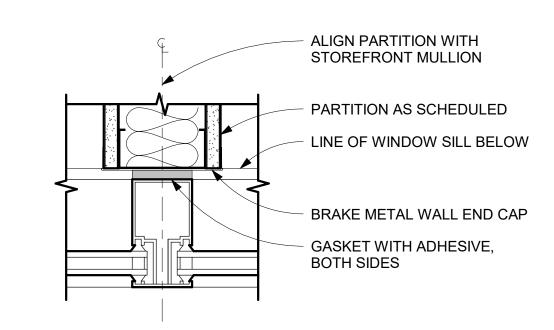

PARTITION/MULLION CLOSURE

SCALE: 3" = 1'-0"

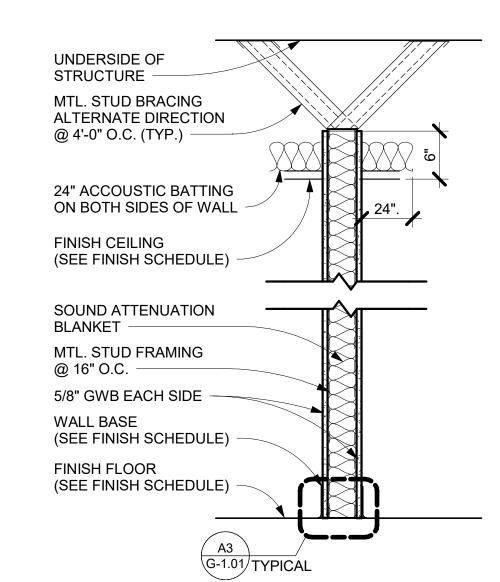

MTL. STUD PARTITION TO 6" ABOVE CEILING				
WALL TYPE	DESCRIPTION	FIRE RATING	U.L.#	STC
А3	3 5/8" MTL. STUD	N/A	N/A	48-55

4 WALL TYPE A

SCALE: 1" = 1'-0"

 ALL INTERIOR FINISH SPECIFICATIONS ARE INCLUDED HEREIN OR IN THE ATTACHED SPCIFICATIONS IF APPLICABLE. DISCREPANCIES, OMISSIONS AND DISCONTINUED OR DELAYED MATERIALS ARE TO BE REPORTED TO THE DESIGN PROFESSIONAL IMMEDIATELY FOR RESOLOLUTION PRIOR TO PROCEEDING. THE DESIGN PROFESSIONAL IS NOT RESPONSIBLE FOR DISCREPANCIES OR OMISSIONS THAT ARISE DUE TO CHANGES BY

ANOTHER PARTY AFTER INITIAL DRAWING ISSUANCE DATE UNLESS RECORDED AS A REVISION BY ARCHITECT.

2. SUBSTITUTIONS OF FINISH MATERIALS MUST BE SUBMITTED IN WRITTEN FORM AND ACTUAL SAMPLES PROVIDED FOR REVIEW BY THE DESIGN PROFESSIONAL AND USER GROUP. CONSTRUCTION PROFESSIONAL MUST RECEIVE APPROVAL SIGNATURE BEFORE PROCEEDING. REVIEW OF SUBSTITUTIONS DUE TO A CHANGE IN THE ORIGINAL SCHEDULE OR BUDGET MAY BE CONSIDERED ADDITIONAL SERVICES.

FINISH PLAN GENERAL NOTES

INSTALL ALL FINISH MATERIALS ACCORDING TO MANUFACTURER'S INSTRUCTIONS. REMEDIATION OF MOISTURE IN THE CONCRETE, AS IT RELATES TO THE FLOORING MATERIAL AND ITS INSTALLATION MUST BE STRICTLY ADHERED TO IN ORDER TO AVOID RISK OF VOIDING WARRANTY

REMOVE FINISH MATERIALS FROM PACKING AND ALLOW TO ACCLIMATIZE TO AREA OF INSTALLATION ACCORDING TO MANUFACTURER'S SPECIFICAITONS.

ONLY ONE DYE-LOT OF EACH STYLE AND COLOR SPECIFIED IN THE FINISH SCHEDULE SHALL BE USED.

6. ALL SURFACES WHICH ARE TO RECEIVE A FINISH APPLICATION SHALL BE COMPLETELY SMOOTH FOR SCHEDULE FINISH MATERIAL.

ALL MISCELLANEOUS GRILLES, PLATES, ETC. OCCURING ON WALLS OR CEILINGS ARE TO BE FINISHED TO MATCH WALL OR CEILING ON WHICH THEY OCCUR. CONSULT DESIGN PROFESSIONAL ON FINAL FINISH.
 ALL PAINTED SURFACES ARE TO RECEIVE ONE PRIME COAT AND A MINMUM OF TWO FINISH COATS. APPLY ADDITIONAL COATS OF PRIME AND FINISH PAINT AS PEOLIPED LINTIL EXISTING LINDERCOAT OR OTHER

ADDITIONAL COATS OF PRIME AND FINISH PAINT AS REQUIRED UNTIL EXISTING UNDERCOAT OR OTHER CONDITIONS ARE FULLY CONCEALED AND PAINT FILM IS OF A UNIFORM FINISH, COLOR AND APPEARANCE. REFER TO SPECIFICATION SECTION 099123 INTERIOR PAINTING FOR CLARIFICATION.

9. PAINT FOR DOOR FRAMES AND DOORS WHEN APPLICABLE, WILL BE SHERWIN WILLIAMS PRO-CLASSIC WATERBORNE ACRYLIC SEMI-GLOSS B-31 SERIES, BASIS OF DESIGN.

10. PRIOR TO FLOORING INSTALLATIONS, PERFORM A CALCIUM CHLORIDE MOISTURE TEST TO ENSURE MOISTURE CONTENT MEETS MANUFACTURER'S ACCEPTABLE LEVELS. CONSTRUCTION PROFESSIONAL TO DOCUMENT AND MAINTAIN RECORDS.

11. INSTALL CARPET USING PRESSURE SENSITIVE ADHESIVE

12. FLOORING TRANSITIONS WILL OCCUR UNDER CENTERLINE OF DOOR IN CLOSED POSITION., U.N.O.
13. WHERE FLOORING MATERIALS OF DIFFERING THCKNESSES MEET, LEVEL AS REQUIRED TO MEET ADA GUIDELINES

AND SMOOTH AS REQUIRED.

14. INSTALL REDUCER STRIPS WHERE CARPET TRANSITIONS TO HARD FLOORING, U.N.O., INSTALL VINYL REDUCER STRIP TO MATCH SCHEDULED BASE.

15. PAINT FIRE EXTINGUISHER CABINETS SEMI-GLOSS TO MATCH WALL ON WHICH IT OCCURS.

16. BASE CABINET PLASTIC LAMINATE TOE KICKS TO MATCH CORRESPONDING BASE CABINET PLASTIC LAMINATE

SPECIFICATION, U.N.O.

17. ALL AREAS TO RECEIVE CARPET, RUBBER BASE, EGGSHELL WALL PAINT AND SEMI-GLOSS DOOR FRAME, U.N.O.

18. SUBMIT SAMPLES OF ALL FINISH MATERIALS TO THE DESIGN PROFESSIONAL FOR APPROVAL PRIOR TO ORDERING MATERIALS AND COMMENCING WORK. SUBMIT ACTUAL COLOR AND FINISH OF BAINT ON 8 1/2" X 11" SAMPLES.

18. SUBMIT SAMPLES OF ALL FINISH MATERIALS TO THE DESIGN PROFESSIONAL FOR APPROVAL PRIOR TO ORDERI MATERIALS AND COMMENCING WORK. SUBMIT ACTUAL COLOR AND FINISH OF PAINT ON 8-1/2" X 11" SAMPLES. WALLCOVERING SAMPLES MUST BE CUT FROM ACTUAL ROLL TO BE USED FOR INSTALLATION. SAMPLES OF NATURAL STONE OR OTHER MATERIAL WITH WIDE VARIATIONS SHALL COME FROM ACTUAL MATERIAL TO BE USED.

19. PREPARE SURFACES FOR ACCEPTING OF FINISHES PER MANUFACTURER'S RECOMMENDATIONS.
 20. WHEN BASE IS CONTINUOUS OR TRANSITIONED ON AN OUTSIDE CORNER WHERE FLOOR MATERIALS OF DIFFERENT THICKNESSES OCCUR, SET BASE ON TOP OF LOWER FLOORING MATERIAL AND TRIM THE BOTTOM OF BASE AT THE HIGHER FLOORING SUCH THAT IT IS BOTH TIGHT TO THE FLOORING AND ALIGNS WITH THE BASE AT THE LOWER FLOORING AT THE TOP EDGE. NOTE: WOOD BASE TO BE INSTALLED AFTER FLOORING IS INSTALLED.
 24. PROVIDE BLOOKING IN AREAS DESIGNED TO RECEIVE OVERHEAD CARBINETS. TWO DISPLAY SOREENS AND

21. PROVIDE BLOCKING IN AREAS DESIGNED TO RECEIVE OVERHEAD CABINETS, TV/ DISPLAY SCREENS AND MARKERBOARDS.22. IF DESIGN PROFESSIONAL'S WRITTEN DESCRIPTION OF COLOR NAME, NUMBER AND MANUFACTURER'S

INFORMATION ARE IN CONFLICT, CONTACT DESIGN PROFESSIONAL FOR CLARIFICATION BEFORE ORDERING MATERIALS.

23. ALL CASEWORK TO RECEIVE TOPS FABRICATED IN PLASTIC LAMINATE, U.N.O. REFER TO INTERIOR ELEVATIONS FOR CLARIFICATION.

24. PROVIDE BLOCKING IN AREAS DESIGNATED TO RECEIVE OVERHEADS IN ALL OFFICES. TYPICAL CONDITION TO OCCUR AT WALL PARALLEL TO RETURN; REFER TO FINISH NOTE F-3 IN PLAN.

25. COVERPLATES ON DEVICES TO BE STAINLESS STEEL WITH GRAY OR BLACK RECEPTACLES.

FLOOR PLAN GENERAL NOTES

1. ALL DOOR FRAMES IN METAL STUD WALLS SHALL BE SET 4" FROM PERPENDICULAR WALLS ADJACENT

TO DOOR HINGE SIDE, U.N.O.

DEMOLISHED PARTITIONS OCCURRED


KEY NOTE #

F-3

F-4

LOCATE CORNER GUARDS WP-1 AS SHOWN ON THE PLANS.
 THE FINISH ELEVATIONS OF EXIT LANDINGS SHALL NOT EXCEED A MAXIMUM OF 1/2" BELOWTHRESHOLDS.

KEY NOTES - FINISH PLAN
DESCRIPTION
ALIGN WALL CENTERLINE WITH MULLION
PROVIDE WP-1 AT CORNERS
PROVIDE BLOCKING IN WALL FOR DIGITAL SCREEN
PATCH EXISTING OPENING TO MATCH ADJACENT CONSTRUCTION MATERIALS. FACE OF PARTITION TO BE FLUSH W/EXISTING PARTITION TO LIKE NEW CONDITION.
RE-INSTALL FIRE EXTINGUISHER CABINET.
CONTRACTOR TO PATCH OR REPLACE CARPET TILE (CPT-1) TO LOOK LIKE NEW WHERE

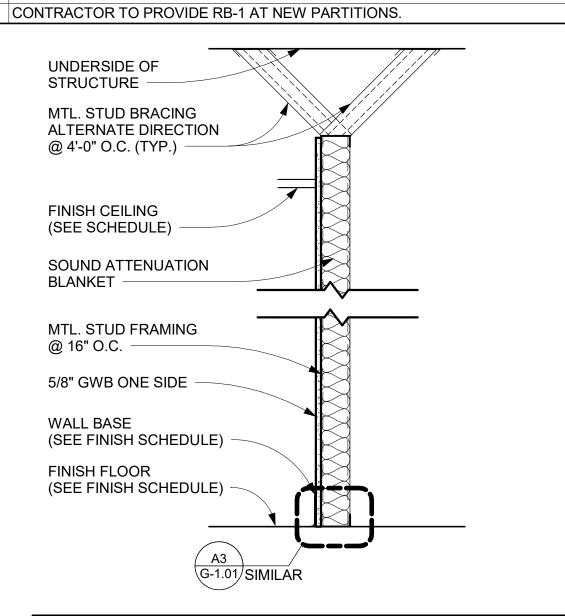

MTL. STU	JD PARTITION TO 6	" ABOVE CE	LING	
WALL TYPE	DESCRIPTION	FIRE RATING	–U.L. #	STC
H1	7/8" HAT CHANNELS (NO ACOUSTIC BATTING)	N/A	N/A	N/A

SCALE: 1" = 1'-0"



102 Mary Alice Park Road, Suite 103 Cumming, GA 30040



FORSYTH COUNTY M SEWER SUITE 150 FORSYTH COUNTY

PRINT RECORD					
No.	DATE	DESCRIPTION			
	11/04/2021	Permit Drawings			

110 E CUMIN

Drawn By Checked By

JDG

Date

Lob No.

Date Job No. 20005

Sheet Title

REFERENCE & FINISH PLAN

Sheet No.

A-1.01R

NOT RELEASED FOR CONSTRUCTION

4 5

REFLECTED CEILING PLAN

SCALE: 1/8" = 1'-0"

RCP SHOWN ON THIS DOCUMENT IS FOR GRAPHIC ILLUSTRATION ONLY AND SHALL NOT BE USED AS AN ACCURATE REPRESENTATION OF MECHANICAL, ELECTRICAL AND PLUMBING SCOPE OF WORK. REFERENCE MECHANICAL, ELECTRICAL AND PLUMBING DRAWINGS AND SPECIFICATIONS FOR SCOPE OF WORK.

RCP LEGEND

FACE OF SIGN; ARROW SHOWN

EXIT SIGNAGE (SHADING INDICATES RELOCATED EXISTING 2X4 LAY-IN LIGHT INDICATES DIRECTION) SUPPLY (X' - X") **CEILING TAG**

LAY-IN CEILING GRID GYPSUM BD. CEILING

ACT-1: ACOUSTICAL CEILING TILE MFR: MATCH EXISTING STYLE: MATCH EXISTING MODEL NO: MATCH EXISTING EDGE: MATCH EXISTING SIZE: 2' X 2' X 3/4" COLOR: WHITE GRID: MATCH EXISTING COLOR: WHITE

RCP GENERAL NOTES

- . CONSTRUCTION PROFESSIONAL SHALL FIELD VERIFY ALL FIXTURE LOCATIONS. ANY CONFLICT WITH FIELD CONDITIONS, DRAWINGS AND/OR OTHER TRADES SHALL BE REPORTED TO THE ARCHITECT IMMEDIATELY UPON DISCOVERY FOR CLARIFICATION PRIOR TO PROCEEDING WITH ASSOCIATED WORK.
- 2. PROVIDE AND INSTALL CEILING TILE, MAIN TEES, CROSS TEES, WALL MOULDINGS AND OTHER ACCESSORIES NECESSARY TO COMPLETE THE SCOPE OF WORK.
- 3. ALL ADJACENT LIGHT SWITCHES SHALL BE GANGED WITH A SINGLE FACE PLATE.
- 4. UNLESS APPROVED BY THE ARCHITECT, ALL THERMOSTATS SHALL BE LOCATED DIRECTLY ADJACENT TO THE LIGHT SWITCH IN THE ROOM IN WHICH IT OCCURS.
- 5. CENTER ALL SPRINKLER HEADS IN CEILING TILES WHERE POSSIBLE. ALL SPRINKLER HEADS IN GYPSUM BOARD TO BE RECESSED & CONCEALED.
- 6. CENTER ALL LIGHT FIXTURES IN SPACE, U.N.O. ALL RECESSED LIGHT FIXTURES SHALL BE CENTERED IN CEILING TILES WHERE POSSIBLE, U.N.O.
- 7. CONSTRUCTION PROFESSIONAL WILL ENSURE THAT LENSES IN LIGHTING FIXTURES ARE CLEAN AND FREE OF DUST, DIRT AND SMUDGES. PLASTIC AND LABELS SHALL BE REMOVED FROM ALL LIGHT FIXTURES AT PROJECT COMPLETION.
- 8. NO SUBSTITUTES WILL BE ACCEPTED FOR ANY LIGHT FIXTURES UNLESS APPROVED BY ARCHITECT IN WRITING.



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No.	DATE	DESCRIPTION
	11/04/2021	Permit Drawings

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Sheet Title

REFLECTED CEILING **PLAN**

Sheet No.

HEAD ELEVATION PAIR **HEIGHT** THICK. MATL. **FINISH** ELEVATION MATL. **FINISH** JAMB SILL NOTES WIDTH EXISTING TO BE RELOCATED. SCWD STD PTD 2/A-7.01 3/A-7.01 **EXIST SINGLE** 1 3/4" PTD SCWD STD **SINGLE** 1 3/4" F1 SCWD STD PTD **SINGLE** 1 3/4" F1 SCWD STD F1 PTD **SINGLE** 7' - 10" 1 3/4" PTD **SINGLE** 1 3/4" SCWD STD F1 STD PTD PAIR 1 3/4" SCWD PTD 1 3/4" SCWD STD **EXIST** EXISTING TO BE RELOCATED. **SINGLE** SCWD STD F1 PTD 2/A-7.01 3/A-7.01 1 3/4" EXIST SCWD STD PTD 3/A-7.01 EXISTING TO BE RELOCATED. 1 3/4" F1 EXIST EXISTING TO BE RELOCATED. SINGLE SCWD STD F1 3/A-7.01 1 3/4"

GLOBAL G SERIES MOBILE PEDESTAL TWO

BOX, ONE FILE. 23" DEEP X 27" H


NOTE: ON SALVAGED DOORS THAT CONTRACTOR TO REFINISH IN A CLEAN ENVIRONMENT AND TO TAKE CARE TO REDUCE IMPERFECTIONS AS MUCH AS POSSIBLE


	ROOM SIGNA	GE SCHEDU	LE
NAME	ROOM NUMBER	SIGNAGE	COMMENTS
CSR	110		EXISTING TO BE REINSTALLED
CONFERENCE	112		EXISTING TO BE REINSTALLED
OFFICE 115	115		EXISTING TO BE REINSTALLED
OFFICE 114	114		EXISTING TO BE REINSTALLED
OFFICE 113	113		EXISTING TO BE REINSTALLED
OFFICE 112B	112B		EXISTING TO BE REINSTALLED
OFFIOF 440	440		NEW TO MATOU EVICTING

SCALE: 1/8" = 1'-0"

		FURNISHE	D BY	INSTALLED) BY	
TAG NO.	DESCRIPTION	CONTRACTOR	OWNER	CONTRACTOR	OWNER	NOTES
EQ-01	UNDERCOUNTER ADA COMPLIANT REFRIGERATOR		Х	X		EXISTING; SALVAGE FOR RE-INSTALLATION
EQ-02	BUNN COFFEE MAKER		Х	Х		EXISTING; SALVAGE FOR RE-INSTALLATION
EQ-03	DIGITAL SCREEN	Х		Х		GC TO COORDINATE SIZE AND SPECIFICATIONS WITH
	FUI	RNITURE SCH	IEDUL	E (FN)		
		FURNISHE	D BY	INSTALLED) BY	
TAG NO	DESCRIPTION	CONTRACTOR	OWNER	CONTRACTOR	OWNER	NOTES

EQUIPMENT SCHEDULE (EQ-)

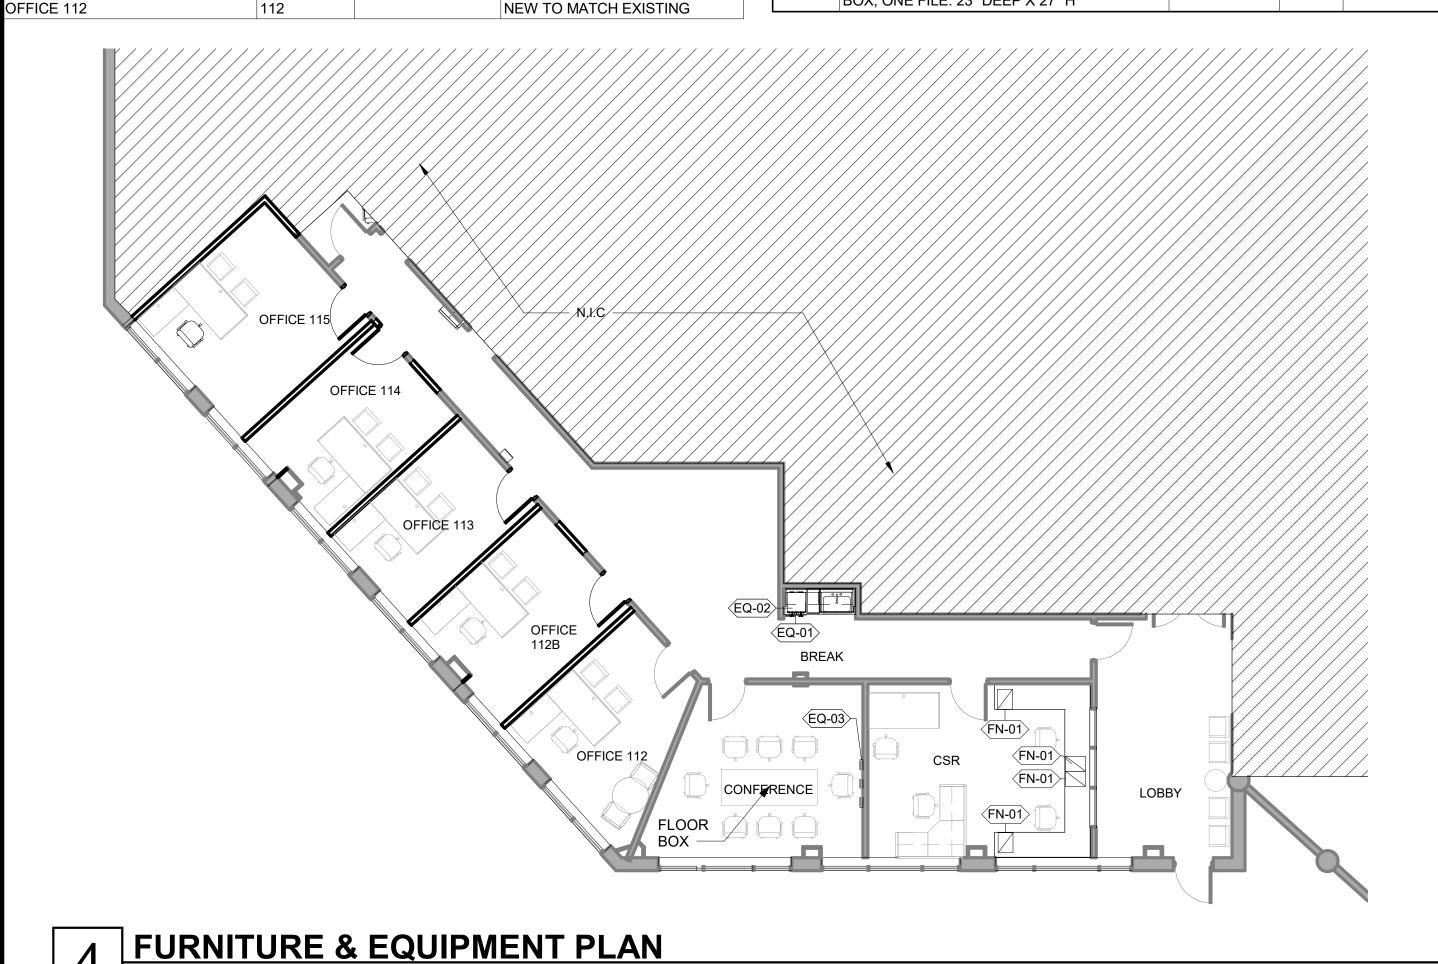

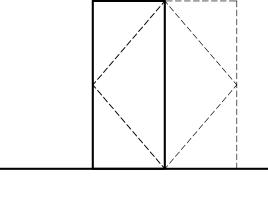


SINGLE DOOR DOUBLE DOOR


DOOR ELEVATIONS

SCALE: 1/4"=1'-0"

SCALE: 1/4"=1'-0"

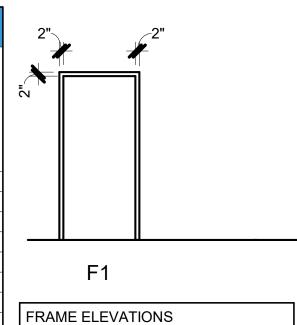

METAL STUDS -SEE PLANS FOR SOUND **WALL TYPE** INSULATION **BOX HEADER -**5/8" GYPSUM BOARD SEE STRUCTURAL (BOTH SIDES) SEALANT **BOTH SIDES HOLLOW METAL** FRAME DOOR AS SCHEDULED

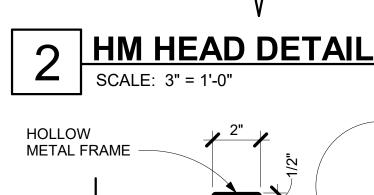

METAL STUDS -SEE PLANS FOR WALL TYPE DOOR AS SOUND SCHEDULED INSULATION SEALANT 5/8" GYPSUM BOARD **BOTH SIDES** (BOTH SIDES)

HM JAMB DETAIL





No.	DATE	DESCRIPTION
	11/04/2021	Permit Drawings

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Job No.

Sheet Title

DOOR & WINDOW SCHEDULE/ **FURNITURE AND EQUIPMENT PLAN** Sheet No.

NOT RELEASED FOR CONSTRUCTION

FURNITURE.	FIXTURE &	EQUIPMENT	GENERAL NOTES
· ordini ordin,			

GENERAL CONTRACTOR TO COORDINATE SCHEDULED ITEMS WITH OWNER AND OWNER'S EQUIPMENT REPRESENTATIVE. THIS INCLUDES VERTICAL AND HORIZONTAL MOUNTING HEIGHTS OF ALL DEVICES, COORDINATION WITH ARCHITECTURAL, MECHANICAL, ELECTRICAL AND

2 LOW VOLTAGE BY OWNER'S EQUIPMENT REPRESENTATIVE, U.N.O. 3. GENERAL CONTRACTOR TO COORDINATE WITH OWNER/OWNER REPRESENTATIVE ON DELIVERY SCHEDULE AND INSTALLATION FOR ALL

GENERAL NOTES

- 2. ALL DOOR HARDWARE SHALL BE HANDICAP ACCESSIBLE, COMPLYING WITH 2010 ADA STANDARDS FOR ACCESSIBLE DESIGN.
- WHERE DISCREPANCIES OCCUR BETWEEN THE DOOR SCHEDULE NOTES AND HARDWARE SPECIFICATIONS, NOTIFY THE ARCHITECT OF
- . TIE MAGNETIC LOCK INTO FIRE ALARM.
- 5. REFER TO THE PARTITION TYPE OR APPLICABLE WALL SECTION AND THEN TO TYPICAL DOOR DETAILS FOR APPROPRIATE DETAIL.

ABBREVIATIONS LEGEND DOOR MATERIAL TYPE FINISH TYPE

REFER TO ADA REGULATORY DIAGRAMS FOR MORE INFORMATION

- SEE GENERAL SPECIFICATIONS FOR DOOR AND FRAME FINISHES.
- DISCREPANCIES TO RECEIVE DIRECTION ON HOW TO PROCEED.

SCWD - SOLID CORE WOOD

FRAME MATERIAL TYPE ALUM - ALUMINUM

PLAM - PLASTIC LAM CLAD

ALUM - ALUMINUM

STL - STEEL WD - WOOD

HM - HOLLOW METAL

T - CLEAR TEMPERED GLASS TT - TINTED & TEMPERED GLASS HM - HOLLOW METAL IT - INSULATED TEMPERED GLASS

GLAZING TYPE

STD - STAIN

PTD - PAINT

PF - PREFINISHED

55

2' - 1" *REFER TO DETAIL 1 / ID-5.01 FOR BALANCE OF NOTES

PLYWOOD BACKSPLASH 2' - 1" & COUNTERTOP CLAD IN FINISH PER ELEVATION -FAUCET -UNDERMOUNT SINK HATCHED REGION INDICATES REQ'D MIN CLEARANCE INSULATE ALL EXPOSED PIPES PER ADA CODES, TYP. BASE ASSEMBLY FOR ADA DOOR - QUICK-TOE, MORRISON SUPPLY 770.455.8244 (BASIS OF DESIGN) FACE TOE KICK WITH 11" MIN/ PLASTIC LAMINATE TO MATCH CABINET. FINISHED FLOOR; PROVIDE FLOOR FINISH IN BASE OF *REFER TO DETAIL 1 / ID-5.01 THIS CABINET ONLY FOR BALANCE OF NOTES 3 BASE CABINET - ACCESSIBLE SINK

SCALF: 1 1/2" = 1' 0"


MDF COUNTERTOP & BACKSPLASH CLAD IN PLASTIC LAMINATE OR SOLID 2' - 1" SURFACE; REFER TO INTERIOR ELEVATIONS 3" GROMMET WHERE NEEDED PLYWOOD SUPPORT PANEL CLAD IN PLASTIC LAMINATE @ 4'-0" O.C. , U.N.O. SCHEDULED BASE *REFER TO DETAIL 1 / ID-5.01 FOR BALANCE OF NOTES

COUNTERTOP - WORKSURFACE

BASE CABINET - 1 DRAWER & DOORS

2 BASE CABINET - 4 DRAWERS

SCALE: 1 1/2" = 1'-0"

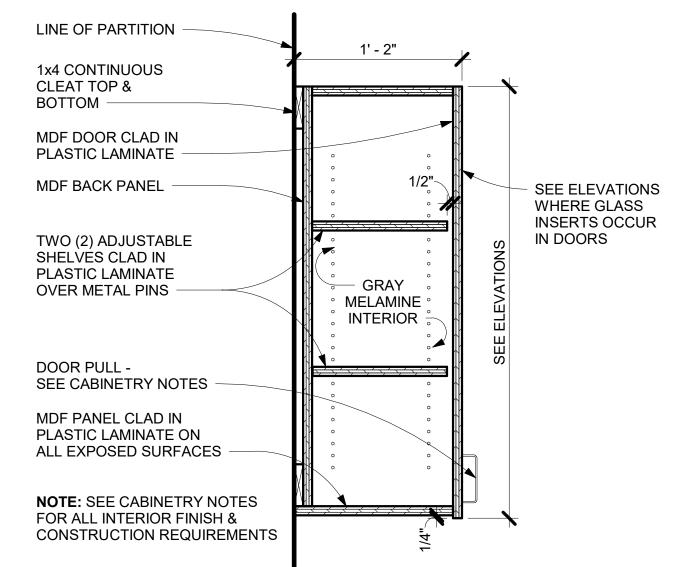

COUNT

110 E MAIN STREET CUMMING, GA 30040

102 Mary Alice Park Road, Suite 103

Cumming, GA 30040

DOUGLAS E SHAW

11/04/2020

PRINT RECORD **DESCRIPTION** 11/04/2021 Permit Drawings

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Sheet Title

INTERIOR SECTIONS & DETAILS

Sheet No.

ID-5.01

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SCALE: 1 1/2" = 1'-0" **UPPER CABINET - DOOR** SCALE: 1 1/2" = 1'-0"

1: RUNOUT SIZE SHALL BE EQUAL TO NECK SIZE, UNLESS NOTED OTHERWISE ON DRAWINGS.
2: FINISH FOR ALL DEVICES SHALL B NO. 26 WHITE, UNLESS OTHERWISE INDICATED ON ARCHITECTRUAL DRAWINGS. 3: SEE NECK SIZE SCHEDULE. 4: CONTRACTOR SHALL BALANCE DIFFUSER/GRILLE TO AIRFLOW LISTED ON PLANS.

5: SEE ARCHITECTURAL PLANS FOR CEILING TYPE. PROVIDE CORRECT BORDER TYPE FOR CEILING APPLICATION....

							Alf	S TEN	SMIN'	AL U	INIT SC	CHEDU	LE		
		AIR V	ALVE D	ATA (5)		FAN D	рата (4)			HEA ⁻	TING DATA				
TAG	TYPE	MIN CFM	DE9 CFM	MAX DP	DE9 CFM	SP IN WG	HP (3)	VOLT/Φ	HEAT CFM	KW	STAGES	VOLT/Φ	MAX NC	BASIS OF DESIGN	NOTES
(E)PIU-15-20-1	PARALLEL	560	1,610	1/4	650	1/3	-	-	1,210	5	1	-	40	EXISTING	1

<u>ABBR</u>	SYMBOL	<u>DESCRIPTION</u>
A/C		ABOVE CEILING
AD		ACCESS DOOR
ADJ		ADJUSTABLE
AFF		ABOVE FINISHED FLOOR
AUTO		AUTOMATIC
BAL		BALANCING
BDD		BACKDRAFT DAMPER
BHP		BRAKE HORSEPOWER
	TYPE-CFM	CEILING SUPPLY AIR DIFFUSER
	TYPE	CEILING RETURN AIR REGISTER / GRILLE OR EXHAUST REGISTER / GRILLE
CFM		CUBIC FEET PER MINUTE
CON		CONCENTRIC
	•	CONNECT TO EXISTING
DB		DECIBELS
	>/\->	DIRECTION OF AIRFLOW
DB	,	DRY BULB
DN		DOWN
DR		DRAIN
DWG		DRAWING
	▶	DUCT SIZE TRANSITION - SINGLE LINE DUCT
	<u> </u>	DUCTWORK - NEW
	/ [X]	DUCTWORK - EXISTING OR DIFFUSER TO REMAIN
		DUCT - SUPPLY OR OUTSIDE AIR UP
		DUCT - RETURN OR EXHAUST UP
		DUCT - SUPPLY OR OUTSIDE AIR DOWN
		DUCT - RETURN OR EXHAUST DOWN
		DUCT TRANSITION - SQUARE-TO-ROUND (OR OVAL)
	DD	DUCT MOUNTED SMOKE DETECTOR (WIRED BY DIV. 16)
EAT		ENTERING AIR TEMPERATURE
EFF		EFFICIENCY
ESP		EXTERNAL STATIC PRESSURE
EWT		ENTERING WATER TEMPERATURE
EA		EXHAUST AIR
° F		FAHRENHEIT
	FD ▶──	FIRE DAMPER
FLR		FLOOR
FPM		FEET PER MINUTE
FPS		FEET PER SECOND
	F9DD——	FIRE AND SMOKE DAMPER
FT		FEET
GA		GAUGE

ABBR	SYMBOL	DE9CRIPTION DE9CRIPTION
HTG	<u> </u>	HEATING
	H	HUMIDISTAT
ID		INSIDE DIMENSION
IN		INCHES
KW		KILOWATTS
KVA		KILO VOLT AMPS
LAT		LEAVING AIR TEMPERATURE
LB		PounDs
	lacksquare	LIMITS OF DEMOLITION
	Ť	LINEAR SLOT DIFFUSER
MAX		MAXIMUM
MD		MANUAL DAMPER
MFR		MANUFACTURER
MIN		MINIMUM
MOD		MOTOR OPERATED DAMPER
MVD		MANUAL VOLUME DAMPER
NC NC		NORMALLY CLOSED
NO NO		NORMALLY OPENED
NOM		NOMINAL
OA		OUTSIDE AIR
OBD		OPPOSED BLADE DAMPER
0D		OUTSIDE DIMENSION
PIU		POWERED INDUCTION UNIT
		PRESSURE REDUCING VALVE
PRV		
PSI PTAC		POUNDS PER SQUARE INCH PACKAGED TERMINAL AIR CONDITIONER
RA		RETURN AIR
RAG		RETURN AIR GRILLE
RAT		RETURN AIR TRANSFER
RED		REDUCER REFRIGERANT SUCTION AND DISCHARGE TUBING
		(ROUTED TOGETHER)
SA a=::		SUPPLY AIR
SEN		SENSIBLE
SF CF	0	SQUARE FEET
SF		SUPPLY FAN
SP		STATIC PRESSURE
SPS		STATIC PRESSURE SENSOR
5Q		SQUARE
SR		SUPPLY REGISTER SIDE-WALL OR DUCT MOUNTED
	>	RETURN OR EXHAUST AIR REGISTER / GRILLE
TEMP		TEMPERATURE
	(† <u>\$</u>)	TEMPERATURE SENSOR
†G		TRANSFER GRILLE
tu		TERMINAL UNIT
	(†)	THERMOSTAT
TYP		TYPICAL
UNO		UNLESS NOTED OTHERWISE
VA		VALVE
VAV		VARIABLE AIR VOLUME
WB		WET BULB
		WATER COLUMN
WC		WATER COLUMN

DESIGN CONDITIONS

COOLING - SUMMER DESIGN

HEATING - WINTER DESIGN

93.9 °F / 74.8°F

75°F / 60% MAX


7*0*°F

OUTDOOR DESIGN DB/ COINCIDENT WB (ASHRAE 0.4%)


INDOOR DESIGN DB

OUTDOOR DESIGN (ASHRAE 99.6%)

INDOOR DESIGN DB (OTHER)

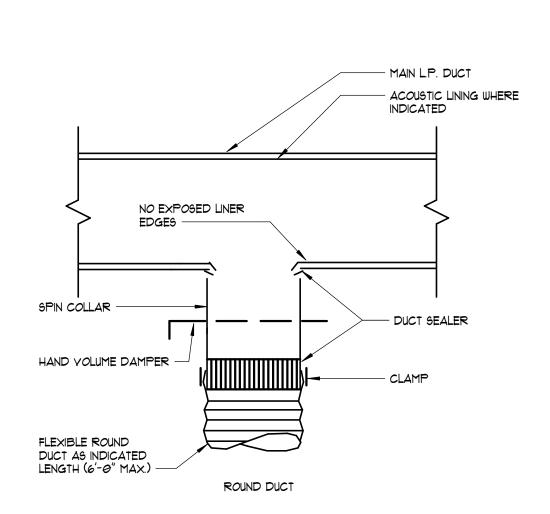

2 TYPICAL LOW PRESSURE BRANCH DUCT TAKE-OFF

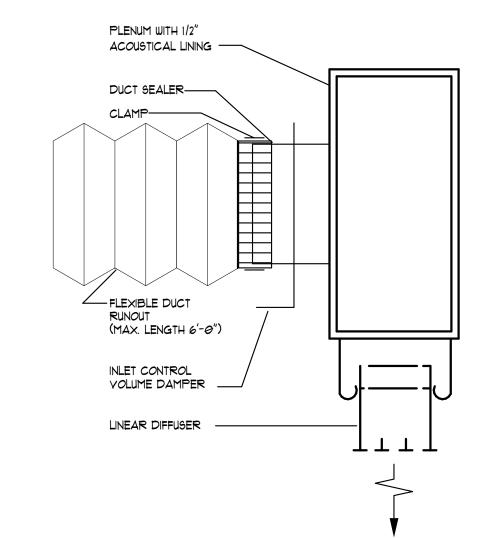

1 LINEAR DIFFUSER CONNECTION (VERTICAL DISCHARGE)



102 Mary Alice Park Road, Suite 103 Cumming, GA 30040





COUNT

110 E MAIN STREET CUMMING, GA 30040 PRINT RECORD No. DATE DESCRIPTION 11/04/2021 Permit Drawings

Checked By Drawn By Job No. Date

11/04/2021

Sheet Title

LEGENDS, DETAILS & SCHEDULES - HVAC

Sheet No.

M-0.00RELEASED FOR CONSTRUCTION

MECHANICAL AND PLUMBING GENERAL NOTES

- ALL WORK SHALL COMPLY WITH ALL LOCAL BUILDING CODES, LAWS, REGULATIONS, ORDINANCES, SMACNA STANDARDS, AND ASHRAE GUIDELINES.
- THE WORK SHALL CONSIST OF ALL LABOR AND MATERIAL TO COMPLETELY INSTALL ALL WORKS AS SHOWN ON THESE DRAWINGS.
- COORDINATE LOCATION OF PIPE ROUTING, DUCTWORK AND DIFFUSERS WITH LIGHT FIXTURES WITH ELECTRICAL CONTRACTOR. RELOCATE PIPING \$10R DUCTWORK, IF NECESSARY, AS DIRECTED BY THE ARCHITECT/ENGINEER.
- ALL WORK ASSOCIATED WITH THE SCOPE OF THIS PROJECT INCLUDING EQUIPMENT, ACCESSORIES, DEVICES, SYSTEMS, ETC. SHALL BE COVERED BY A ONE YEAR GUARANTEE WHICH SHALL START AT THE TIME OF FINAL ACCEPTANCE BY THE OWNER. ANY DEFECTS IN PRODUCTS, INSTALLATION, WORKMANSHIP SHALL BE CORRECTED AT NO ADDITIONAL CHARGE AND SHALL INCLUDE ANY NECESSARY REPAIRS TO WALLS, FLOORS, MILLWORK, ETC. WHICH SHALL BE REPAIRED BACK TO NEW AND FINISHED
- THE CONTRACTOR SHALL KEEP A RECORD OF THE CHANGES WHICH ARE IN CONFLICT WITH THESE DRAWINGS AND SPECIFICATIONS. AT THE COMPLETION OF THIS WORK THE CONTRACTOR SHALL SUBMIT "AS BUILT" PRINTS TO THE OWNER.
- THE DRAWINGS ARE DIAGRAMMATIC AND DO NOT NECESSARILY SHOW THE EXACT ROUTING OR DETAILED FITTINGS. ALL WORK SHALL BE INSTALLED AS A COMPLETE SYSTEM WITH NECESSARY COMPONENTS, FITTINGS, STRAPS, ETC. ALL DAMPERS AND VALVES SHALL BE INSTALLED SO THAT THEY ARE ACCESSIBLE.
- REFER TO THE ENTIRE CONTRACT DRAWING SET AND SPECIFICATIONS FOR GUIDANCE ON DIMENSIONS, CEILING HEIGHTS, DOOR SWINGS, ROOM FINISHES, STRUCTURAL DETAILS, LOCATIONS OF DUCTWORK, PIPING AND STRUCTURAL MEMBERS. INSTALL THE MECHANICAL SYSTEMS SO AS NOT TO INTERFERE WITH THE INSTALLATION OR FUNCTION OF ANOTHER DISCIPLINES WORK.
- ALL DUCT AND PIPING MUST BE CONCEALED ABOVE THE CEILING OR IN THE WALLS UNLESS OTHERWISE NOTED.
- COORDINATE DIFFUSER LOCATIONS WITH ARCHITECTURAL REFLECTED CEILING PLAN TO VERIFY FRAME TYPES BASED ON CEILING TYPE.
- COORDINATE VALVE LOCATIONS WITH ARCHITECTURAL REFLECTED CEILING PLAN TO MAKE CERTAIN NONE ARE INSTALLED OVER GYPSUM BOARD CEILINGS.
- THE CONTRACTOR SHALL INSTALL ALL WORK IN A NEAT AND WORKMANLIKE MANNER AND ACCORDING TO GENERALLY ACCEPTED PRACTICES OF FIRST CLASS WORKMANSHIP.
- THERMOSTATS SHALL BE LOCATED IN EACH ZONE AS INDICATED ON PLAN. THE EXACT LOCATION ON THE WALL SHALL BE AS DIRECTED BY THE ARCHITECT.
- CONTRACTOR SHALL PROVIDE (2) SETS OF FILTERS FOR EACH PIU: ONE DURING CONSTRUCTION AND ONE SET AT COMPLETION OF CONSTRUCTION. FILTERS SHALL BE I" THICK PLEATED, MINIMUM 30% EFFICIENT (MERY RATING OF 1).
- ALL DIMENSIONS OF EXISTING CONSTRUCTION ARE APPROXIMATE. THE CONTRACTORS SHALL MAKE ALL NECESSARY FIELD MEASUREMENTS OF EXISTING STRUCTURES, AND EQUIPMENT TO VERIFY DIMENSIONS SHOWN ON THE DRAWINGS. PROVIDE PROPER DIMENSIONS NOT SHOWN PRIOR TO EQUIPMENT FABRICATION. ALL COST FOR MODIFICATIONS OF NEW CONSTRUCTION DUE TO LACK OF CONFIRMATION OF DIMENSIONS BY FIELD MEASUREMENT SHALL BE THE RESPONSIBILITY OF THE MECHANICAL CONTRACTOR.
- ALL PIPING, DUCTWORK, INSULATION, CONSTRUCTION STANDARDS, ETC. MUST BE EQUAL TO OR GREATER THAN EXISTING BUILDING STANDARDS. THE USE OF RIGID FIBER DUCT BOARD AND PYC IS NOT PERMITTED.
- LANDLORD SHALL HAVE FIRST REFUSAL FOR EXISTING EQUIPMENT AND MATERIALS SHOWN OR LISTED TO BE REMOVED FROM THE PROPERTY. EQUIPMENT AND MATERIALS SHALL BECOME PROPERTY OF THE CONTRACTOR AND REMOVED FROM THE SITE IF NOT ACCEPTED BY THE LANDLORD.
- CONTRACTOR SHALL PROVIDE MANUAL VOLUME DAMPER AT SUPPLY AND/OR RETURN AIR TAKE-OFFS IF NONE EXIST TO PROPERLY BALANCE SYSTEMS WITHIN THE
- CONTRACTOR SHALL CLEAN AND/OR PAINT EXISTING AIR DISTRIBUTION DEVICES TO

FIRE PROTECTION NOTES

- CONTRACTOR SHALL PROVIDE STAMPED SPRINKLER DRAWINGS IN COMPLIANCE WITH ALL APPLICABLE FEDERAL, STATE, AND LOCAL CODES, AND IN ACCORDANCE WITH NFPA... CONTRACTOR SHALL PROVIDE GUARANTEE COVERING ALL WORK AND MATERIALS FOR
- CONTRACTOR SHALL BE RESPONSIBLE FOR OBTAINING FLOW TEST DATA AND PREPARING HYDRAULIC CALCULATIONS IF REQUIRED BY AUTHORITY HAVING
- CONTRACTOR TO CONFIRM STRUCTURAL AND SUPPLY HYDRAULIC INFORMATION PRIOR TO SYSTEM MODIFICATION AND INSTALLATION.
- CONTRACTOR TO FIELD VERIFY THE EXACT LOCATION OF ALL HEADS TO INSURE WORK WILL NOT CONFLICT WITH CEILING GRID AND LIGHTS. COORDINATE WITH ALL OTHER
- RELOCATE/PROVIDE NEW (MATCH EXISTING TYPE) SPRINKLER HEADS AND COORDINATE WITH LIGHTS, GRILLES, \$ DIFFUSERS WITHIN THE REQUIREMENTS OF NFPA 13.
- REVISED SPRINKLER LAYOUT SHALL COMPLY WITH NFPA 13.
- SPRINKLER PIPING SHALL BE ASTM A135, SCHEDULE 40 BLACK STEEL FOR 2" AND SMALLER PIPE SCHEDULE 10 BLACK STEEL MAY BE USED FOR 2-1/2" AND LARGER PIPE.

MECHANICAL (HVAC \$ PLUMBING) SPECIFICATIONS A. GENERAL CONDITIONS OTHER CONTRACT DOCUMENTS

THE GENERAL CONDITIONS AND OTHER CONTRACT DOCUMENTS AS SET FORTH HEREBY ARE TO BE INCORPORATED INTO AND BECOME A PART OF THE SPECIFICATIONS FOR THE WORK UNDER THIS DIVISION.

B. CODES AND PERMITS COMPLY WITH ALL RULES, REGULATIONS OF STATE, COUNTY, AND CITY

- AUTHORITIES HAVING JURISDICTION OVER THE PREMISES, INCLUDING SAFETY REQUIREMENTS OF OSHA. DO NOT CONSTRUE THIS AS RELIEVING CONTRACTOR FROM COMPLYING WITH SPECIFICATIONS WHICH EXCEED CODE REQUIREMENTS AND NOT IN CONFLICT THEREWITH.
- SECURE AND PAY FOR ALL PERMITS AND CERTIFICATES OF INSPECTION

C. LOCAL CONDITIONS:

- THE CONTRACTOR SHALL VISIT THE SITE PRIOR TO BID AND BE FAMILIAR WITH ALL EXISTING CONDITIONS. SPECIAL ATTENTION SHALL BE GIVEN TO WORK TO BE PERFORMED ABOVE AN EXISTING CEILING. NO ALLOWANCE WILL BE MADE FOR LACK OF KNOWLEDGE OF EXISTING CONDITIONS.
- THIS CONTRACTOR SHALL BE HELD TO HAVE EXAMINED THE PREMISES AND SITE SO AS TO COMPARE THEM WITH THE DRAWINGS AND SPECIFICATIONS. NO ALLOWANCE SHALL BE MADE TO THE CONTRACTOR BY REASON OF HIS FAILURE TO HAVE MADE SUCH EXAMINATION OR OF ANY ERROR ON HIS PART.
- WHERE EXISTING SLABS ARE TO BE CUT OR CORE DRILLED, THE CONTRACTOR SHALL X-RAY THE EXISTING SLABS TO AVOID CUTTING OR DISRUPTING EXISTING CONDUITS, CABLES, PLUMBING OR STRUCTURAL
- HYAC SYSTEMS, PLUMBING SYSTEMS, AND ELECTRICAL SERVICE TO THE BUILDING SHALL NOT BE INTERRUPTED WITHOUT WRITTEN CONSENT OF THE
- AT THE COMPLETION OF THE PROJECT, ALL WORK UNDER THIS DIVISION SHALL BE COMPLETELY INTEGRATED WITH THE EXISTING SYSTEMS AND LEFT IN PERFECT OPERATING CONDITION.
- 6. PRIOR TO ANY DEMOLITION OR CONSTRUCTION THE CONTRACTOR SHALL HAVE THE EXISTING CONDITIONS INSPECTED BY AN EPA, OSHA CERTIFIED ASBESTOS ABATEMENT AGENCY TO IDENTIFY THE PRESENCE OF ASBESTOS. SHOULD ANY ASBESTOS BE FOUND IT SHALL BE BROUGHT TO THE IMMEDIATE ATTENTION OF THE ARCHITECT AND OWNER AND SPECIFICALLY IDENTIFIED IN

D. DRAWINGS

- DRAWINGS AND SPECIFICATIONS ARE TO BE CONSIDERED AS SUPPLEMENTING EACH OTHER. WORK SPECIFIED SHALL BE PERFORMED OR FURNISHED AS THOUGH MENTIONED IN BOTH SPECIFICATIONS AND DRAWINGS
- THE DRAWINGS ARE SCHEMATIC ONLY AND ARE INTENDED TO SHOW APPROXIMATE LOCATIONS. DO NOT SCALE.

E. SHOP DRAWINGS/SUBMITTALS

- THIS CONTRACTOR SHALL SUBMIT SHOP DRAWINGS ON THE ITEMS OF EQUIPMENT AND SYSTEMS AS NECESSARY TO CLEARLY SHOW EQUIPMENT
- AND CONSTRUCTION THE GENERAL CONTRACTOR SHALL REVEW, COMMENT AND STAMP THE SHOP DRAWINGS/SUBMITTALS PRIOR TO THE ENGINEER REVIEW.

F. SUPERVISION

THIS CONTRACTOR SHALL HAVE IN CHARGE OF THE WORK, A COMPETENT SUPERINTENDENT WITH EXPERIENCE IN THE WORK TO BE INSTALLED UNDER THIS CONTRACT.

G. COORDINATION

- THIS CONTRACTOR SHALL COORDINATE HIS WORK AND COOPERATE WITH THE OTHER CONTRACTORS. HE SHALL ARRANGE HIS WORK WITH THEIRS SO THAT THERE WILL BE NO DELAY IN THE PROPER INSTALLATION.
- EXAMINE WORK OF OTHER TRADES WHICH COMES IN CONTACT WITH OR IS COVERED BY THIS WORK. DO NOT ATTACH TO, COVER, OR FINISH AGAINST ANY DEFECTIVE WORK, OR INSTALL WORK OF THIS DIVISION IN A MANNER WHICH WILL PREVENT OTHER TRADES FROM PROPERLY INSTALLING THEIR WORK. CONSULT ALL DRAWINGS, SPECIFICATIONS AND DETAILS OF OTHER DIVISIONS OF THE WORK.

H. CUTTING AND PATCHING

ALL CUTTING AND PATCHING WORK RELATED TO THIS CONTRACT WILL BE THE RESPONSIBILITY OF THIS CONTRACTOR. REPAIRS SHALL MATCH NEW AND/OR EXISTING CONDITIONS.

I. GUARANTEE AND WARRANTIES

- CONTRACTOR SHALL WARRANT THAT EQUIPMENT AND ALL WORK IS INSTALLED IN ACCORDANCE WITH GOOD ENGINEERING PRACTICE AND THAT ALL EQUIPMENT WILL MEET REQUIREMENTS SPECIFIED. ANY EQUIPMENT FAILING TO PERFORM OR FUNCTION AS SPECIFIED SHALL BE REPLACED WITH COMPLYING EQUIPMENT, WITHOUT COST TO THE OWNER.
- GUARANTEE AGAINST DEFECTS IN WORKMANSHIP AND MATERIALS. MAKE GOOD REPAIR OR REPLACE ANY DEFECTIVE WORK, MATERIAL OR EQUIPMENT WITHIN (1) ONE YEAR FROM DATE OF ACCEPTANCE.

J. INSTALLATION REQUIREMENTS

LOCATIONS OF PIPING, EQUIPMENT, DUCTS, ETC., ON THE DRAWINGS IS DIAGRAMMATIC. INDICATED POSITIONS SHALL BE FOLLOWED AS CLOSELY AS POSSIBLE. EXACT LOCATIONS SHALL BE SUBJECT TO BUILDING CONSTRUCTION AND INTERFERENCES WITH OTHER WORK. ARCHITECT RESERVES THE RIGHT TO MAKE MINOR CHANGES IN LOCATION OF ANY PART OF THE WORK UP TO THE TIME OF ROUGHING-IN WITHOUT ADDITIONAL

K. TEST AND ADJUSTMENTS

OBTAIN ALL INSPECTIONS REQUIRED BY LAW, ORDINANCES, RULES, REGULATIONS OF AUTHORITIES HAVING JURISDICTION. FURNISH CERTIFICATES OF SUCH INSPECTIONS. PAY ALL FEES AND PROVIDE ALL EQUIPMENT, POWER AND LABOR NECESSARY FOR INSPECTIONS AND TEST.

A. ALL PIPING SHALL BE GIVEN THE FOLLOWING PRESSURE TEST WITHOUT APPRECIABLE PRESSURE DROP. EQUIPMENT WHICH WOULD BE DAMAGED BY THE REQUIRED TEST PRESSURE SHALL BE ISOLATED FROM THE SYSTEM DURING TESTING.

MEDIUM (PSI) DOMESTIC WATER WATER

B. SANITARY SEWERS PER STATE PLUMBING CODE AND LOCAL AUTHORITY.

L. HYAC SYSTEMS ADJUSTMENTS AND BALANCE

- PROVIDE A COMPLETE TEST AND BALANCE OF THE SYSTEMS THAT SERVE THIS SPACE. PLACE ALL HEATING, VENTILATING, AND AIR CONDITIONING SYSTEMS AND EQUIPMENT INTO FULL OPERATION AND CONTINUE OPERATION OF SAME DURING EACH WORKING DAY OF TESTING AND BALANCING. EVERY SUPPLY OUTLET SHALL BE TESTED AND BALANCED TO WITHIN 10% OF AIR QUANTITIES SHOWN. OUTSIDE AIR AND EXHAUST AIR SHALL BE BALANCED TO WITHIN 5% OF AIR QUANTITIES SHOWN. CFM OFFSETS WHERE CALLED OUT SHALL BE MET WITHIN 5% OF CFM LISTED.
- THE TEST AND BALANCE SHALL BE PERFORMED BY AN AABC OR NEBB CERTIFIED TEST AND BALANCE CONTRACTOR THAT MUST BE A DIFFERENT COMPANY THAN THE MECHANICAL CONTRACTOR.
- SUBMIT A CERTIFIED TEST AND BALANCE REPORT TO THE ENGINEER FOR APPROVAL REPORT SHALL INCLUDE (AT A MINIMUM) THE FOLLOWING:
- NAMEPLATE DATA FOR ALL POWERED DEVICES. DIFFUSER LAYOUT (DRAWING) DEPICTING ALL DIFFUSERS AND EQUIPMENT. DIFFUSER TAGS SHALL SHOW THE INITIAL AND FINAL READINGS OF ALL DIFFUSERS AND GRILLES.
- AIRFLOW AT UNIT SUPPLY, RETURN, AND OUTSIDE AIR (IF APPLICABLE) CONNECTIONS.
- AIRFLOW AT ALL SUPPLY AIR DIFFUSERS AIRFLOW AT ALL EXHAUST GRILLES.
- AIRFLOW AT OUTSIDE AIR CONNECTIONS.
- AIR TEMPERATURE INLET AND OUTLET AT EACH NEW HEATING OR COOLING COIL. DISCHARGE MAY BE RECORDED AT A DIFFUSER
- 4. FINAL DIFFUSER READINGS THAT DIFFER FROM THE DRAWINGS BY MORE THAN THE LIMITS ABOVE SHALL BE NOTED IN THE REPORT.
- EXISTING EQUIPMENT TO REMAIN: THE MECHANICAL CONTRACTOR SHALL THOROUGHLY INSPECT AND TEST THE OPERATION OF THE EACH EXISTING HEATING/COOLING SYSTEM (PRIOR TO TEST \$ BALANCE) AND SUBMIT ANY REPAIR/REPLACEMENT RECOMMENDATIONS TO THE ENGINEER. TEST AND BALANCE REPORT SHALL INCLUDE EXISTING DIFFUSERS WITH TAGS SHOWING EXISTING AIRFLOW READINGS.

M. INSULATION

- ALL INSULATION SHALL BE INSTALLED OVER CLEAN DRY SURFACES. INSULATION MUST BE DRY AND IN GOOD CONDITION. WET OR DAMAGED INSULATION WILL NOT BE ACCEPTABLE. NO INSULATION SHALL BE APPLIED PRIOR TO PRESSURE TEST COMPLETION OF THE RESPECTIVE PIPING SYSTEMS. INSTALLATION SHALL BE CONTINUOUS
- FIBERGLASS PIPE INSULATION SHALL BE INSTALLED WITH JOINTS BUTTED FIRMLY TOGETHER. JACKET LAPS TO BE SEALED WITH FACTORY APPLIED ADHESIVE. BUTT JOINTS TO BE SEALED WITH BUTT STRIPS, HAVING FACTORY APPLIED ADHESIVE YALVES AND FITTINGS SHALL BE INSULATED USING MITERED SECTIONS OF INSULATION, INSULATION CEMENT, OR PRE-MOLDED FITTING INSULATION. THE INSULATION APPLIED TO THE VALVES, FITTINGS AND THROUGH HANGERS SHALL BE COVERED WITH THE SAME TYPE OF COVERING AS USED ON THE PIPE INSULATION. PIPE SHIELDS TO BE PROVIDED AT ALL SUPPORTS.
- PROVIDE THE FOLLOWING INSULATION PRODUCTS AS MANUFACTURED BY OWENS-CORNING. INSULATION PRODUCTS AS MANUFACTURED BY ARMSTRONG. CERTAINTEED OR KNAUF ARE ACCEPTABLE. ADHESIVE SHALL BE BENJAMIN
- SUPPLY AND OUTSIDE AIR DUCT SHALL BE MINIMUM R=6.0 OR R=8.0 WHEN INSTALLED IN UNCONDITIONED SPACE. RETURN AIR SHALL BE INSULATED WHEN INSTALLED IN UNCONDITIONED SPACES, OR AS NOTED. EXHAUST DUCT SHALL BE INSULATED WHERE NOTED.
- DOMESTIC HOT WATER: I" THICK ASJ/SSL FIBERGLASS FOR PIPE SIZES 1-1/4" OR SMALLER, 1-1/2" THICKASJ/SSL FIBERGLASS FOR PIPE SIZES 1-1/2" ♥ GREATER.
- 5.2. DOMESTIC COLD WATER: I" THICK ASJ/SSL FIBERGLASS. 5.3. SUPPLY DUCT: 2" MINIMUM THICK DUCT WRAP. 5.4. REFRIGERANT PIPING: 1" THICK ASJ/SSL FIBERGLASS.
- 5.5. ALL INSULATION SHALL MEET 25/50 FLAME AND SMOKE SPREAD RATING FOR PLENUM APPLICATIONS.
- EXISTING \$ NEW PVC OR NON-COMPLIANT PLENUM RATED MATERIALS SHALL BE WRAPPED WITH 3M FIRE BARRIER OR EQUIVALENT PRODUCT OR CONSTRUCTED WITH PLENUM COMPLIANT MATERIALS.

N. DUCTWORK

- ALL DUCTWORK SHALL BE CONSTRUCTED AND INSTALLED IN COMPLIANCE WITH SMACNA HYAC DUCT CONSTRUCTION STANDARDS (2005 ED. OR
- NEW DUCTWORK SHALL BE CONSTRUCTED OF GALVANIZED SHEET METAL AND INSTALLED AS SHOWN ON THE DRAWINGS. ALL SHEETMETAL DUCT JOINTS ₹ SEAMS (MINIMUM SEAL CLASS B) SHALL BE SEALED WITH TAPES
- DUCT SIZES INDICATED ON PLANS ARE FREE INSIDE CLEAR DIMENSIONS UNLESS OTHERWISE NOTED

AND MASTICS AS LISTED IN UL STANDARDS 181A AND 181B.

- LEAKAGE RATE ALLOWANCE SHALL BE THE LESSER OF SMACNA CLASS B LEAKAGE CALCULATION OR 5% OF SYSTEM CFM.
- LOW PRESSURE FLEXIBLE DUCTWORK SHALL BE LIMITED TO 6' IN LENGTH. FLEXIBLE DUCTS SHALL BE INSTALLED IN A FULLY EXTENDED CONDITION FREE OF SAGS AND KINKS, USING ONLY THE MINIMUM LENGTH REQUIRED TO MAKE THE CONNECTION. FLEXIBLE DUCT SHALL BE LISTED AS A CLASS I AIR DUCT AND SHALL COMPLY WITH UL STANDARD 181, NFPA 90A \$ B. DUCT SHALL HAVE A MAXIMUM FLAME SPREAD RATING OF 25, A MAXIMUM SMOKE RATING OF 50, SHALL BE RATED FOR POSITIVE PRESSURE OF 10"(W.C.) AND NEGATIVE PRESSURE OF 1/2"(W.G.). INSULATION SHALL BE A MINIMUM OF 2" THICK 3/4" PCF DENSITY FIBERGLASS WITH A MINIMUM VALUE OF R=6.0. FLEXIBLE DUCT SHALL BE THERMAFLEX TYPE M-KE, FLEXMASTER TYPE 8M, OR EQUAL.
- EXISTING FLEXIBLE DUCT: REPAIR TORN OR DAMAGED VAPOR BARRIER/JACKET WITH DUCT TAPES LISTED AND LABELED TO UL 181B. IF INTERNAL CORE IS PENETRATED, REPLACE FLEXIBLE DUCT OR TREAT AS A
- ELBOWS 45 DEGREES \$ GREATER IN ALL DUCT SYSTEMS MUST BE EITHER FULL-RADIUS OR MITERED WITH TURNING YANES.
- INSTALL TURNING VANES FOR ALL RECTANGULAR MITERED ELBOWS. 1.2. FOR DUCTS WITH VELOCITIES LESS THAN 2,200 FPM PROVIDE SINGLE WALL
- 1.3. FOR DUCTS WITH VELOCITIES GREATER THAN 2,200 FPM PROVIDE DOUBLE WALL TYPE.
- FIRE DAMPERS IN DUCTWORK SHALL BE TYPE 'B' STYLE WITH SHUTTER OUTSIDE OF AIRSTREAM.

O. MATERIALS

- PIPE AND FITTINGS DOMESTIC WATER TYPE "L" HARD COPPER.
- WASTE \$ VENT PIPING (ABOVE GROUND INTERIOR): NO-HUB CAST IRON. BUILDING SEWERS \$ DRAINS (UNDERGROUND): SANITARY SEWERS SHALL BE SERVICE WEIGHT CAST IRON, BELL \$ SPIGOT, SOIL PIPE WITH TYLER "TY-SEAL" NEOPRENE PIPE

P. WASTE SYSTEMS

- RUN ALL DRAINAGE PIPING AS DIRECT AS POSSIBLE. ACTUAL LOCATION OF DRAINS AND WASTE PIPING SHALL MEET THE VARIOUS BUILDING CONDITIONS. DO ANY WORK NECESSARY TO CONCEAL PIPING OR CLEAR PIPING OF OTHER TRADES.
- HUB DRAINS SHALL BE PROVIDED WITH TRAP PRIMER.
- WASTE PIPING SHALL BE SLOPED AT A MINIMUM OF 1/4" PER FOOT FOR PIPE SIZES 2-1/2" OR LESS, 1/8" PER FOOT FOR PIPE SIZES 3" TO 6" AND 1/16" PER FOOT FOR PIPE SIZES 8" OR GREATER.

Q. PIPING HANGER SPACING

10' PIPE LENGTH ARE UTILIZED.

- INSTALL HANGERS AND SUPPORTS IN PIPING SYSTEMS TO REMOVE STRESS FROM SYSTEM. SPACE HANGERS AND SUPPORTS PER THE FOLLOWING TABLES: .1. COPPER PIPE: 1-1/4" OR SMALLER - 6' MAXIMUM SPACING \$ 1-1/2" OR LARGER - 10' 1.2.CAST IRON PIPE: ALL SIZES - 5' MAXIMUM SPACING (SPACING OF 10' MAY BE USED WHEN
- 1.3. PVC PIPE: ALL SIZES 4' MAXIMUM SPACING 1.4. CPVC PIPE: 1" OR SMALLER - 3' MAXIMUM SPACING \$ 1-1/4" OR LARGER - 4' MAXIMUM SPACING

VALVES IN WATER PIPING: BALL VALVES WITH SCREWED ENDS, MIN. 150 LBS., SWP. YALYES USED FOR SHUT-OFF AND BALANCING SHALL BE EQUIPPED

S. WIRING

- ALL WIRING INCIDENTAL TO THIS TEMPERATURE CONTROL SYSTEM SHALL BE PROVIDED BY THE MECHANICAL CONTRACTOR.
- THE TERM "WIRING" SHALL BE CONSTRUED TO INCLUDE FURNISHING OF WIRE, CONDUIT, MISCELLANEOUS MATERIALS AND LABOR AS REQUIRED FOR MOUNTING AND CONNECTING ELECTRICAL CONTROL DEVICES, AND CONNECTING ELECTRICAL DEVICES, AND PROVIDING ELECTRICAL INTERLOCKS BETWEEN EQUIPMENT.


T. EQUIPMENT

SEE SCHEDULES ON DRAWING.

- THE BASIS OF DESIGN INDICATED ON ALL SCHEDULES CONTAINED ON THESE DRAWING INDICATES MINIMUM QUALITY AND CONSTRUCTION STANDARDS. ALTERNATE MANUFACTURERS EQUIPMENT MAY BE USED SO LONG AS THE EQUIPMENT / DEVICE MEETS OR EXCEEDS THE QUALITY OF THE BASIS OF DESIGN. CONTRACTOR SHALL BE RESPONSIBLE FOR COORDINATING SPACE REQUIREMENTS FOR ALTERNATE
- WHERE A PRODUCT IS SUBSTITUTED FOR A "BASIS OF DESIGN" PRODUCT, THE CONTRACTOR SHALL NOTIFY THE DESIGN TEAM THAT CHANGES IN PROJECT MAY BE MANDATORY IN ORDER TO PERMIT THE USE AND THE INSTALLATION OF THE SUBSTITUED PRODUCT. SHOP DRAWING SUBMITTALS FOR A SUBSTUTE PRODUCT SHALL INCLUDE A COMPLETE SCHEDULE OF CHANGES IN PROJECT DESIGN, IF ANY, WHICH MUST BE MADE IN ORDER TO PERMIT USE AND INSTALLATION OF THE SUBSTITUTED PRODUCT. THE CONTRACTOR SHALL BE RESPONSIBLE FOR THE COORDINATION OF ALL TRADES FOR USE OF THE SUBSTITUTED PRODUCT. THE CONTRACTOR SHALL BEAR ALL EXPENSES RELATED TO THE USE OF A SUBSTITUE

PROVIDE CONTROLS COMPATIBLE WITH EXISTING BUILDING SYSTEM.

- UPDATE THE GRAPHICS FOR FRONT END OF THE BUILDING AUTOMATION SYSTEM
- THERMOSTATS TO BE RELOCATED AS INDICATED ON PLANS.

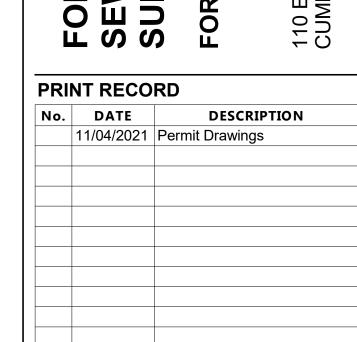

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SPECIFICATIONS -MECHANICAL


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ITEMS UNDERNEATH HATCHING ARE NOT WITHIN THE SCOPE OF WORK.

KEY NOTES:

1) RELOCATE SLOT DIFFUSERS TO FIT NEW ARCHITECTURAL RCP.





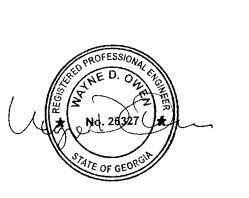

WATER -ORSYTH COUNTY N SEWER SUITE 150

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Job No.

Date 11/04/2021

Sheet Title FLOOR PLAN - HVAC

Sheet No.

M-2.00 RELEASED FOR CONSTRUCTION

SYMBOL

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DESCRIPTION

FLUORESCENT LIGHT FIXTURE

EMERGENCY LIGHT FIXTURE

CEILING MOUNTED LIGHT FIXTURE

⟨?>-----

EXIT SIGN (PROVIDE FACES AND ARROWS AS SHOWN) WALL MOUNTED EXIT SIGN (PROVIDE FACES AND ARROWS AS SHOWN) CONDUIT RUN CONCEALED IN WALL OR CEILING CONDUIT RUN CONCEALED IN THE FLOOR, UNDERGROUND, OR UNDER THE ELEVATED CONDUIT RUN EXPOSED. ROUTE PARALLEL/PERPENDICULAR TO WALLS AND STRUCTURE. CIRCUITS HOMERUN TO THE PANEL NUMBER OF CONDUCTORS (GROUND NOT SHOWN) \sim FLEXIBLE CONDUIT OR CORD PLYWOOD BACKBOARD. $\frac{1}{4}$ D(UNO) \times 8' H (UNO) \times WIDTH AS SHOWN ON PLANS. PAINT WITH FIRE RETARDANT PAINT PRIOR TO INSTALL. → AND → DUPLEX AND QUAD RECEPTACLE - WALL MOUNTED ISOLATED GROUND DUPLEX RECEPTACLE - WALL MOUNTED GFCI DUPLEX AND QUAD RECEPTACLE - WALL MOUNTED ***** OUTLET ABOVE THE COUNTER 6" ABOYE COUNTER SWITCHED DUPLEX RECPTACLE. SWITCH THE BOTTOM HALF. SPECIAL AMP/VOLT RECEPTACLE - WALL MOUNTED USB COMBO RECEPTACLE ₹ (2) USB CHARGING PORTS - 20A RECEPTACLE - HUBBELL USB20×2 CEILING MOUNTED RECEPTACLE FLOOR MOUNTED RECEPTACLE VOICE AND DATA OUTLET - WALL MOUNTED - PROVIDE JUNCTION BOX AND 3/4" CONDUIT TO 6" ABOVE ACCESSIBLE CEILING. PROVIDE 90 DEG ELBOW ABOVE CEILING WITH PLASTIC GROMMET FLOOR VOICE AND DATA OUTLET. PROVIDE 1.25" CONDUIT TO NEAREST WALL AND THEN UP TO 6' ABOYE ACCESSIBLE CEILING. PROVIDE 30 DEG ELBOW ABOYE CEILING WITH PLASTIC GROMMET. VOICE OUTLET - WALL MOUNTED - PROVIDE JUNCTION BOX AND 3/4" CONDUIT TO 6" ABOVE ACCESSIBLE CEILING. PROVIDE 90 DEG ELBOW ABOVE CEILING. WITH PLASTIC GROMMET. FLOOR BOX RECEPTACLE AND DATA - - WIREMOLD # RFB4 SERIES WITH 20A DUPLEX. PROVIDE 1.5" CONDUIT TO NEAREST WALL AND THEN UP TO 6" ABOVE ACCESSIBLE CEILING. PROVIDE 90 DEG ELBOW ABOVE CEILING WITH PLASTIC GROMMET FOR DATA. RECEPTACLE AND DATA MULTI-SERVICE POKE THRU - WIREMOLD # RC4 SERIES. PROVIDE 1.25" CONDUIT TO NEAREST WALL AND THEN UP TO 6" ABOVE ACCESSIBLE CEILING. PROVIDE 90 DEG ELBOW ABOVE CEILING WITH PLASTIC GROMMET FOR DATA. TELEVISION CABLE OUTLET - PROVIDE CABLE RECESSED FLAT PANEL ENCLOSURE WITH DUPLEX RECEPTACLE AND AV/DATA BOX -HUBBELL #NGAV62M WITH #NFAV6C COVER, #NGOKP POWER KIT AND AV FRAME. V₩ COORDINATE MOUNTING HEIGHT WITH ARCHITECT PRIOR TO ROUGHIN. PROVIDE 1.25" CONDUIT FOR DATA AND ¾" CONDUIT FOR CABLE TO 6" ABOVE ACCESSIBLE CEILING. PROVIDE 90 DEG ELBOW ABOVE CEILING WITH PLASTIC GROMMET FOR DATA AND CABLE. (1)JUNCTION BOX. SIZE AS REQUIRED. PROVIDE CONDUIT AS REQUIRED. JUNCTION BOX - WALL MOUNTED - CONDUIT TO 6" ABOYE ACCESSIBLE CEILING AS REQUIRED \$/\$₃/\$₇/\$_P SPST SWITCH / 3-WAY SWITCH / TIMER SWITCH / PILOT SWITCH - WALL MOUNTED DIMMER SWITCH / LOW YOLTAGE DIMMER SWITCH - WALL MOUNTED (PROVIDE WATTAGE AS \$ D / \$ LVD REQUIRED) MOTOR RATED SWITCH \$ M WALL MOUNTED OCCUPANCY SENSOR - WATTSTOPPER WS-250 (LEVITON OSSMT-GDW). COLOR TO MATCH STANDARD OUTLETS WALL MOUNTED OCCUPANCY SENSOR - TWO RELAY SWITCH - WATTSTOPPER PW-302 OR EQUAL. <u>os</u>>. COLOR TO MATCH STANDARD OUTLETS CEILING MOUNTED OCCUPANCY SENSOR - WATTSTOPPER CI-200 (LEVITON OSC20-MOW). PROVIDE ACCESSORIES AS REQ'D. POWER PACK FOR OCCUPANCY SENSOR - TYPE AS REQUIRE. PANELBOARD OR DISTRIBUTION PANEL TRANSFORMER (FLOOR OR CEILING MOUNTED NOTED ON PLANS) DISCONNECT (FRAME AND POLES TO MATCH OVER CURRENT PROTECTION REQUIRED PER NEC OR AS NOTED) 48" AFF TO TOP OF BOX FIRE ALARM PULL STATION - WALL MOUNTED 図 FIRE ALARM ADA APPROVED AUDIO/VISUAL (110CD) BOTTOM OF VISUAL **⊠**• FIRE ALARM ADA APPROVED SPEAKER HORN AUDIO / VISUAL (110CD) BOTTOM OF VISUAL 80" AFF TO FIRE ALARM ADA APPROVED VISUAL ONLY (110CD) BOTTOM OF VISUAL FIRE ALARM PULL STATION AT 48" AFF TO TOP OF BOX AND AUDIO/VISUAL AT 80" AFF AT 80" AFF TO BOTTOM OF VISUAL $\langle 2 \rangle$ SMOKE DETECTOR - CEILING MOUNTED - QUANTITY AS REQUIRED PEN NFPA SMOKE DETECTOR - PENDANT MOUNTED IN FRONT OF RETURN AIR OPENING - QUANTITY AS ②_P REQUIRED PEN NFPA

DUCT MOUNTED SMOKE DETECTOR - QUANTITY AS REQUIRED PEN NFPA

ELECTRICAL DEVICES TO BE DEMOLISHED (APPLIES TO DEMOLITION PLANS ONLY)

ELECTRICAL LEGEND

MOUNTING HEIGHT

ON CENTER

(COORD WITH ARCH)

FIRE ALARM NOTES

- ALL NEW FIRE ALARM DEVICES SHALL BE ADA APPROVED.
- ALL AUDIO/VISUAL DEVICES SHALL MATCH EXISTING.
- ALL FIRE ALARM DEVICES ARE TO BE CONNECTED TO THE BASE BUILDING FIRE ALARM SYSTEM BY A NICET LEVEL 3 LISCENSED INSTALLER AS APPROVED BY THE LANDLORD.
- 4. CONFIRM EXISTING A/V LOADS AND PROVIDE NEW POWER SUPPLIES WITHIN THIS TENANT SPACE AS
- ALL WORK ASSOCIATED WITH THE FIRE ALARM SHALL BE COORDINATED WITH THE BUILDING'S CHIEF
- ADDITIONS AND ALTERATIONS TO THE FIRE ALARM SYSTEM REQUIRE TESTING, A RECORD OF COMPLETION, AND RECERTIFICATION. ADDITIONALLY, THE WORK SHALL BE PERFORMED BY QUALIFIED PERSONNEL AS DEFINED IN NFPA 72 (2013), 10.4.2.
- CONTRACTOR TO VERIFY EXISTING FIRE ALARM SYSTEM IS MONITORED BY AN APPROVED SUPERVISING STATION IN ACCORDANCE WITH NFPA 12.

	HEET LIST ELECTRICAL	
9	HEET LIST ELECTRICAL	
SHEET NUMBER	SHEET NAME	
E-0.01	ELECTRICAL SYMBOLS AND NOTES	
E-0.02	ELECTRICAL DETAILS	
E-1.00	FLOOR PLAN - DEMOLITION	
F-2 00	FLOOR PLAN - FLECTRICAL \$ LIGHTING	

ELECTRICAL ABBREVIATIONS SYMBOL DESCRIPTION ABOYE COUNTER AFF ABOVE FINISHED FLOOR BELOW FINISHED GRADE E/R EXISTING / RELOCATED FIRE ALARM ANNUNCIATOR PANEL FACP FIRE ALARM CONTROL PANEL UNO UNLESS NOTED OTHERWISE WEATHER PROOF TRANSFORMER

ELECTRICAL GENERAL NOTES:

- ALL WORK SHALL COMPLY WITH ALL LOCAL BUILDING CODES, LAWS, REGULATIONS, ORDINANCES AND 2014 NATIONAL ELECTRICAL CODE.
- THE ELECTRICAL WORK SHALL CONSIST OF ALL LABOR AND MATERIAL TO COMPLETELY INSTALL ALL ELECTRICAL WORKS AS SHOWN ON THESE
- COORDINATE LOCATION OF LIGHT FIXTURES IN AREAS OF MECHANICAL DUCTWORK AND PIPING WITH MECHANICAL CONTRACTOR. RELOCATE LIGHT FIXTURES, WIRING AND CONDUIT IF NECESSARY AS DIRECTED BY THE ARCHITECT/ENGINEER.
- ALL WORK ASSOCIATED WITH THE SCOPE OF THIS PROJECT INCLUDING EQUIPMENT, ACCESSORIES, DEVICES, SYSTEMS, ETC. SHALL BE COVERED BY A ONE YEAR GUARANTEE WHICH SHALL START AT THE TIME OF FINAL ACCEPTANCE BY THE OWNER. ANY DEFECTS IN PRODUCTS, INSTALLATION, OR WORKMANSHIP SHALL BE CORRECTED AT NO ADDITIONAL CHARGE AND SHALL INCLUDE ANY NECESSARY REPAIRS TO WALLS, FLOORS, MILLWORK, ETC. WHICH SHALL BE REPAIRED BACK TO NEW AND FINISHED CONDITION.
- THE CONTRACTOR SHALL KEEP A RECORD OF THE CHANGES WHICH ARE IN CONFLICT WITH THESE DRAWINGS AND SPECIFICATIONS. AT THE COMPLETION OF THIS WORK THE CONTRACTOR SHALL SUBMIT "AS BUILT" PRINTS TO THE OWNER.
- THE DRAWINGS ARE DIAGRAMMATIC AND DO NOT NECESSARILY SHOW THE EXACT ROUTING OR DETAILED FITTINGS. ALL WORK SHALL BE INSTALLED AS A COMPLETE SYSTEM WITH NECESSARY COMPONENTS, FITTINGS, STRAPS, ETC. ALL JUNCTION BOXES AND COMPONENTS SHALL BE INSTALLED SO
- REFER TO THE ENTIRE CONTRACTED DRAWING SET AND SPECIFICATIONS FOR GUIDANCE ON DIMENSIONS, CEILING HEIGHTS, DOOR SWINGS, ROOM FINISHES, STRUCTURAL DETAILS, LOCATIONS OF DUCTWORK, PIPING AND STRUCTURAL MEMBERS. INSTALL THE ELECTRICAL SYSTEMS SO AS NOT TO INTERFERE WITH THE INSTALLATION OR FUNCTION OF ANOTHER DISCIPLINES WORK.
- ALL CONDUIT MUST BE CONCEALED ABOVE THE CEILING OR IN THE WALLS UNLESS OTHERWISE NOTED.
- COORDINATE RECEPTACLE NEMA TYPE AND VOLTAGE WITH ALL EQUIPMENT.
- THE CONTRACTOR SHALL INSTALL ALL WORK IN A NEAT AND WORKMANLIKE MANNER AND ACCORDING TO GENERALLY ACCEPTED PRACTICES OF
- PROVIDE A NEW DIRECTORY FOR ALL PANELS. CORRECTLY LABEL ALL CIRCUITS, SPACES AND SPARES PER NEC 408.4.
- ALL RECESSED LIGHTING FIXTURES SHALL BE FASTENED TO STRUCTURE OR GRID PER N.E.C. 410.
- ANY CONDUIT, BUSWAY, CABLE TRAY, SLEEVES, ETC. THAT PENETRATE RATED WALLS, CEILINGS AND FLOORS SHALL BE FIRE STOPPED PER CODE.
- 14. MOUNTING HEIGHTS FOR DEVICES ARE TO BE MEASURED TO THE DEVICE CENTERLINE.
- 15. ALL BRANCH CIRCUITS SHALL BE WIRED 1/2"C, 2-#12, 1-#12G MINIMUM, UNLESS OTHERWISE NOTED ON THE PLANS. ALL HOMERUNS SHALL BE A MINIMUM 3/4"
- 16. MULTIWIRE BRANCH CIRCUITS MAY NOT BE USED. PROVIDE SEPARATE NEUTRAL FOR EACH CIRCUIT OF A DIFFERENT PHASE. OVERCURRENT PROTECTION SHALL COMPLY WITH NEC 210.4.
- PROVIDE A SEPARATE GREEN, INSULATED, #12AWG EQUIPMENT GROUNDING CONDUCTOR ROUTED WITH THE BRANCH CIRCUIT HOMERUN CONDUCTORS. PROVIDE GROUND THROUGH ENTIRE CONDUIT RUN TO THE LAST DEVICE. ALL EQUIPMENT SHALL BE GROUNDED AT THE PANEL WHICH FEEDS THE EQUIPMENT. PROVIDE GROUNDING PER NEC 250.
- ALL SWITCHES FOR LIGHTS, FANS, ETC., WHICH ARE SHOWN TO BE MOUNTED IN THE SAME GENERAL AREA, SHALL SHARE A MULTI-GANG COVER PLATE
- AS REQUIRED. ARMORED CABLE MAY BE USED IN WALLS AND MILLWORK ONLY AND MUST BE MC TYPE (WITH GROUND). ALL CONDUIT TO AND ABOVE THE PLENUM
- SHALL BE EMT. ALL HOMERUNS SHALL BE IN CONDUIT RAN FROM THE FIRST DEVICE OR LIGHT FIXTURE TO THE PANEL. 20. THE CONTRACTOR SHALL REFER TO ARCHITECTURAL PLANS FOR EXACT LOCATIONS OF OUTLETS, LIGHT FIXTURES, AND PARTITIONS. FINISHES FOR DEVICES AND COVERPLATES SHALL BE AS SELECTED BY ARCHITECT.
- PROVIDE A 2-GANG OUTLET BOX AND 1" CONDUIT WITH PULL STRING TO ABOVE ACCESSIBLE CEILING

FOR ALL NEW DATA, TELEPHONE AND CABLE OUTLETS. COORDINATE PLASTER RING SIZE WITH TENANT AND CABLE VENDOR.

- LIGHT FIXTURES SHALL BE AS SCHEDULED, WITH ONLY PRE-APPROVED EQUAL FIXTURES ACCEPTABLE.
- FLUORESCENT LAMPS SHALL BE RAPID START, 32W, OR LOW MERCURY CONTENT, AND OF NOT LESS THAN 2900 LUMEN OUTPUT UNLESS OTHERWISE
- FLUORESCENT BALLASTS SHALL BE ELECTRONIC WITH A MAXIMUM OF 10% THD AND AS MANUFACTURED BY ADVANCE, OSRAM/SYLVANIA, GE/MAGNETEK, OR MOTOROLA.
- 25. ALL CONDUCTORS SHALL BE COPPER. CONDUCTORS FOR SIZES NO. 10 AND SMALLER SHALL BE TYPE "THWN" OR "THHN/THWN". CONDUCTORS FOR 91ZE9 NO. 8 AND LARGER 9HALL BE TYPE "XHHW". 9OLID CONDUCTORS TERMINATING IN A BREAKER OR DEVICE SHALL BE UTILIZED FOR WIRE 91ZE NO. 12. MINIMUM WIRE SIZE SHALL BE NO. 12.
- 26. ALL BOXES SHALL BE PRESSED STEEL, SINGLE PIECE (NON-GANGABLE) TYPE.
- 27. ALL COVER PLATES SHALL BE STAINLESS STEEL.
- 28. ALL COVER PLATES FOR DEVICES AND JUNCTION BOXES SHALL HAVE CIRCUIT NUMBERS LABELED WITH INDELIBLE INK MARKER. DEVICE COVERS SHALL BE LABELED ON THE BACK, JUNCTION BOX COVERS SHALL BE LABELED ON THE FRONT.
- RECEPTACLES SHALL BE 120 VOLT, 20A, WITH PARTS NUMBERS AS LISTED BY HUBBELL OR EQUAL BY ARROWHART, P\$S, OR LEVITON. COLOR SHALL

30. SWITCHES SHALL BE 120/2717/, 20A, WITH PARTS NUMBERS AS LISTED BY HUBBELL OR EQUAL BY ARROWHART, P\$S, OR EAGLE. COLOR SHALL BE AS SELECTED BY THE ARCHITECT.

```
SINGLE POLE
                        #HBL1221×
 THREE WAY
                        #HBL1223X
FOUR WAY
                        #HBL1224X
(ADD "L" SUFFIC FOR KEYED LOCKING TYPE)
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- 31. PANELBOARDS, MOTOR STARTERS, SAFETY SWITCHES (HEAVY DUTY), ETC. SHALL BE AS MANUFACTURED BY GENERAL ELECTRIC, SQUARE D, SIEMENS, OR CUTLER HAMMER. ALL BREAKERS SHALL BE "BOLT-ON" TYPE.
- 32. FOR EQUIPMENT THAT IS TO BE WIRED BY ELECTRICAL CONTRACTOR AND FURNISHED BY OTHERS, ELECTRICAL CONTRACTOR SHALL REVIEW ALL SPECIFICATION SECTIONS, EQUIPMENT SCHEDULES, AND/OR DETAILS THROUGHOUT DOCUMENTS THAT PERTAIN TO THIS EQUIPMENT AND INCLUDE ALL WIRING AND DEVICES REFERENCED IN THEIR BIDS. ELECTRICAL CONTRACTOR SHALL COORDINATE EXACT LOCATION OF THIS EQUIPMENT WITH RESPECTIVE CONTRACTOR PRIOR TO ROUGH-IN.
- 33. ALL ABANDONED WIRE SHALL BE REMOVED.
- WHERE WORK BY THE GENERAL CONTRACTOR (WALL REMOVE, NEW OR RELATED WALL OPENING, ETC.) RESULTS IN THE REMOVALS, REFEEDING, OR RELOCATION OF LIGHTING FIXTURES OR ELECTRICAL DEVICES, THE ELECTRICAL CONTRACTOR SHALL DISCONNECT OR RECONNECT AS REQUIRED ALL ACTIVE DEVICES REMAINING ON THAT CIRCUIT SYSTEM.
- RING OUT ALL CIRCUITS IN EXISTING PANEL AFFECTED BY THIS ALTERATION. WHERE ADDITONAL CIRCUITS ARE NEEDED, REFUSE CIRCUITS AVAILABLE FOR REUSE, OR PROVIDE NEW BREAKERS. TAG ALL UNUSED CIRCUITS AS SPARE, REPLACE ALL INOPERATIVE OR DEFECTIVE CIRCUIT BREAKERS, AND
- WHERE DEMOLITION DISRUPTS ELECTRICAL CONTINUITY OF EXISTING RECEPTACLES/LIGHTS, AND NO RECONNECTION IS SHOWN, RECONNECT TO ITS EXISTING CIRCUIT.
- ALL DIMENSIONS OF EXISTING CONSTRUCTION ARE APPROXIMATE. THE ELECTRICAL CONTRACTOR SHALL MAKE ALL NECESSARY FIELD MEASUREMENTS OF EXISTING STRUCTURES AND EQUIPMENT TO VERIFY DIMENSIONS SHOWN ON THE DRAWINGS. PROVIDE PROPER DIMENSIONS NOT SHOWN PRIOR TO EQUIPMENT FABRICATION. ALL COST FOR MODIFICATIONS OF NEW CONSTRUCTION DUE TO LACK OF CONFIRMATION OF DIMENSIONS BY FIELD MEASUREMENT SHALL BE THE RESPONSIBILITY OF THE ELECTRICAL CONTRACTOR.
- PROVIDE 120 VOLT POWER FOR ALL SMOKE/FIRE DAMPERS AND TIE DAMPERS BACK TO THE BUILDING FIRE ALARM SYSTEM SO THAT UPON ACTIVATION OF DUCT MOUNTED SMOKE DETECTOR OR INDIVIDUAL SENSORS ASSOCIATED WITH DAMPER A SIGNAL WILL BE SENT BACK TO THE BUILDING FIRE ALARM SYSTEM INDICATING ALARM AND STATUS OF DAMPER (OPEN/CLOSED). CONTRACTOR SHALL PROVIDE ALL WIRING, DUCT MOUNTED SMOKE DETECTORS, MODULES, RELAY, AND ASSOCIATED EQUIPMENT REQUIRED FOR A COMPLETE INSTALLATION. COORDINATE EXACT CONNECTION REQUIREMENTS BETWEEN ALL TRADES. (ELECTRICAL MECHANICAL 🕏 FIRE PROTECTION). CONTRACTOR SHALL COORDINATE QUANTITIES OF DUCT MOUNTED SMOKE DETECTORS.
- CONDUCTORS SHALL HAVE COLOR CODED JACKETS THE ENTIRE LENGTH FOR SIZES NO. 6 AND SMALLER. THE CONDUCTORS FOR SIZES NO. 4 AND LARGER SHALL HAVE COLOR CODED MARKING TAPE OR COLOR CODED JACKETS THE ENTIRE LENGTH. COLORS SHALL BE AS FOLLOWS

120/208 VOLT SYSTEM PHASE 'A' - BLACK 211/480 VOLT SYSTEM PHASE 'A' - BROWN PHASE 'B' - RED PHASE 'B' - ORANGE PHASE 'C' - BLUE PHASE 'C' - YELLOW NEUTRAL - WHITE NEUTRAL - GRAY GROUND - GREEN GROUND - GREEN

- WHERE PHASE MARKING TAPE IS USED IT SHALL BE WRAPPED 2" WIDE AND LOCATED AT TWO (2) LOCATIONS 6" AND 18" FROM THE TERMINATION. PHASE MARKING TAPE FOR THE NEUTRAL AND GROUNDING CONDUCTORS SHALL BE PROVIDED WHERE VISIBLE AT ANY POINT WHERE THE CONDUCTOR IS ACCESSIBLE.
- FIELD IDENTIFY EXISTING PANELBOARDS THAT ARE MODIFIED PER NEC 408.4(B).
- 42. PROVIDE ARC-FLASH WARNING LABELS ON ELECTRICAL EQUIPMENT THAT COMPLIES WITH NEC 110.16.
- 43. PROVIDE CONSPICUOUS AND PERMANENT LABEL ON NEW PANELBOARDS INDICATING AVAILABLE FAULT CURRENT PER NEC 110.24.



102 Mary Alice Park Road, Suite 103 Cumming, GA 30040



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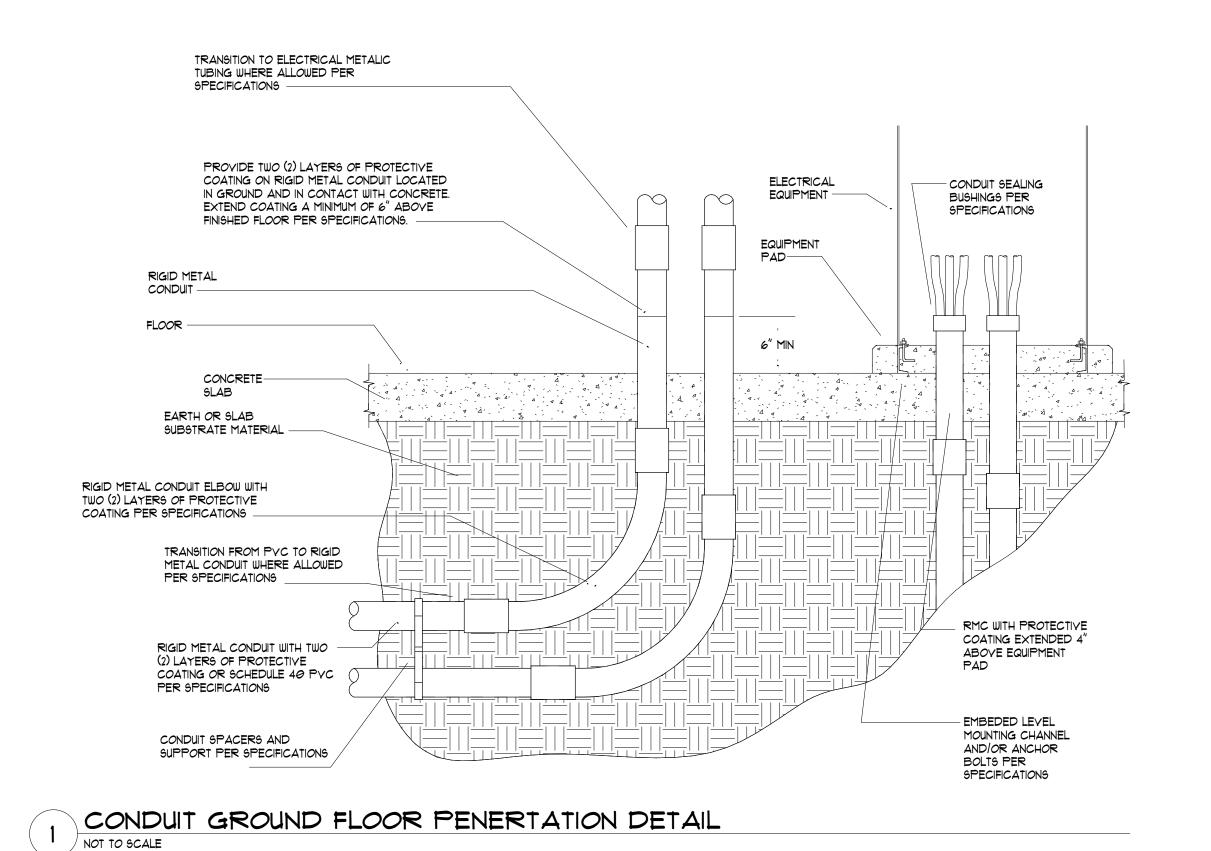
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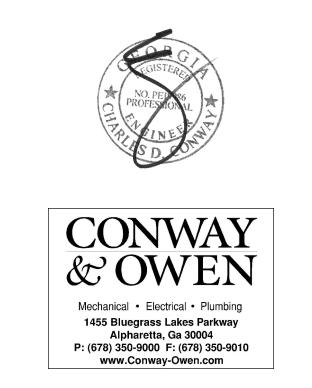
Sheet Title **ELECTRICAL SYMBOLS AND**

Sheet No.

NOTES







RSYTH COUNTY WATER WER TE 150

SUITE 150

110 E MAIN STREET CUMMING, GA 30040

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DETAILS

ELECTRICAL

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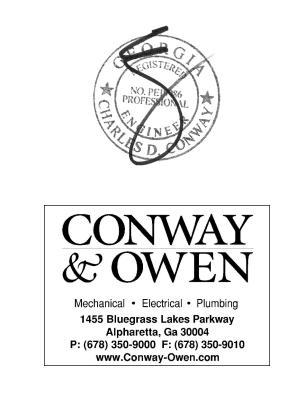
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DEMOLITION NOTES:

- REMOVE AND DISCARD ALL LIGHT FIXTURES IN AREAS OF WORK. COORDINATE EXACT WORK AREAS WITH ARCHITECTURAL
- DOCUMENTS. REFER TO LIGHTING PLAN FOR EXISTING FIXTURES TO REMAIN / BE RELOCATED. 2. ALL EXISTING FIXTURES AND MATERIAL SHALL BE DISPOSED OF AT AN APPROVED DISPOSAL FACILITY.
- WHERE DEMOLITION DISRUPTS THE ELECTRICAL CONTINUITY OF EXISTING RECEPTACLES/LIGHTS AND NO RECONNECTION IS SHOWN, RECONNECT TO IT'S EXISTING CIRCUIT.
- 4. ALL ABANDONED WIRE SHALL BE REMOVED. 5. ALL ABANDONED CONDUIT AND BOXES THAT ARE NOT IN CONCRETE SHALL BE REMOVED.
- 6. SEE ELECTRICAL AND LIGHTING PLANS FOR MORE INFORMATION.

1. REFER TO ARCHITECTURAL DRAWINGS FOR FULL SCOPE OF DEMOLITION WORK.





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FLOOR PLAN -**DEMOLITION**


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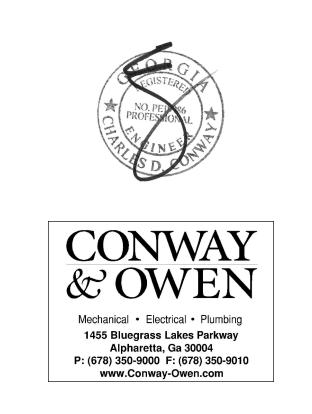
KEY NOTES: (APPLY TO ELECTRICAL PLANS ONLY) CONNECT TO EXISTING EMERGNECY RECEPTACLE CIRCUIT PREVUOSLY SERVING THE ROOM. REFER TO DEMOLITION PLAN FOR ADDITIONAL NOTES. $\langle 2
angle$ connect to existing circuit currently serving the orange receptacle in the room. 3 CONNECT TO EXISTING NORMAL RECEPTACLE CIRCUIT PREVIOUSLY SERVING THE ROOM. LOW VOLTAGE NOTES CONTRACTOR SHALL INCLUDE LOW VOTAGE CABLING AND TERMINATION IN SCOPE OF WORK. COORDIANTE ALL REQUIRMENTS, FULL SCOPE OF WORK AND STANDARDS WITH ARCHITECT / FORSYTH COUNTY.

KEY NOTES: (APPLY TO LIGHTING PLANS ONLY) (1) CONNECT TO EXISTING LIGHTING CIRCUIT PREVIOUSLY SERVING THE OFFICE AREA.



(B.5)



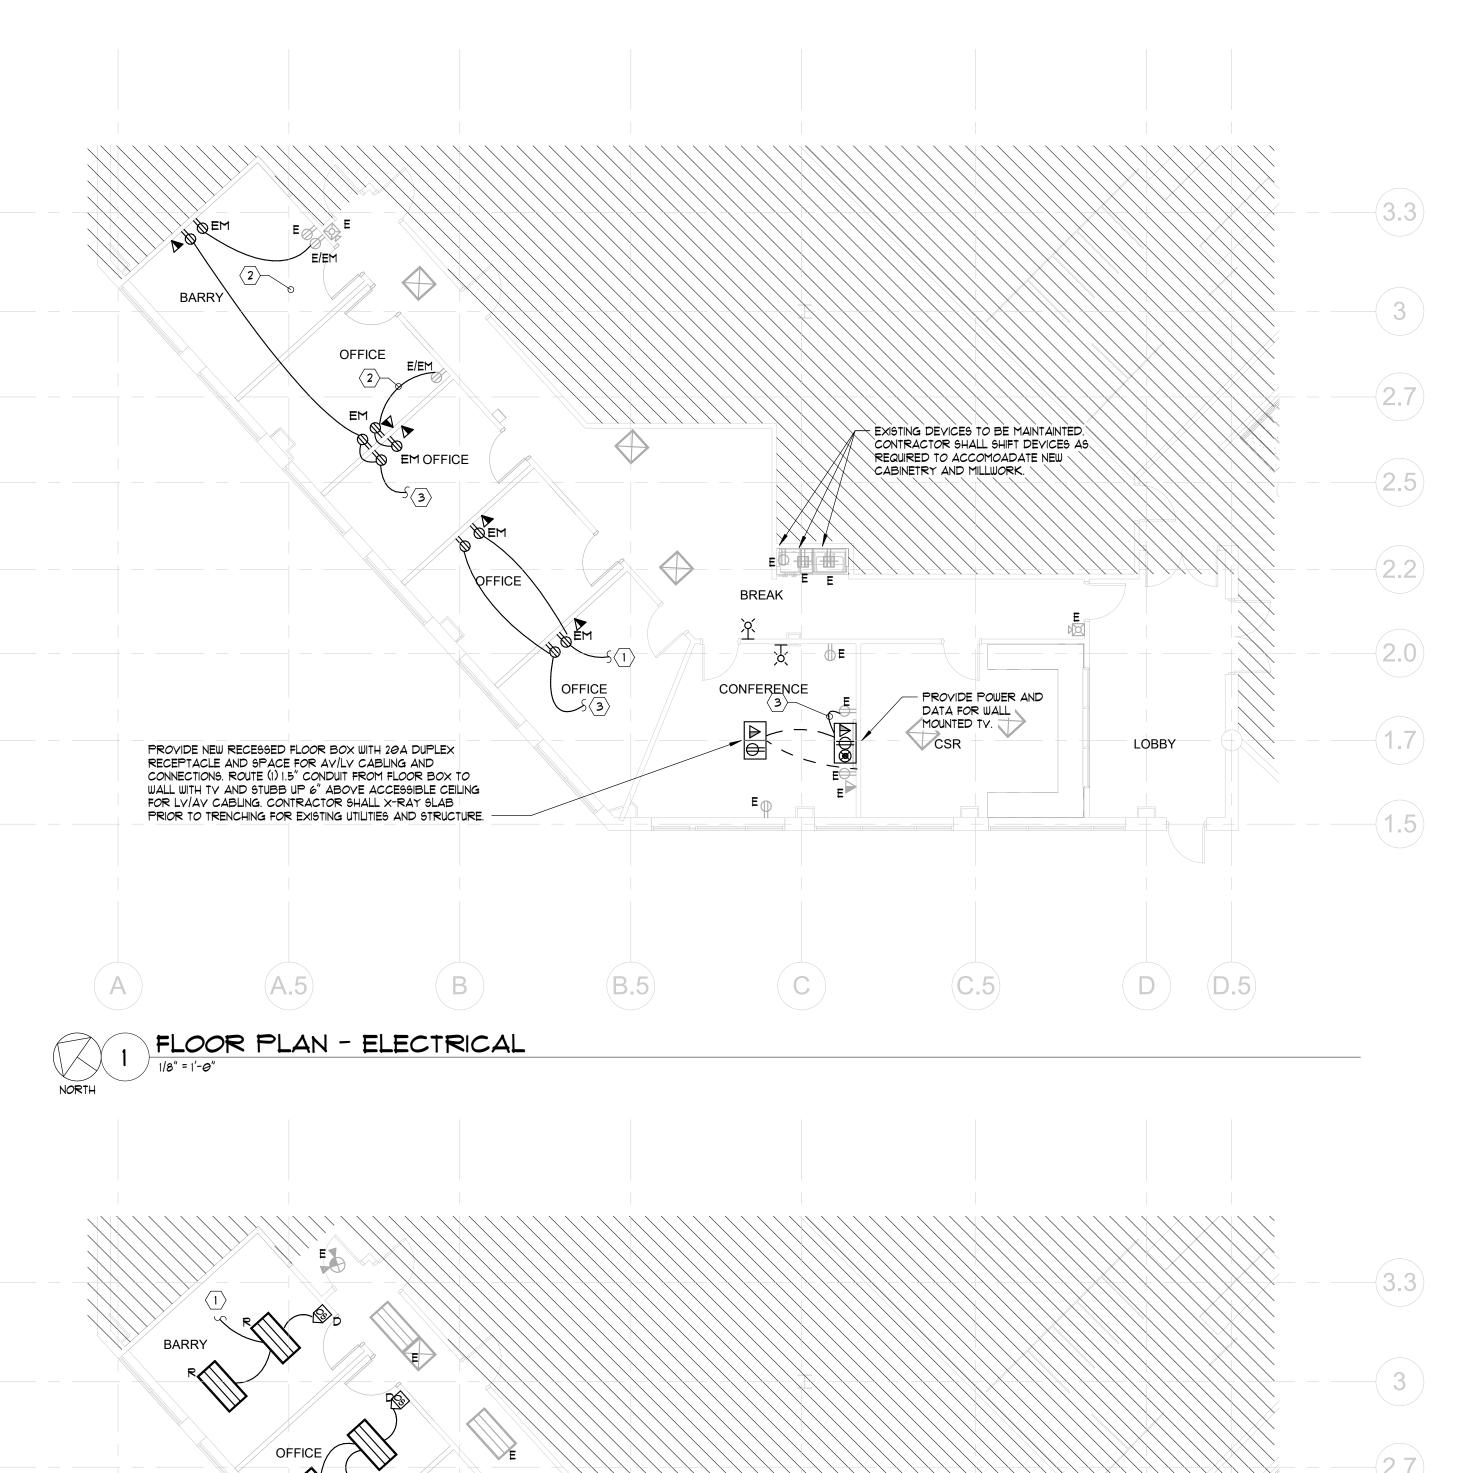

ATER

-(2.5)

-(2.0)

REPLACE EXISTING WALL SWITCH WITH NEW 0-10Y DIMMING CONTROL SWITCH. PROVIDE NEW 0-10 YOLT CONTROL WIRING FROM SWITCH TO FIXTURES IN THE ROOM FOR DIMMING CONTROL

(D.5)

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Sheet Title

FLOOR PLAN -**ELECTRICAL & LIGHTING**

Sheet No.

E-2.00

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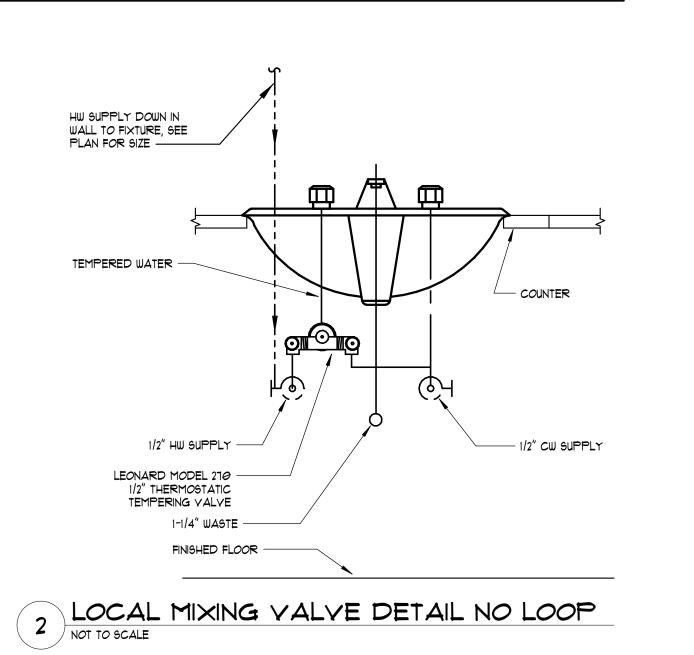
EXISTING LIGHTING FIXTURE(S) PREVIOUSLY
SERVING THE OFFICE AREA BEING RENOVATED.
ALL FIXTURES TAGGED WITH 'R' ARE EXISTING TO
BE RELOCATED TO NEW LOCAITON SHOWN.

FLOOR PLAN - LIGHTING

		F	PLUMBIN	IG FIXT	URE SC	HEDULE
TAG	FIXTURE	cw	HW	WASTE	VENT	SPECIFICATION
<u>9K-1</u>	BREAK SINK	1/2"	1/2"	2"	1-1/2"	ELKAY STAINLESS STEEL SINK ELUHAD211550 UNDERMOUNT STAINLESS STEEL SINK, 4-7/8" DEPTH, MOEN 8792 DECK MTD. FAUCET (2.0 GPM), W/ 4" CENTERS AND SPRAYER. PROVIDE P-TRAP, TAILPIECE, INSULATION KIT AND WATER STOPS. PROVIDE WITH ADA COMPLIANT INSTALLATION.

DEMOLISH EXISTING FAUCET AND SINK. EXISTING PLUMBING PIPING TO REMAIN FOR RECONNECTION IN NEW SCOPE OF WORK. NEW SK-I TO BE INSTALLED AND RECONNECTED TO ALL UTILITES.

KEY NOTES:




SYMBOLS	ABBRY.	<u>DESCRIPTION</u>					
	5 <i>O</i> R W	SANITARY OR WASTE PIPING BELOW FLOOR OR GRADE					
	5 OR W	SANITARY OR WASTE ABOVE GROUND					
	٧	VENT PIPING					
	CW	DOMESTIC COLD WATER					
	HW	DOMESTIC HOT WATER					
	HWR	HOT WATER RECIRCULATE					
	G	NATURAL GAS PIPING					
	VTR	SANITARY VENT THROUGH ROOF					
0							
X	FD	FLOOR DRAIN					
	HD	HUB DRAIN					
-I	co	CLEANOUT					
- <i>-</i> ⊚	FC0	FLOOR CLEANOUT					
Θ	WCO	WALL CLEANOUT					
	NFWH	NON FREEZE WALL HYDRANT					
—16⊢—	BY	BALL VALVE					
	CV	CHECK VALVE					
—⊗—	ВС	BALANCING COCK OR VALVE					
⊗	WHA	WATER HAMMER ARRESTOR (P.D.I SIZE)					
	BFP	BACKFLOW PREVENTER ASSEMBLY					
	RPZ	REDUCED PRESSURE ZONE (BFP)					
<u> </u>	PRV	PRESSURE REDUCING VALVE					
<u> </u>	T \$ P	TEMPERATURE AND PRESSUER RELIEF VALVE					
<u> </u>	TP	TRAP PRIMER					
<u> </u>		PRESSURE GAUGE WITH GAUGE COCK					
		THERMOMETER					
<u>—</u> —[і		UNION					
		STRAINER					
	I.E.	INVERT ELEVATION					
──		DIRECTION OF FLOW IN PIPE					
/-		DIRECTION OF PITCH OF PIPE					
8		CONNECT TO EXISTING					
		REFER TO PLUMBING KEYNOTES					
~		CONTINUE TO DESIGNATED LOCATION					
	AFG	ABOVE FINISHED GRADE					
	BFF	BELOW FINISHED FLOOR					
	BFG	BELOW FINISHED GRADE					
	A/C	ABOYE CEILING					
	A/F	ABOVE FLOOR					
	B/F	BELOW FLOOR					
	B/G	BELOW GRADE					
	AFF	ABOVE FINISHED FLOOR					
	O/H	OVERHEAD					
~	J.1.1	HUB DRAIN					
—∞ ~							
<u>—</u> ∞		P-TRAP					
<u> </u>		PIPING UP					
		PIPING DOWN					
		PIPING TEE					
<u>P-1</u>		PLUMBING FIXTURE DESIGNATION					
	° F	DEGREE FAHRENHEIT					
	FT	FOOT					
	GPM	GALLONS PER MINUTE					
	RPM	REVOLUTIONS PER MINUTE					
	ENT.	ENTERING					
	LVG.	LEAVING:					
	P9I	POUNDS PER SQUARE INCH					
	PH						
		PHASE GALLONG PER LIGHT					
	GPH	GALLONS PER HOUR					
	EFF	EFFICIENCY					
	HP	HORSE POWER					
	GAL	GALLON					
	CFH	CUBIC FEET PER HOUR					
	IN	INCH					
	CD	CONDENSATE					
	PRA	PROJECTED ROOF AREA (6QUARE FEET)					

LEGEND - PLUMBING

PLUMBING NOTES:

SEE SHEET M-0.02 FOR PLUMBING GENERAL NOTES.



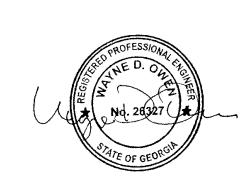



COUNTY

110 E MAIN STREET CUMMING, GA 30040

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Date		Job No.

SCHEDULE & FLOOR PLAN - PLUMBING

Sheet No.

11/04/2021

Sheet Title

P-0.01

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